PREMIER PRESCHOOL ADDITION REVISED FINAL


ALACHUA COUNTY, FLORIDA

	DEVELOPMENT INFORMATION				
1.	NAME OF PROJECT:	PREMIER PRESCHOOL ADDITION REVISED FINAL			
2.	PROJECT DESCRIPTION	CONSTRUCTION OF A BUILDING ADDITION TO EXISTING CHILD CARE CENTER WITH ASSOCIATED UTILITIES AND STORMWATER IMPROVEMENTS. THE 1ST FLOOR HAS A GROSS FLOOR AREA OF 3,900 S.F. AND THE 2ND FLOOR HAS A GROSS FLOOR AREA OF 3,754 S.F.			
3.	PROJECT ADDRESS:	10 SW 75TH STREET GAINESVILLE, FLORIDA 32607			
4.	TAX PARCEL NUMBER:	06656-057-001			
5.	SECTION/TOWNSHIP/RANGE:	SECTION 05, TOWNSHIP 10 SOUTH, RANGE 19 EAST			
6.	ZONING:	BUSINESS PROFESSIONAL (BP)			
7.	FUTURE LAND USE DESIGNATION:	COMMERCIAL			

		CONTACT INFORMATION
1.	PROPERTY OWNER:	INTERNATIONAL EDUCATION SOLUTIONS INC. 3016 S.W. 132nd TER. ALACHUA, FL 32618
2.	ENGINEER:	eda consultants inc. 720 S.W. 2nd AVE. SOUTH TOWER, SUITE 300 GAINESVILLE, FL 32601 (352) 373-3541 CONTACT: SERGIO REYES, P.E.
3.	PLANNER:	eda consultants inc. 720 S.W. 2nd AVE. SOUTH TOWER, SUITE 300 GAINESVILLE, FL 32601 (352) 373-3541 CONTACT: CLAY SWEGER, AICP, LEED AP
4.	SURVEYOR:	3002 SURVEYING 12207 NW 39TH AVENUE GAINESVILLE, FL 32606 (352) 535-0307 CONTACT: BRIAN E. MURPHY, PSM
5.	ARCHITECT:	DONAHUE ARCHITECTURE, INC 1202 SW 17TH STREET, SUITE 201–165 OCALA, FL 34471 (352) 867–5148 CONTACT: JOHN DONAHUE, AIA

DEVELOPMENT DATA					
DESCRIPTION CRITERIA		REQUIRED	PROVIDED		
BUFFER & SCREENING NORTH: ADJACENT PD EAST: COLLECTOR ROWEST: ADJACENT PD SOUTH: ADJACENT BP		NORTH: NONE REQUIRED EAST: 10' STREET BUFFER WEST: NONE REQUIRED SOUTH: NONE REQUIRED	NORTH: NONE PROVIDED EAST: 10' STREET BUFFER WEST: NONE PROVIDED SOUTH: NONE PROVIDED		
BUILDING SETBACKS (BP ZONING) NORTH: SIDE EAST: FRONT WEST: REAR SOUTH: SIDE		NORTH: 5' EAST: 25' WEST: 10' SOUTH: 5'	NORTH: 5' EAST: 25' WEST: 10' SOUTH: 5'		
TREE CANOPY 20% OF EXISTING CANOPY COVER SHALL REMAIN		EXISTING CANOPY COVER = 32,254 SF x 20% = 6,451 SF	EXISTING CANOPY TO REMAIN = 16,719 SF (51.84%)		
VEHICULAR PARKING LICENSED CAPACITY = 144 1 1 PER 6 PERSONS ON LICENSED CAPACITY (WITH 10% REDUCTION PER SEC 407.14)		LICENSED CAPACITY 144/6 = 24 SPACES 10% REDUCTION: 90% * 24 = 22 SPACES	22 SPACES PROVIDED ON SITE		
HANDICAP PARKING 1 TO 25 PARKING SPACES		1 HANDICAP SPACE	1 HANDICAP PARKING SPACE PROVIDED ONSITE		
BICYCLE PARKING 1 SPACE /10 VEHICULAR PARKING SPACES		22/10 = 2 SPACES	2 SPACES 1 U-RACK		

BUILDING INFORMATION					
BUILDING HEIGHT:	28'				
SPRINKLERED:	NO				
OCCUPANCY CLASS:	EDUCATIONAL				
OCCUPANCY TYPE:	Е				
NUMBER OF STORIES:	2				
GROSS FLOOR AREA:					
1ST FLOOR	3,900 S.F.				
2ND FLOOR	3,754 S.F.				
TOTAL GROSS FLOOR AREA:	7,654 S.F.				

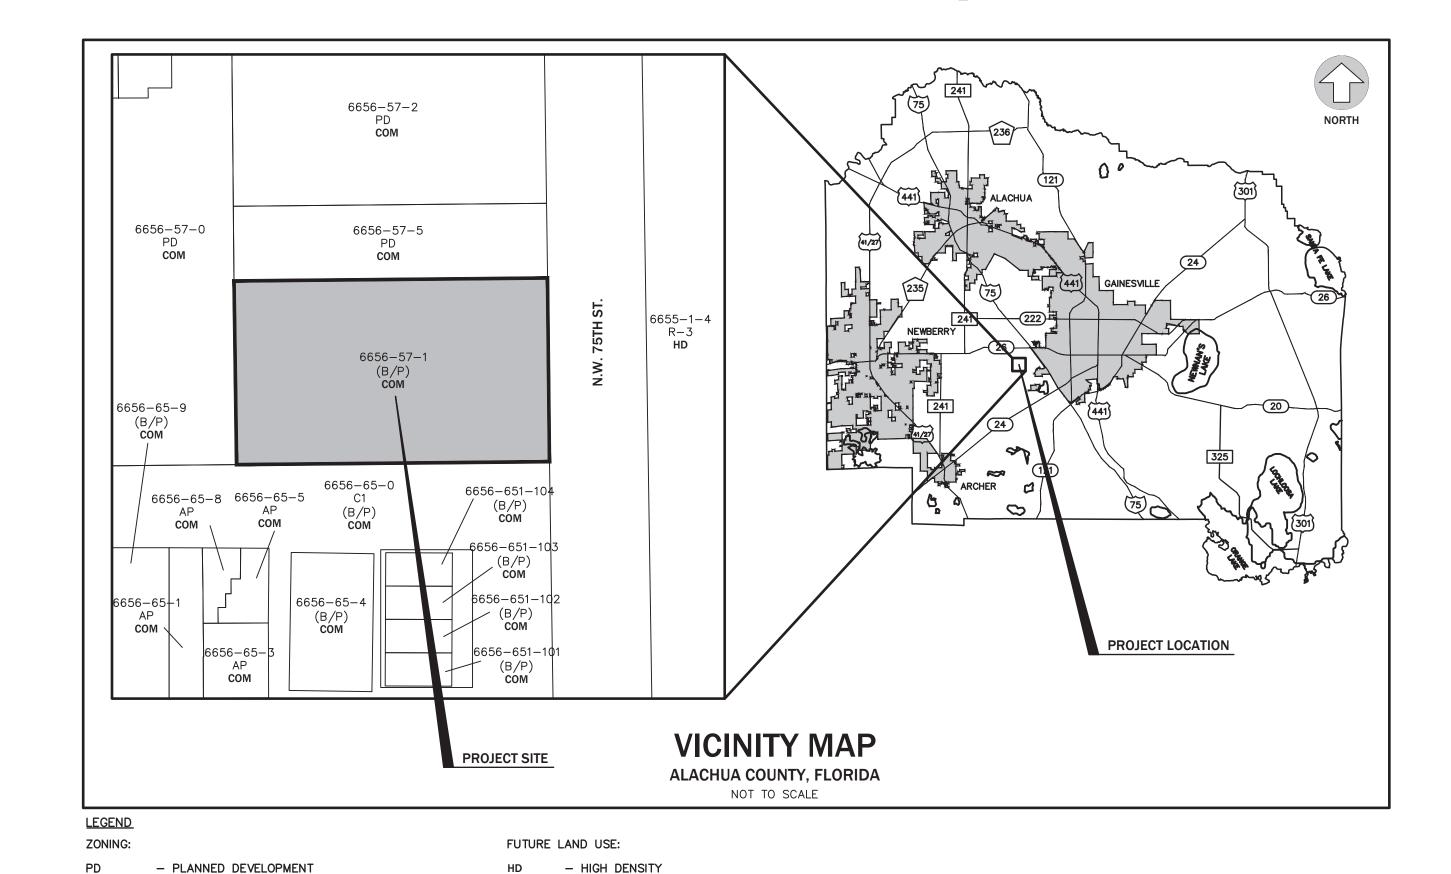

	TRIP GENERATION							
,								
	ITE LAND USE: 565 - DAY CARE CENTER							
	PROPOSED: PRESCHOOL 7,654 S.F.							
		TRIP DIS	TRBUTION	PROJECT	ED TRIPS			
	PERIOD	TDIDC	ENTED	EVIT	INI	OUT		

COMMERCIAL

- RESIDENTIAL MULTI-FAMILY

- ADMINISTRATIVE PROFESSIONAL

- BUSINESS/PROFESSIONAL

CONSERVATION

				TRIP DIS	TRBUTION	PROJECT	ED TRIPS
PERIOD	RATE	PER UNIT	TRIPS	ENTER	EXIT	IN	OUT
АМ	11.00	7.65	84.19	53%	47%	44.62	39.57
РМ	11.12	7.65	85.11	47%	53%	40.00	45.11
AVG	47.62	7.65	364.48	50%	50%	182.24	182.24
AVG 47.62 7.65 364.48 50% 50% 182.20 SOURCE: ITE TRIP GENERATION, 11TH EDITION					182.24		

	IMPERVIOUS AREA CALCULATIONS						
#	DESCRIPTION	SQUARE FOOTAGE (S.F.)	ACREAGE (AC.)	PERCENTAGE (%)			
1.	TOTAL SITE AREA:	43,735 S.F.	1.00 AC.				
2.	PROPOSED BUILDING:	3,900 S.F.	0.09 AC.	8.92%			
3.	EXISTING BUILDING COVERAGE:	4,840 S.F.	0.11 AC.	11.07%			
4.	PROPOSED PAVEMENT AND SIDEWALK AREA:	4,648 S.F.	0.11 AC.	10.63%			
5.	EXISTING PAVEMENT AND SIDEWALK AREA:	7,847 S.F.	0.18 AC.	17.94%			
6.	PROPOSED TOTAL IMPERVIOUS AREA:	21,235 S.F.	0.49 AC.	48.55%			
7.	OPEN AREA:	22,500 S.F.	0.52 AC.	51.45%			

LEGAL DESCRIPTION

CHILD CARE CENTERS NOTES

404.31 CHILD CARE CENTERS

STANDARDS FOR ALL ADULT OR CHILD CARE CENTERS.

(2) VEHICLE CIRCULATION. IN ADDITION TO THE REQUIREMENTS OF CHAPTER 402, ARTICLE II, AN APPLICANT FOR A CHILD CARE CENTER SHALL PROVIDE A VEHICULAR CIRCULATION PLAN SHOWING ONSITE QUEUING AND CIRCULATION BASED UPON THE LOCATION AND NUMBER OF PATRONS THAT UTILIZE THE FACILITY.

RESPONSE: THE SITE PROVIDES THE REQUIRED AMOUNT OF EXISTING SHADE TREES TO MEET THIS REQUIREMENT.

RESPONSE: THE FACILITY IS NOT LOCATED ABUTTING AND RESIDENTIAL PROPERTIES AND THEREFORE, IS NOT APPLICABLE.

RESPONSE: THE FACILITY OPERATES WITHIN THE REQUIRED HOURS OF OPERATION.

(7) PARKING. PARKING AREAS FOR ADULT OR CHILD CARE CENTERS THAT ARE LOCATED WITHIN THE SINGLE FAMILY RESIDENTIAL DISTRICTS SHALL BE LOCATED TO THE SIDE OR REAR OF THE PRINCIPAL BUILDING. PARKING AREAS FOR CHILD CARE CENTERS LOCATED WITHIN TRADITIONAL NEIGHBORHOOD OR TODS MUST MEET ALL REQUIREMENTS OF CHAPTER 407, ARTICLE VII, TRADITIONAL NEIGHBORHOOD AND TODS.

RESPONSE: THE FACILITY IS NOT LOCATED IN A RESIDENTIAL DISTRICT OR A TND/TOD AND THEREFORE, IS NOT APPLICABLE.

	UTILITIES TO BE PROVIDED AND PROVIDER				
1.	ELECTRIC:	GAINESVILLE REGIONAL UTILITIES (GRU)			
2.	NATURAL GAS:	GAINESVILLE REGIONAL UTILITIES (GRU)			
3.	POTABLE WATER:	GAINESVILLE REGIONAL UTILITIES (GRU)			
4.	WASTE WATER:	GAINESVILLE REGIONAL UTILITIES (GRU)			
5.	CABLE:	COX COMMUNICATIONS			
6.	TELEPHONE:	BELLSOUTH			
7.	FIRE SUPPRESSION WATER SUPPLY:	GAINESVILLE REGIONAL UTILITIES (GRU)			
8.	HIGH SPEED INTERNET:	COX COMMUNICATIONS OR BELLSOUTH OR GRU			

DRAWING INDEX				
SHEET NUMBER SHEET TITLE				
C100	COVER SHEET			
C110	LEGEND, SYMBOLS AND NOTES			
C120	TREE CANOPY PLAN			
C130 DEMOLITION AND EROSION CONTROL PLAN				
C200 DIMENSION PLAN				
C300	PAVING, GRADING AND DRAINAGE PLAN			
C305	PAVING, GRADING, AND DRAINAGE DESIGN DETAILS			
C310	BASIN DETAILS			
C320	RAINTANK DETAILS			
C330	STORMWATER POLLUTION PREVENSION PLAN			
C400	UTILITY PLAN			
L-SERIES	LANDSCAPE PLAN (BY OTHERS)			
	SURVEY (BY OTHERS)			



EB 2389 720 S.W. 2nd Ave, South Tower, Suite 300 GAINESVILLE, FLORIDA 32601 TEL. (352) 373-3541 www.edafl.com permitting@edafl.com

No.	Date	Comment

THIS ITEM HAS BEEN DIGITALLY SIGNED AND SEALED BY CLAUDIA S. VEGA, P.E. ON THE DATE ADJACENT TO THE SEAL. PRINTED COPIES OF THIS DOCUMENT ARE NOT CONSIDERED

ON ANY ELECTRONIC COPIES. Professional Engineer of Record by Claudia Vega, P.E.

DN: cn=Claudia Vega, P.E., o, ou, email=cvega@edaf l.com, c=US Date: 2023.11.22

16:32:23 -05'00' Claudia S. Vega, P.E. 51532 Certificate No.

2021-0162

Project phase:

REVISED FINAL Project title:


PREMIER PRESCHOOL addition revised final ALACHUA COUNTY,

FLORIDA

Sheet title:

COVER SHEET

Designed:	QH	Sheet No.:
Drawn: LB(D/NJG	
Checked:	CSV	
Date: 11/2	22/23	

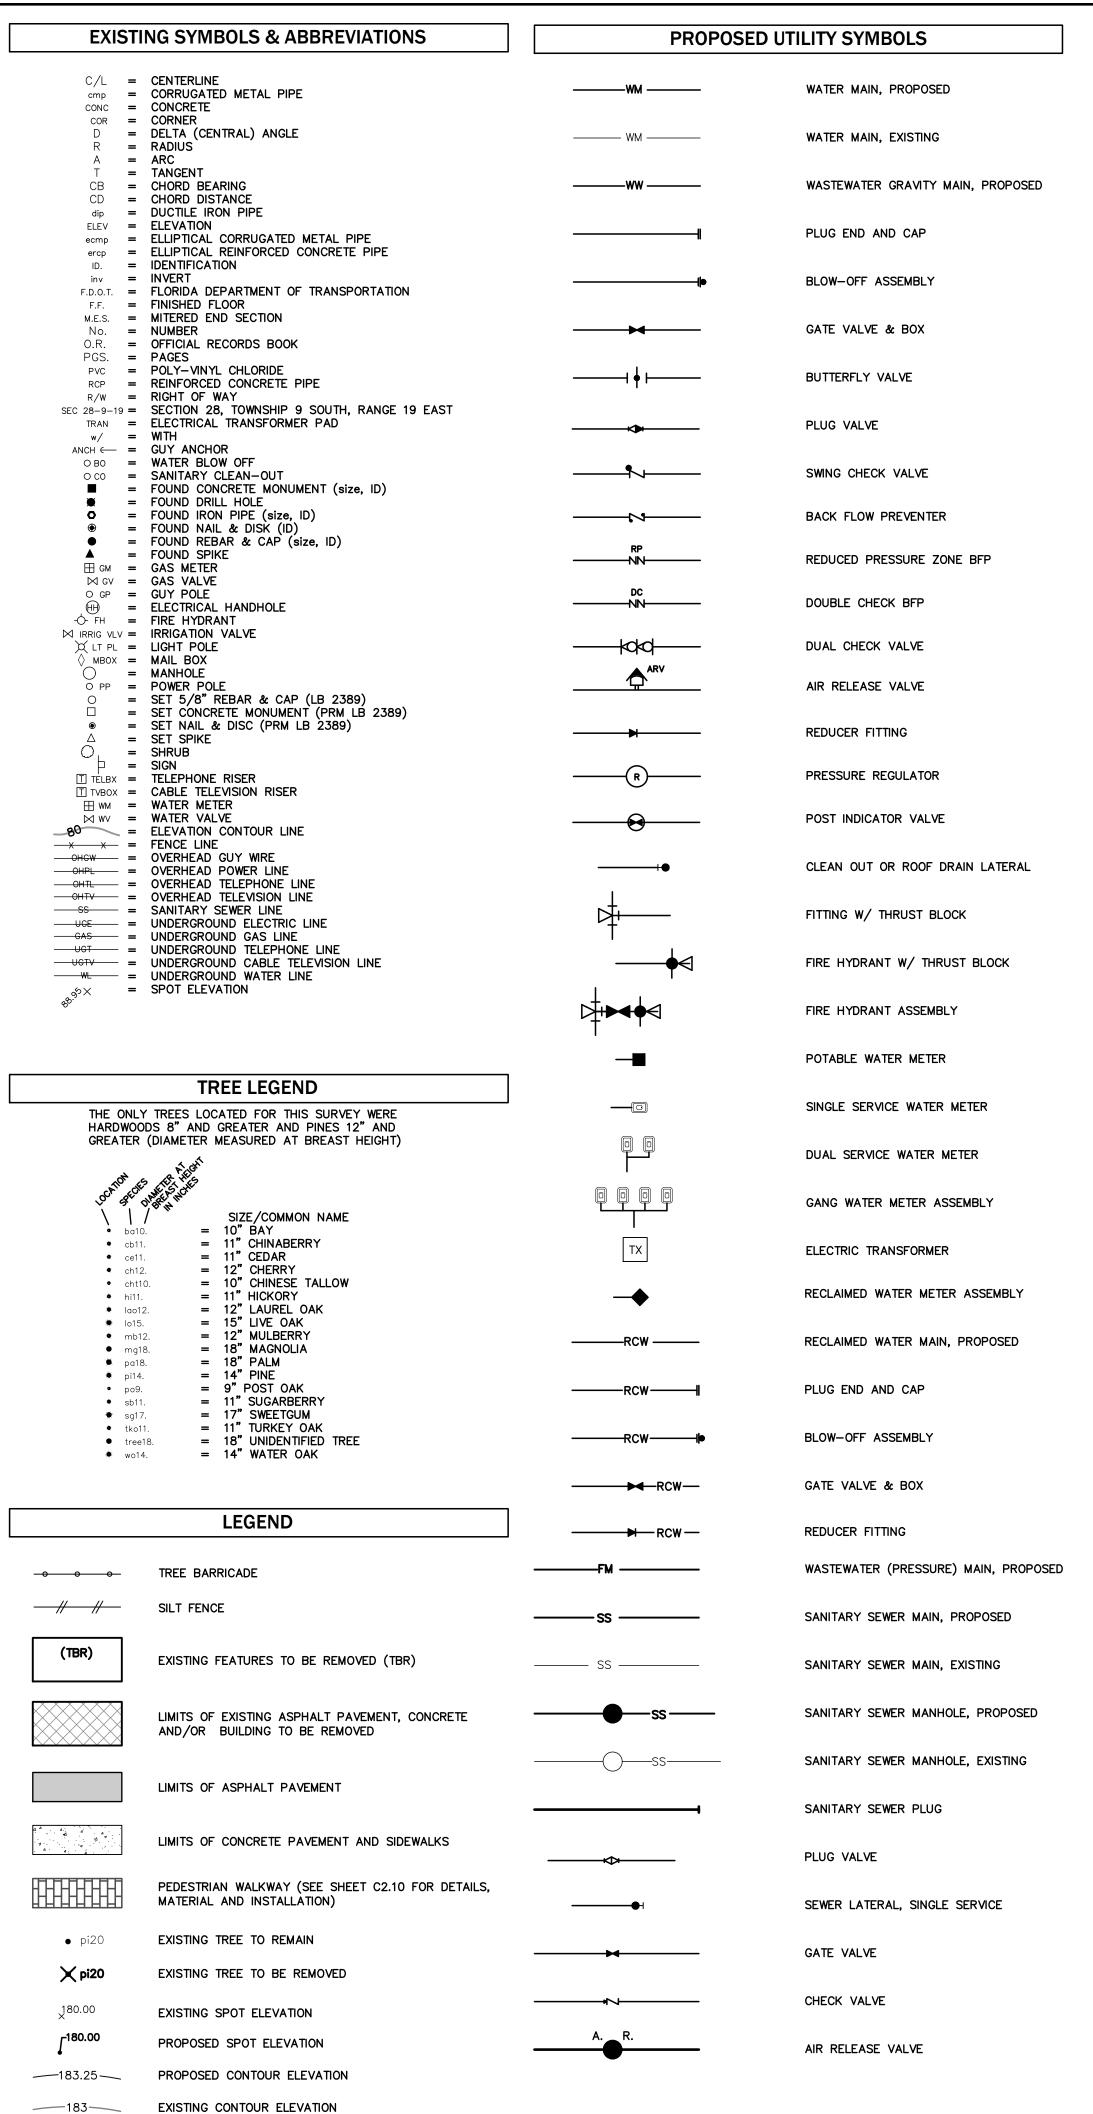

GENERAL NOTES

- 1. LOCATIONS, ELEVATIONS, AND DIMENSIONS OF EXISTING UTILITIES, STRUCTURES AND OTHER FEATURES ARE SHOWN ACCORDING TO THE BEST INFORMATION AVAILABLE AT THE TIME OF PREPARATION OF THESE PLANS. THE CONTRACTOR SHALL VERIFY THE LOCATIONS. ELEVATIONS, AND DIMENSIONS OF ALL EXISTING UTILITIES, STRUCTURES AND OTHER FEATURES, AFFECTING THIS WORK, PRIOR TO
- 2. PRIOR TO THE INITIATION OF SITE CONSTRUCTION, THE CONTRACTOR SHALL VERIFY ANY EXISTING UTILITIES INCLUDING GAS, WATER, ELECTRIC, CABLE TV. COMMUNICATIONS, SANITARY SEWERS AND STORM DRAINAGE SYSTEMS, ON AND/OR ADJACENT TO THE SITE. REMOVE OR CAP AS NECESSARY. CONTACT ENGINEER OF RECORD IMMEDIATELY WITH ANY DISCREPANCIES.
- 3. THE CONTRACTOR IS RESPONSIBLE FOR REPAIRING ANY DAMAGE TO EXISTING FACILITIES, ABOVE OR BELOW GROUND, THAT MAY OCCUR AS A RESULT OF THE WORK PERFORMED, BY THE CONTRACTOR OR SUB-CONTRACTORS, AS CALLED FOR IN THESE CONTRACT DOCUMENTS.
- 4. CONTRACTOR TO COORDINATE WITH UTILITY COMPANIES FOR THE RELOCATION OF EXISTING UTILITIES. UTILITIES NEEDING TO BE REMOVED OR RELOCATED SHALL BE COORDINATED WITH THE AFFECTED UTILITY COMPANY. ADEQUATE TIME SHALL BE PROVIDED FOR RELOCATION, AND CLOSE COORDINATION WITH THE UTILITY COMPANY IS NECESSARY TO PROVIDE A SMOOTH TRANSITION IN UTILITY SERVICE. THE CONTRACTOR SHALL COORDINATE WITH THE UTILITY COMPANY CONCERNING PORTIONS OF THE WORK WHICH MAY BE PERFORMED BY THE UTILITY COMPANY'S FORCES AND ANY FEES WHICH ARE TO BE PAID TO THE UTILITY COMPANY FOR THEIR SERVICES. THE CONTRACTOR IS RESPONSIBLE FOR PAYING ALL FEES AND
- 5. IT IS THE CONTRACTOR'S RESPONSIBILITY TO BECOME FAMILIAR WITH THE PERMIT AND INSPECTION REQUIREMENTS SPECIFIED BY THE VARIOUS GOVERNMENTAL AGENCIES AND THE ENGINEER. THE CONTRACTOR SHALL OBTAIN ALL NECESSARY PERMITS PRIOR TO CONSTRUCTION, AND SCHEDULE INSPECTIONS ACCORDING TO AGENCY INSTRUCTION/REQUIREMENTS.
- 6. THE CONTRACTOR SHALL SUBMIT SHOP DRAWINGS, ON ALL PRECAST AND MANUFACTURED ITEMS, TO THE OWNER'S ENGINEER FOR REVIEW. FAILURE TO OBTAIN APPROVAL BEFORE INSTALLATION MAY RESULT IN REMOVAL AND REPLACEMENT AT THE CONTRACTOR'S EXPENSE.
- A. DURING THE CONSTRUCTION AND/OR MAINTENANCE OF THIS PROJECT, ALL SAFETY REGULATIONS ARE TO BE ENFORCED. THE CONTRACTOR OR HIS REPRESENTATIVE SHALL BE RESPONSIBLE FOR THE CONTROL AND SAFETY OF THE TRAVELING PUBLIC AND THE SAFETY OF HIS/HER PERSONNEL.
- B. LABOR SAFETY REGULATIONS SHALL CONFORM TO THE PROVISIONS SET FORTH C. THE MINIMUM STANDARDS AS SET FORTH IN THE CURRENT EDITION OF "THE
- STATE OF FLORIDA, MANUAL ON TRAFFIC CONTROL AND SAFE PRACTICES FOR STREET AND HIGHWAY CONSTRUCTION, MAINTENANCE AND UTILITY OPERATIONS' SHALL BE FOLLOWED IN THE DESIGN, APPLICATION, INSTALLATION, MAINTENANCE AND REMOVAL OF ALL TRAFFIC CONTROL DEVICES, WARNING DEVICES AND BARRIERS NECESSARY TO PROTECT THE PUBLIC AND CONSTRUCTION PERSONNEL FROM HAZARDS WITHIN THE PROJECT LIMITS.
- ALL TRAFFIC CONTROL MARKINGS AND DEVICES SHALL CONFORM TO THE PROVISIONS SET FORTH IN THE MANUAL ON UNIFORM TRAFFIC CONTROL DEVICES PREPARED BY THE U.S. DEPARTMENT OF TRANSPORTATION FEDERAL HIGHWAY ADMINISTRATION.
- E. ALL SUBSURFACE CONSTRUCTION SHALL COMPLY WITH THE "TRENCH SAFETY ACT". THE CONTRACTOR SHALL INSURE THAT THE METHOD OF TRENCH PROTECTION AND CONSTRUCTION IS IN COMPLIANCE WITH THE OCCUPATIONAL
- SAFETY AND HEALTH ADMINISTRATION (OSHA) REGULATIONS. F. IT SHALL BE THE SOLE RESPONSIBILITY OF THE CONTRACTOR TO COMPLY AND ENFORCE ALL APPLICABLE SAFETY REGULATIONS. THE ABOVE INFORMATION HAS BEEN PROVIDED FOR THE CONTRACTOR'S INFORMATION ONLY AND DOES NOT IMPLY THAT THE OWNER OR ENGINEER WILL INSPECT AND/OR ENFORCE SAFETY
- 8. ALL UNDERGROUND UTILITIES MUST BE IN-PLACE, TESTED AND INSPECTED PRIOR TO BASE AND SURFACE CONSTRUCTION.
- 9. CONTRACTOR IS REQUIRED TO SECURE A FLORIDA DEPARTMENT OF ENVIRONMENTAL PROTECTION (FDEP) "NATIONAL POLLUTANT DISCHARGE ELIMINATION SYSTEM" (NPDES) PERMIT BEFORE BEGINNING CONSTRUCTION.
- 10. A COMPLETE SET OF PERMITTED DRAWINGS AND SPECIFICATIONS MUST BE MAINTAINED ON SITE AT ALL TIMES THAT THE CONTRACTOR IS PERFORMING WORK. THESE DRAWINGS SHALL BE MADE AVAILABLE UPON REQUEST.
- 11. ALL EROSION AND SEDIMENT CONTROL DEVICES SHALL BE CONSTRUCTED SIMULTANEOUSLY WITH THE DISTURBANCE OF THE LAND AND SHALL REMAIN FUNCTIONAL UNTIL THE CONTRIBUTING DISTURBED AREAS ARE STABILIZED. SILT BARRIERS WILL BE INSTALLED AS NECESSARY TO PREVENT EXCESSIVE SEDIMENTATION OF DOWNSTREAM AREAS.
- 12. COUNTY: ALL WORK WITHIN OR ON COUNTY OWNED AND MAINTAINED FACILITIES, ROW OR EASEMENTS WILL REQUIRE AS-BUILT PLANS. AS-BUILT PLANS SHOULD SHOW THE CONSTRUCTED CONDITIONS OF THE COUNTY OWNED OR MAINTAINED AREA AND BE PERFORMED BY A FLORIDA LICENSED PROFESSIONAL SURVEYOR AND MAPPER. COORDINATE SYSTEM SHALL BE FLORIDA STATE PLANE COORDINATES, NAD 83 ZONE NORTH US SURVEY FEET. VERTICAL COORDINATES SHALL BE REFERENCED TO THE NAVD 88 DATUM WITH ELEVATIONS GIVEN IN US SURVEY FEET.
- 13. THE CONTRACTOR SHALL CONSTRUCT GRAVITY SEWER LATERALS, MANHOLES GRAVITY SEWER LINES AND DOMESTIC WATER AND FIRE PROTECTION SYSTEM AS SHOWN ON THESE PLANS. THE CONTRACTOR SHALL FURNISH ALL NECESSARY MATERIALS, EQUIPMENT, MACHINERY, TOOLS, MEANS OF TRANSPORTATION AND LABOR NECESSARY TO COMPLETE THE WORK IN FULL AND COMPLETE ACCORDANCE WITH THE SHOWN, DESCRIBED AND REASONABLY INTENDED REQUIREMENTS OF THE CONTRACT DOCUMENTS AND JURISDICTIONAL AGENCY REQUIREMENTS. IN THE EVENT THAT THE CONTRACT DOCUMENTS AND THE JURISDICTIONAL AGENCY REQUIREMENTS ARE NOT IN AGREEMENT, THE MOST STRINGENT SHALL GOVERN.

DEMOLITION NOTES

- 1. ALL MATERIAL REMOVED FROM THIS SITE BY THE CONTRACTOR SHALL BE DISPOSED OF BY THE CONTRACTOR IN A LEGAL MANNER.
- 2. REFER TO THE TOPOGRAPHIC SURVEY FOR ADDITIONAL DETAILS OF EXISTING STRUCTURES, ETC., LOCATED WITHIN THE PROJECT SITE. UNLESS OTHERWISE NOTED, ALL EXISTING BUILDINGS, STRUCTURES, SLABS, CONCRETE, ASPHALT, DEBRIS PILES, SIGNS, AND ALL APPURTENANCES ARE TO BE REMOVED FROM THE SITE BY THE CONTRACTOR AND PROPERLY DISPOSED OF IN A LEGAL MANNER AS PART OF THIS CONTRACT. SOME ITEMS TO BE REMOVED MAY NOT BE DEPICTED ON THE TOPOGRAPHIC SURVEY. IT IS THE CONTRACTOR'S RESPONSIBILITY TO VISIT THE SITE AND DETERMINE THE FULL EXTENT OF ITEMS TO BE REMOVED. IF ANY ITEMS ARE IN QUESTION, THE CONTRACTOR SHALL CONTACT THE OWNER PRIOR TO REMOVAL OF SAID ITEMS.
- 3. THE CONTRACTOR SHALL REFER TO THE DEMOLITION PLAN FOR DEMOLITION / PRESERVATION OF EXISTING TREES. ALL TREES NOT SPECIFICALLY SHOWN TO BE PRESERVED OR RELOCATED SHALL BE REMOVED AS A PART OF THIS CONTRACT. TREE PROTECTION FENCING SHALL BE INSTALLED PRIOR TO ANY DEMOLITION.
- 4. CONTRACTOR SHALL SUBMIT DEMOLITION SCHEDULE TO OWNER PRIOR TO PROCEEDING WITH DEMOLITION ACTIVITIES.
- CONDUCT SITE DEMOLITION OPERATIONS TO ENSURE MINIMUM INTERFERENCE WITH ROADS, STREETS, WALKS, AND OTHER ADJACENT OCCUPIED OR USED FACILITIES. DO NOT CLOSE OR OBSTRUCT STREETS, WALKS, OR OTHER OCCUPIED OR USED FACILITIES WITHOUT PERMISSION FROM AUTHORITIES HAVING JURISDICTION. CLOSURE OF THESE FACILITIES MAY REQUIRE A MAINTENANCE OF TRAFFIC PLAN PREPARED BY A REGISTERED PROFESSIONAL AT THE CONTRACTORS EXPENSE.
- 6. PROVIDE PROTECTION AS NECESSARY TO PREVENT DAMAGE TO EXISTING IMPROVEMENTS SHOWN IN THE PLANS TO REMAIN.
- 7. LOCATE EXISTING ABOVE GROUND AND UNDERGROUND UTILITIES IN AREAS OF WORK. IF UTILITIES ARE TO REMAIN IN PLACE, PROVIDE ADEQUATE MEANS OF SUPPORT AND PROTECTION DURING DEMOLITION AND CONSTRUCTION OPERATIONS.
- 8. CONTRACTOR SHALL COORDINATE WITH APPLICABLE UTILITY COMPANIES FOR THE TERMINATION, CAPPING-OFF AND REMOVAL OF ALL EXISTING UNDERGROUND AND ABOVE GROUND UTILITY SERVICES UNLESS DIRECTED TO OTHERWISE.
- CALL 811 BEFORE DIGGING AND LOCATE AND PROTECT GRU GAS FACILITIES. MAINTAIN A MINIMUM COVER OF 36" OVER GRU GAS MAIN DURING ALL PHASES OF DEMOLITION AND CONSTRUCTION.
- 10. PLEASE INDICATE VIA PROJECT DOX IF THE CUSTOMER DESIRES G.R.U. GAS SERVICE FOR THIS PROJECT, AS WELL AS CONTACTING G.R.U. GAS MARKETING AT 352.393.1467 AS SOON AS POSSIBLE.

CONSTRUCTION NOTES

- 1. SIGNS AND BARRICADES SHALL BE IN ACCORDANCE WITH THE U.S. DEPARTMENT OF TRANSPORTATION'S "MANUAL OF UNIFORM TRAFFIC CONTROL DEVICES", AND THE FLORIDA DEPARTMENT OF TRANSPORTATION'S 'ROADWAY AND TRAFFIC DESIGN STANDARDS"INDEXES 600 THROUGH 685 (LATEST EDITIONS).
- 2. SAFE PEDESTRIAN TRAFFIC IS TO BE MAINTAINED AT ALL TIMES.
- 3. ANY SIDEWALK WHICH BECOMES UNDERMINED MUST BE REMOVED AND REPLACED. SIDEWALKS ARE TO BE RECONSTRUCTED WITHIN THREE (3) DAYS AFTER REMOVAL. WHEN EXISTING SIDEWALK IS REMOVED, IT IS TO BE REMOVED TO THE NEAREST
- 4. DISTURBED AREA WITHIN THE R-O-W WILL BE COMPACTED TO 98% OF MAXIMUM DENSITY AND SODDED.
- 5. STOCKPILING OF MATERIAL IS NOT ALLOWED ON ROADWAYS OR SIDEWALKS. ALL DIRT AND DEBRIS WILL BE REMOVED FROM JOB SITE DAILY. ROADS AND SIDEWALKS ARE TO BE SWEPT DAILY AS PART OF DAILY CLEANUP.
- 6. ANY PORTION OF ROADWAYS OR SIDEWALKS THAT SUSTAIN EXCESSIVE CONSTRUCTION RELATED DAMAGE, IN THE OPINION OF APPLICABLE AGENCIES, SHALL BE REPAIRED AT CONTRACTOR EXPENSE IN A MANNER SPECIFIED BY THAT
- CONSTRUCTION MUST BE PER THE APPROVED SITE PLAN OF THE DRC (OR EQUIVALENT). DEVIATIONS IN ROADWAY, UTILITY OR DRAINAGE CONSTRUCTION WILL REQUIRE PRIOR WRITTEN APPROVAL OF THE CITY ENGINEER OR THE DIRECTOR OF PUBLIC SERVICES (OR EQUIVALENT). NOTE: SIGNIFICANT CHANGES FROM THE DRC APPROVED PLAN MAY REQUIRE THE OWNER/DEVELOPER TO SUBMIT A REVISED SITE PLAN FOR REVIEW THROUGH THE DRC AND MAY CAUSE PROJECT DELAYS.
- 8. OFF-SITE OR ROADWAY R-O-W CONSTRUCTION SHALL BE IN ACCORDANCE WITH ALL CONDITIONS OF THE APPROVED R-O-W PERMIT(S). A COPY OF THE APPROVED R-O-W PERMIT MUST BE KEPT ON-SITE AND READILY AVAILABLE DURING ALL CONSTRUCTION ACTIVITIES WITHIN THE R-O-W.
- 9. DURING THE CONSTRUCTION AND/OR MAINTENANCE OF THIS PROJECT, ALL SAFETY REGULATIONS ARE TO BE ENFORCED. THE CONTRACTOR OR HIS REPRESENTATIVE SHALL BE RESPONSIBLE FOR THE CONTROL AND SAFETY OF THE TRAVELING PUBLIC AND THE SAFETY OF HIS/HER PERSONNEL.
- 10. ALL CONSTRUCTION, MATERIALS AND WORKMANSHIP ARE TO BE IN ACCORDANCE WITH FLORIDA DEPARTMENT OF TRANSPORTATION SPECIFICATIONS AND STANDARDS.
- 11. CONTRACTOR IS RESPONSIBLE FOR CHECKING ACTUAL SITE CONDITIONS BEFORE STARTING CONSTRUCTION.
- 12. ANY DISCREPANCIES ON THE DRAWINGS SHALL BE BROUGHT TO THE ATTENTION OF THE ENGINEER BEFORE COMMENCING WORK.
- 13. THE CONTRACTOR SHALL BE RESPONSIBLE FOR OBTAINING ALL REQUIRED CONSTRUCTION PERMITS AND BONDS IF REQUIRED PRIOR TO CONSTRUCTION.
- 14. THE CONTRACTOR SHALL BE RESPONSIBLE FOR SUBMITTING TO THE ENGINEER A CERTIFIED RECORD SURVEY SIGNED AND SEALED BY A PROFESSIONAL LAND SURVEYOR REGISTERED IN THE STATE OF FLORIDA DEPICTING THE ACTUAL FIELD LOCATION OF ALL CONSTRUCTED IMPROVEMENTS THAT ARE REQUIRED BY THE JURISDICTIONAL AGENCIES FOR THE CERTIFICATION PROCESS. ALL SURVEY COSTS WILL BE THE CONTRACTORS RESPONSIBILITY. BOTH PAPER AND AUTOCAD FILES
- 15. THE CONTRACTOR SHALL BE RESPONSIBLE FOR DOCUMENTING AND MAINTAINING AS-BUILT INFORMATION WHICH SHALL BE RECORDED AS CONSTRUCTION PROGRESSES OR AT THE COMPLETION OF APPROPRIATE CONSTRUCTION INTERVALS AND SHALL BE RESPONSIBLE FOR PROVIDING AS-BUILT DRAWINGS TO THE OWNER AND ENGINEER OF RECORD FOR THE PURPOSE OF CERTIFICATION TO JURISDICTIONAL AGENCIES AS REQUIRED. BOTH PAPER AND AUTOCAD SHALL BE PROVIDED.

EROSION CONTROL NOTES

- THE STORM WATER POLLUTION PREVENTION PLAN (SWPPP) IS COMPRISED OF THE EROSION CONTROL PLAN. THE STANDARD DETAILS. THE PLAN NARRATIVE. ATTACHMENTS REFERENCED BY THE SWPPP, PLUS THE PERMIT AND ALL SUBSEQUENT REPORTS AND RELATED DOCUMENTS.
- 2. ALL CONTRACTORS AND SUBCONTRACTORS INVOLVED WITH STORM WATER POLLUTION PREVENTION SHALL OBTAIN A COPY OF THE STORM WATER POLLUTION PREVENTION PLAN AND THE STATE OF FLORIDA NATIONAL POLLUTANT DISCHARGE ELIMINATION SYSTEM GENERAL PERMIT (NPDES PERMIT) AND BECOME FAMILIAR WITH
- THE CONTRACTOR SHALL IMPLEMENT BEST MANAGEMENT PRACTICES AS REQUIRED BY THE SWPPP. ADDITIONAL BEST MANAGEMENT PRACTICES SHALL BE IMPLEMENTED AS DICTATED BY CONDITIONS AT NO ADDITIONAL COST TO THE OWNER THROUGHOUT ALL PHASES OF CONSTRUCTION.
- PERMITS FOR ANY CONSTRUCTION ACTIVITY IMPACTING STATE WATERS OR REGULATED WETLANDS MUST BE MAINTAINED ON SITE AT ALL TIMES.
- 5. ALL WASH WATER (CONCRETE TRUCKS, VEHICLE CLEANING, EQUIPMENT CLEANING, ETC.) SHALL BE DETAINED AND PROPERLY TREATED OR DISPOSED.
- SUFFICIENT OIL AND GREASE ABSORBING MATERIALS AND FLOTATION BOOMS SHALL BE MAINTAINED ON SITE OR READILY AVAILABLE TO CONTAIN AND CLEAN-UP FUEL OR CHEMICAL SPILLS AND LEAKS.
- THE CONTRACTOR SHALL BE RESPONSIBLE FOR DUST CONTROL ON SITE. THE USE OF MOTOR OILS AND OTHER PETROLEUM BASED OR TOXIC LIQUIDS FOR DUST SUPPRESSION OPERATIONS IS PROHIBITED.
- RUBBISH, TRASH, GARBAGE, LITTER, OR OTHER SUCH MATERIALS SHALL BE DEPOSITED INTO SEALED CONTAINERS. MATERIALS SHALL BE PREVENTED FROM
- LEAVING THE PREMISES THROUGH THE ACTION OF WIND OR STORM WATER RUNOFF 9. ALL STORM WATER POLLUTION PREVENTION MEASURES PRESENTED ON THE PLAN
- SHALL BE INITIATED AS SOON AS PRACTICABLE. DISTURBED PORTIONS OF THE SITE WHERE CONSTRUCTION ACTIVITY HAS PERMANENTLY STOPPED SHALL BE PERMANENTLY SEEDED. THESE AREAS SHALL BE
- SEEDED NO LATER THAN 7 DAYS AFTER THE LAST CONSTRUCTION ACTIVITY OCCURRED IN THESE AREAS.
- THE CONTRACTOR SHALL BE RESPONSIBLE FOR REMOVING SEDIMENT IN THE DETENTION POND AND ANY SEDIMENT THAT MAY HAVE COLLECTED IN THE STORM DRAINS IN CONJUNCTION WITH THE STABILIZATION OF THE SITE.
- 12. ON-SITE & OFF SITE SOIL STOCKPILE AND BORROW AREAS SHALL BE PROTECTED FROM EROSION AND SEDIMENTATION THROUGH IMPLEMENTATION OF BEST MANAGEMENT PRACTICES. STOCKPILE AND BORROW AREA LOCATIONS SHALL BE NOTED ON THE EROSION CONTROL PLAN BY THE CONTRACTOR AND PERMITTED IN ACCORDANCE WITH GENERAL PERMIT REQUIREMENTS.
- 13. THE CONTRACTOR SHALL BE RESPONSIBLE FOR ADJUSTING THE EROSION CONTROL MEASURES (SILT FENCES, STABILIZATION, SEDIMENT BASINS, ETC.) AS NEEDED FOR EACH STAGE OF SITE WORK / GRADING.
- 14. NO GRADING, CUTTING, OR FILLING SHALL COMMENCE UNTIL SUCH TIME AS APPROPRIATE EROSION AND SEDIMENTATION CONTROL DEVICES HAVE BEEN INSTALLED BETWEEN ALL DISTURBED AREAS AND WATER BODIES, WATERCOURSES OR WETLANDS AND ANY CONVEYANCES SUCH AS DRAINAGE DITCHES, STORM DRAINS, AND INLETS.
- 15. ALL EROSION AND SEDIMENT CONTROL DEVICES SHALL BE INSTALLED PRECEDING ANY DISTURBANCE OF THE LAND AND SHALL REMAIN FUNCTIONAL UNTIL THE CONTRIBUTING DISTURBED AREAS ARE STABILIZED. THE CONTRACTOR SHALL INSTALL ALL EROSION AND PREVENTION STRUCTURES SHOWN ON THE PLANS AT A MINIMUM AND IN FULL CONFORMANCE WITH ALL APPLICABLE WATER MANAGEMENT DISTRICT PERMITS AND REGULATIONS.
- 16. ALL CONTROL STRUCTURE AND OUTFALL CULVERT INSTALLATIONS SHALL BE PROTECTED WITH SEDIMENT BARRIERS AT A MINIMUM.
- 17. ALL DISTURBED AREAS (ABOVE NORMAL WATER LEVELS) UNLESS OTHERWISE NOTED HEREIN, SHALL BE SEEDED AND MULCHED WITHIN 7 DAYS OF FINAL GRADING. UNLESS OTHERWISE NOTED, ALL SLOPES STEEPER THAN 4:1 SHALL BE SODDED.

PAVING. GRADING. AND DRAINAGE NOTES

- TRAFFIC CONTROL ON ALL FDOT, LOCAL AND COUNTY RIGHTS-OF-WAY SHALL MEET THE REQUIREMENTS OF THE MANUAL OF UNIFORM TRAFFIC CONTROL DEVICES (U.S. DOT/FHA) AND THE REQUIREMENTS OF THE STATE AND ANY LOCAL AGENCY HAVING JURISDICTION. IN THE EVENT THAT THE CONTRACT DOCUMENTS AND THE JURISDICTIONAL AGENCY REQUIREMENTS ARE NOT IN AGREEMENT, THE MOST STRINGENT SHALL GOVERN.
- 2. ALL OPEN AREAS WITHIN THE PROJECT SITE SHALL BE SODDED UNLESS INDICATED OTHERWISE ON THE
- 3. THE CONTRACTOR SHALL INSTALL FILTER FABRIC OVER ALL DRAINAGE STRUCTURES FOR THE DURATION OF CONSTRUCTION AND UNTIL ACCEPTANCE OF THE PROJECT BY THE OWNER. ALL DRAINAGE STRUCTURES SHALL BE CLEANED OF DEBRIS AS REQUIRED DURING AND AT THE END OF CONSTRUCTION TO PROVIDE POSITIVE
- 4. IF DEWATERING IS REQUIRED, THE CONTRACTOR SHALL OBTAIN ANY APPLICABLE REQUIRED PERMITS. THE CONTRACTOR IS TO COORDINATE WITH THE OWNER AND THE DESIGN ENGINEER PRIOR TO ANY EXCAVATION.

THE CONTRACTOR MUST REVIEW AND MAINTAIN A COPY OF THE ENVIRONMENTAL RESOURCE PERMIT COMPLETE

- WITH ALL CONDITIONS, ATTACHMENTS, EXHIBITS, AND PERMIT MODIFICATIONS IN GOOD CONDITION AT THE CONSTRUCTION SITE. THE COMPLETE PERMIT MUST BE AVAILABLE FOR REVIEW UPON REQUEST BY WATER MANAGEMENT DISTRICT REPRESENTATIVES.
- THE CONTRACTOR SHALL ENSURE THAT ISLAND PLANTING AREAS AND OTHER PLANTING AREAS ARE NOT COMPACTED AND DO NOT CONTAIN ROAD BASE MATERIALS. THE CONTRACTOR SHALL ALSO EXCAVATE AND REMOVE ALL UNDESIRABLE MATERIAL FROM ALL AREAS ON THE SITE TO BE PLANTED AND PROPERLY DISPOSED OF IN A LEGAL MANNER.
- THE CONTRACTOR SHALL BE RESPONSIBLE FOR PROTECTING EXCAVATIONS AGAINST COLLAPSE AND WILL PROVIDE BRACING, SHEETING OR SHORING AS NECESSARY. DE-WATERING METHODS SHALL BE USED AS REQUIRED TO KEEP TRENCHES DRY WHILE PIPE AND APPURTENANCES ARE BEING PLACED.
- 8. THE CONTRACTOR WILL STABILIZE BY SEED AND MULCH, SOD, OR OTHER APPROVED MATERIALS ANY DISTURBED AREAS WITHIN ONE WEEK FOLLOWING CONSTRUCTION OF THE UTILITY SYSTEMS AND PAVEMENT AREAS. CONTRACTOR SHALL MAINTAIN SUCH AREAS UNTIL FINAL ACCEPTANCE BY OWNER. CONTRACTOR TO COORDINATE WITH OWNER REGARDING TYPE OF MATERIAL, LANDSCAPING AND IRRIGATION IMPROVEMENTS TO
- 9. SITE GRADING, PAVING AND DRAINAGE MATERIALS AND CONSTRUCTION SHALL CONFORM TO FDOT STANDARD SPECIFICATIONS FOR ROAD AND BRIDGE CONSTRUCTION.
- 10. IMMEDIATELY AT ONSET OF CONSTRUCTION, CONTRACTOR SHALL FIELD VERIFY HORIZONTAL AND VERTICAL LOCATIONS OF ALL EXISTING UTILITIES CRITICAL TO COMPLETING THE PROJECT (INCLUDING WATER, SEWER, POWER, TELEPHONE, GAS, AND CABLE TV) AND SHALL EVALUATE POTENTIAL CONFLICTS. ALL SUCH CONFLICTS SHALL BE REPORTED TO ENGINEER/OWNER IMMEDIATELY UPON DISCOVERY.
- 11. PRIOR TO CONSTRUCTION, CONTRACTOR SHALL FIELD STAKE AND ROPE OFF CONSERVATION AREA LINES. OWNER RESERVES THE RIGHTS TO CHECK THE STAKING AND ROPING AND REQUIRE IT TO BE RELOCATED IF NECESSARY. IT SHALL REMAIN IN PLACE UNTIL ADJACENT CONSTRUCTION IS COMPLETE.
- 12. CONTRACTOR SHALL BE EXTREMELY CAUTIOUS WHEN WORKING NEAR TREES WHICH ARE TO BE SAVED, WHETHER SHOWN IN THE PLANS OR DESIGNATED IN THE FIELD.
- 13. ALL SIGNAGE, PAVEMENT MARKING AND TRAFFIC CONTROL DEVICES SHALL BE IN ACCORDANCE WITH FDOT "ROADWAY AND TRAFFIC DESIGN STANDARDS" AND FHWA "MANUAL OF UNIFORM TRAFFIC CONTROL DEVICES".
- 14. REGULATORY SIGNS (STOP, ETC.) SHALL BE PAID FOR BY THE CONTRACTOR AND IN PLACE PRIOR TO FINAL INSPECTION OF PAVING AND DRÁINAGE IMPROVEMENTS.
- 15. BLUE REFLECTIVE PAVEMENT MARKERS SHALL BE PLACED OPPOSITE FIRE HYDRANTS IN THE CENTER OF THE NEAREST TRAVELED LANE TO MARK THEIR LOCATIONS.
- 16. CONTRACTOR IS RESPONSIBLE FOR GRADING ALL PAVEMENTS TO DRAIN POSITIVELY. INTERSECTIONS SHALL BE TRANSITIONED TO PROVIDE SMOOTH DRIVING SURFACE WHILE MAINTAINING POSITIVE DRAINAGE. SHOULD AREAS OF POOR DRAINAGE BE OBSERVED, CONTRACTOR SHALL NOTIFY THE ENGINEER PRIOR TO PLACEMENT OF CURBS OR PAVEMENT COURSES, SO THAT RECOMMENDATIONS FOR CORRECTION MAY BE MADE.
- 17. PROPOSED AND EXISTING SIDEWALKS SHALL BE RAMPED FLUSH WITH PAVEMENT. RAMPS SHALL NOT EXCEED SLOPES OF 12 HORIZONTAL TO 1 VERTICAL.
- 18. FINISHED FLOOR ELEVATIONS ARE MINIMUM ELEVATIONS REQUIRED TO SATISFY DRAINAGE AND/OR 100-FLOODPLAIN REQUIREMENTS. PAD ELEVATIONS, IMMEDIATELY OUTSIDE OF BUILDING WALLS, SHALL BE NO MORE THAN 8 INCHES BELOW THE FINISHED FLOOR ELEVATIONS SHOWN.
- 19. CONTRACTOR IS RESPONSIBLE FOR IDENTIFYING AND DISPOSING ALL WASTE MATERIALS CONSISTENT WITH ALL RULES AND REGULATIONS APPLICABLE TO THE SPECIFIC MATERIAL FOUND. ALL DELETERIOUS SUBSURFACE MATERIAL (I.E. MUCK, PEAT, BURIED DEBRIS, ETC.) IS TO BE EXCAVATED AND REPLACED WITH SUITABLE/COMPACTED SOILS, AS DIRECTED BY THE OWNER, THE OWNERS ENGINEERS, OR OWNERS SOILS TESTING COMPANY. DELETERIOUS MATERIAL IS TO BE STOCKPILED OR REMOVED FROM THE SITE AS DIRECTED BY THE OWNER. EXCAVATED AREAS ARE TO BE BACKFILLED WITH APPROVED MATERIALS AND COMPACTED AS SHOWN ON THESE PLANS. CONTRACTOR IS RESPONSIBLE FOR ACQUIRING ANY PERMITS THAT ARE NECESSARY FOR REMOVING DELETERIOUS MATERIAL FROM THE SITE.
- 20. ALL NECESSARY FILL AND EMBANKMENT THAT IS PLACED DURING CONSTRUCTION SHALL CONSIST OF MATERIAL SPECIFIED BY THE OWNER'S SOILS TESTING COMPANY OR ENGINEER AND BE PLACED AND COMPACTED ACCORDING TO THESE PLANS.
- 21. PROPOSED SPOT ELEVATIONS REPRESENT FINISHED PAVEMENT, SIDEWALK, OR GROUND SURFACE GRADES,
- UNLESS OTHERWISE NOTED. 22. CURBING SHALL BE PLACED AT THE EDGES OF ALL PAVEMENT, UNLESS OTHERWISE NOTED. REFER TO THE LATEST EDITION OF F.D.O.T. "ROADWAY AND TRAFFIC DESIGN STANDARDS" FOR DETAILS AND SPECIFICATIONS OF ALL FDOT TYPE CURB AND GUTTERS CALLED FOR IN THESE PLANS.
- 23. THE CONTRACTOR SHALL RESTORE OFF-SITE CONSTRUCTION AREAS TO EQUAL AND/OR BETTER CONDITION THAN EXISTING PRIOR TO START OF CONSTRUCTION.
- 24. UNLESS OTHERWISE NOTED, GRADE TO MEET EXISTING ELEVATION AT PROPERTY LINES.
- 25. SURVEY MONUMENTS OR BENCHMARKS, WHICH HAVE TO BE DISTURBED BY THIS WORK, SHALL BE REPLACED UPON COMPLETION OF WORK BY A REGISTERED LAND SURVEYOR. ALL SURVEY COSTS WILL BE CONTRACTORS
- 26. FINAL GRADES SHOWN INCLUDE SOD HEIGHT. ALL AREAS SHALL BE GRADED TO DRAIN AWAY FROM THE
- 27. IF WORK IS SUSPENDED OR DELAYED FOR 14 DAYS, THE CONTRACTOR SHALL TEMPORARILY STABILIZE THE DISTURBED AREAS AT NO ADDITIONAL COST TO THE OWNER.
- 28. STORM DRAINS SHALL BE REINFORCED CONCRETE PIPE, PER ASTM C-76 CLASS III, UNLESS OTHERWISE SPECIFIED. LIFTING HOLES ARE PROHIBITED.
- 29. ALL STORM STRUCTURES SHALL CONFORM WITH FDOT STANDARD INDEX DRAWINGS AND SPECIFICATIONS EXCEPT THAT DITCH BOTTOM INLETS IN PAVED AREAS SHALL HAVE TRAVERSABLE, TRAFFIC BEARING, GRATES SUPPORTED BY STEEL ANGLE SEATS OR SUPPORTED ON FOUR SIDES. GRATES SHALL BE CAST IRON UNLESS OTHERWISE SPECIFIED OR APPROVED.
- 30. ALL CONCRETE CURBS, SIDEWALKS, INLET TOPS, ETC. SHALL BE 3000 PSI MINIMUM, UNLESS OTHERWISE SPECIFIED.
- 31. THE CONTRACTOR IS RESPONSIBLE FOR COORDINATING APPLICABLE TESTING WITH THE SOILS ENGINEER. TESTS WILL BE REQUIRED PURSUANT WITH THE SOILS REPORT. UPON COMPLETION OF WORK THE SOILS ENGINEER WILL SUBMIT CERTIFICATIONS TO THE OWNER AND OWNER'S ENGINEER STATING THAT ALL REQUIREMENTS HAVE
- 32. A QUALIFIED TESTING LABORATORY SHALL PERFORM ALL TESTING NECESSARY TO ASSURE COMPLIANCE OF THE IN-PLACE MATERIALS AS REQUIRED BY THESE PLANS, THE VARIOUS AGENCIES AND PERMIT CONDITIONS. SHOULD ANY RETESTING BE REQUIRED DUE TO THE FAILURE OF ANY TESTS TO MEET THE REQUIREMENTS, THE CONTRACTOR WILL BEAR ALL COSTS OF SAID RETESTING
- 33. THE STORM DRAINAGE PIPING SYSTEM SHALL BE SUBJECT TO A VISUAL INSPECTION BY THE OWNER'S ENGINEER PRIOR TO THE PLACEMENT OF BACKFILL. CONTRACTOR TO NOTIFY THE ENGINEER 48 HOURS IN ADVANCE TO SCHEDULE INSPECTION.
- 34. THE CONTRACTOR SHALL MAINTAIN AND PROTECT FROM MUD, DIRT, DEBRIS, ETC. THE STORM DRAINAGE SYSTEM UNTIL FINAL ACCEPTANCE OF THE PROJECT. THE STORM SYSTEM WILL BE RE-INSPECTED BY THE OWNER'S ENGINEER PRIOR TO APPROVAL FOR CERTIFICATE OF OCCUPANCY PURPOSES. THE CONTRACTOR MAY BE REQUIRED TO RE-CLEAN PIPES AND INLETS FOR THESE PURPOSES.





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Professional Engineer of Record:

Claudia S. Vega, P.E. 51532

Engineer Certificate No. 2021-0162

roject phase: REVISED FINAL


PREMIER PRESCHOOL addition revised final ALACHUA COUNTY

Project title:

LEGEND, SYMBOLS AND NOTES

FLORIDA


QH esigned: Drawn: LBO/NJG Checked: CSV Date: 11/22/23

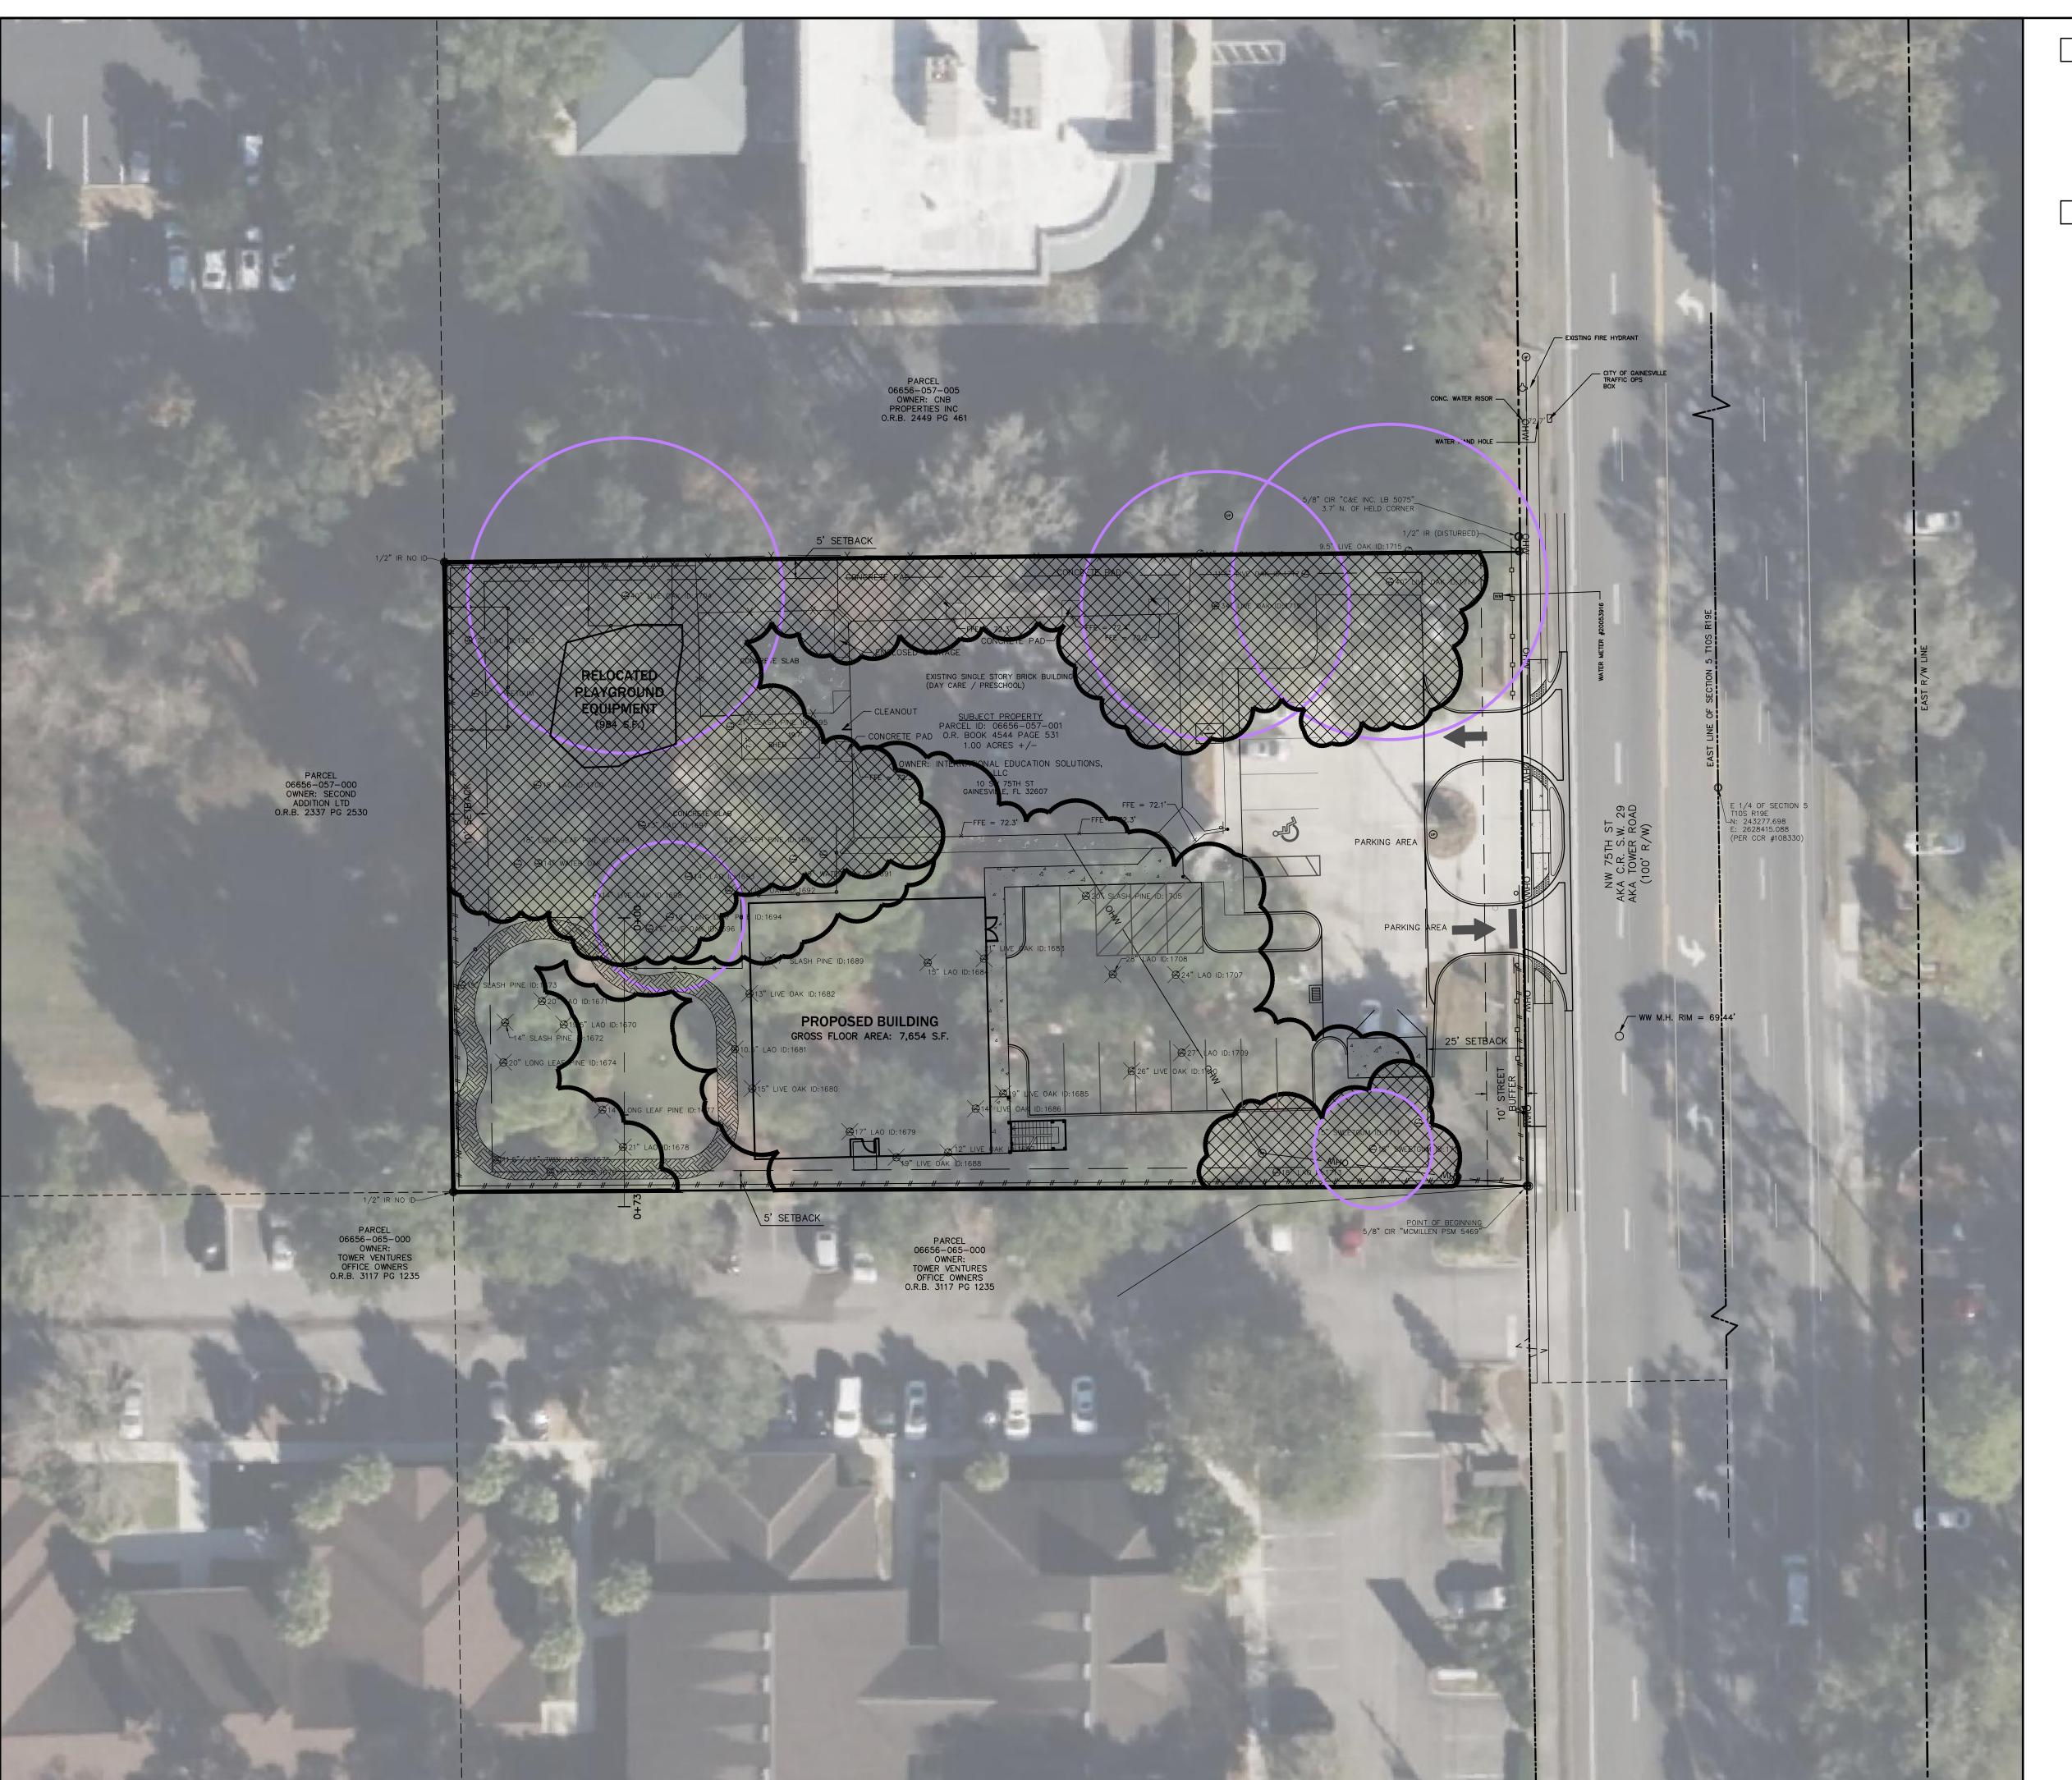

TREE CLEARING DATA

EXISTING CANOPY TOTAL: 0.74 AC. (32,254 S.F.) 100.0% EXISTING CANOPY TO REMAIN: 0.38 AC. (16,719 S.F.) 51.8%

LEGEND

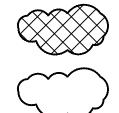

EXISTING TREE CANOPY TO REMAIN


EXISTING TREE TO REMAIN

EXISTING TREE CANOPY

DESIRABLE TREE TO REMAIN



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No.	Date	Comment
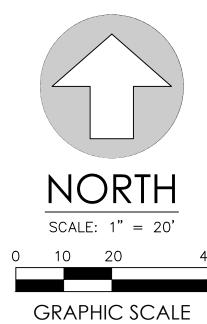
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Professional Engineer of Record:

Claudia S. Vega, P.E. ____<u>51532</u> Certificate No. Engineer

2021-0162 Project phase:

REVISED FINAL

Project title:

PREMIER PRESCHOOL ADDITION REVISED FINAL ALACHUA COUNTY, FLORIDA

Sheet title:

TREE CANOPY PLAN

Drawn: LBO/NJG

Checked: CSV Date: 11/22/23

DEMOLITION NOTES

PARCEL

06656-057-005

CONC. WATER RISOR -


E 1/4 OF SECTION 5 T10S R19E N: 243277.698 E: 2628415.088 (PER CCR #108330)

PAVING, GRADING AND DRAINAGE SPECIFICATIONS

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- B. SUBSOIL EXCAVATION: WHERE SUBSOIL EXCAVATION IS REQUIRED, UNSUITABLE MATERIALS SHALL BE REMOVED TO A DEPTH OF 18" BELOW THE LIMEROCK BASE AND BACKFILLED WITH CLEAN FILL.
- C. STABILIZED SUBGRADE: ALL STABILIZED MATERIAL SHALL BE TYPE 'B' CONFORMING TO SECTION 914-3 AND PLACED ACCORDING TO SECTION 160 IN ONE 12" MINIMUM COMPACTED LIFT. SUBGRADE SHALL BE STABILIZED TO A MINIMUM LBR VALUES AND DENSITIES AS SHOWN IN THE TYPICAL SECTIONS.
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- 12. REMOVAL OF ALL CONSTRUCTION DEBRIS, LIMEROCK, EXCESS OF BUILDERS SAND, CONCRETE AND MORTAR DEBRIS, EXISTING WEEDS AND GRASSES, AND ALL FOREIGN MATERIALS IN THE PLANTING BED AND SOD AREAS IS THE RESPONSIBILITY OF THE SITE WORK CONTRACTOR. SOIL IN AREAS TO BE LANDSCAPED SHALL BE UNCOMPACTED, SUITABLE FOR ROOT GROWTH WITH APPROPRIATE AMOUNTS OF ORGANIC MATTER, AND OF pH 5.5-6.5.
- 13. TREE BARRICADES MUST REMAIN IN PLACE AND IN THE DIMENSIONS SHOWN ON THE PLAN UNTIL LANDSCAPING BEGINS. SEE NOTE ON SHEET CO.20 AND THE DETAIL ON THE LANDSCAPE PLAN.



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GRAPHIC SCALE Date Comment
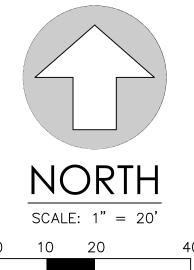
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Professional Engineer of Record:

51532 Certificate No.

2021-0162

Project title:


PREMIER PRESCHOOL **ADDITION REVISED FINAL** ALACHUA COUNTY,


Sheet title:

Date: 11/22/23

PAVING, GRADING AND DRAINAGE PLAN

QH

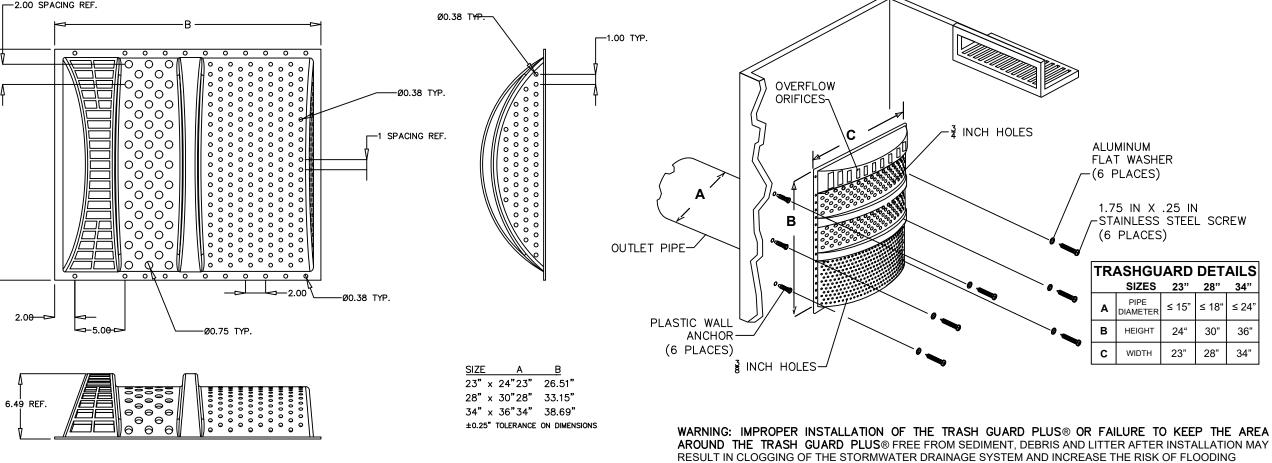

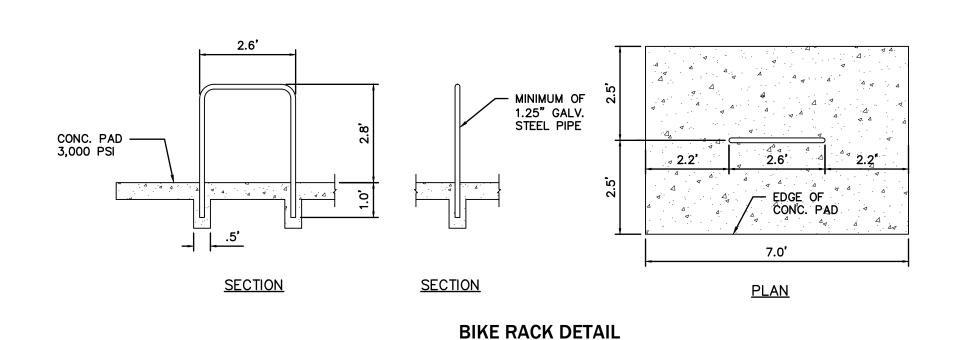

N.T.S.

DETAIL OF FLAT-BOTTOM CATCH BASIN - TRASH GUARD PLUS TO BE INSTALLED ON S-1

DURING TIMES OF HEAVY RAINFALL. IT IS IMPORTANT TO CLEAR SEDIMENT, DEBRIS AND LITTER FROM

DISTRIBUTOR WITH ANY QUESTIONS REGARDING THE INSTALLATION OR REGULAR MAINTENANCE

REQUIREMENTS OF THE TRASH GUARD PLUS®.

AROUND THE TRASH GUARD PLUS® AT LEAST FOUR (4) TIMES A YEAR AND MORE FREQUENTLY IN AREAS


WITH LARGE AMOUNTS OF VEGETATION OR LITTER. PLEASE CONTACT YOUR LOCAL TRASH GUARD PLUS®

Claudia S. Vega, P.E.

Project phase: REVISED FINAL

FLORIDA

esigned: Orawn: LBO/NJG Checked: CSV

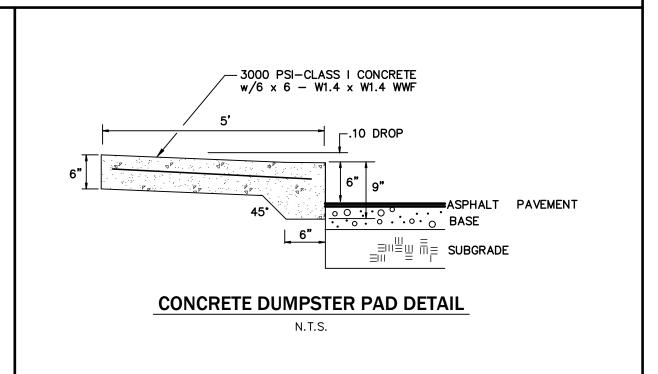

3'-4" 3'-4"

3'-4"

- LATCHING CHAIN

W/MEDIUM GRAY

6'-0" A.F.G.
T.O. WALL

8" CMU WALL

-6% STEEL POST


LINK GATE

FLOAT FINISH TOP OF WALL


W/MEDIUM GRAY VISION SLATS

3'-4"

4'-0"

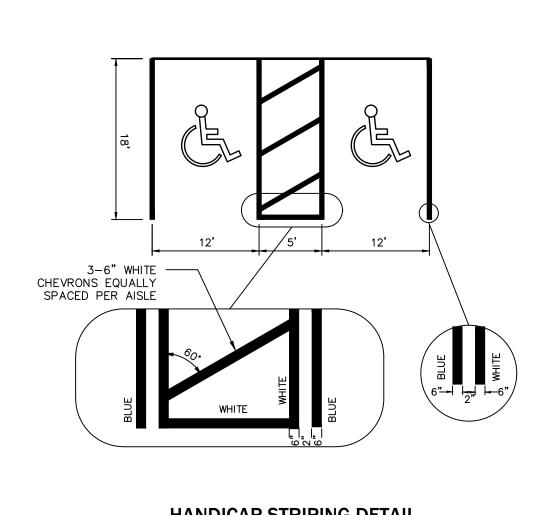

HANDICAP STRIPING DETAIL

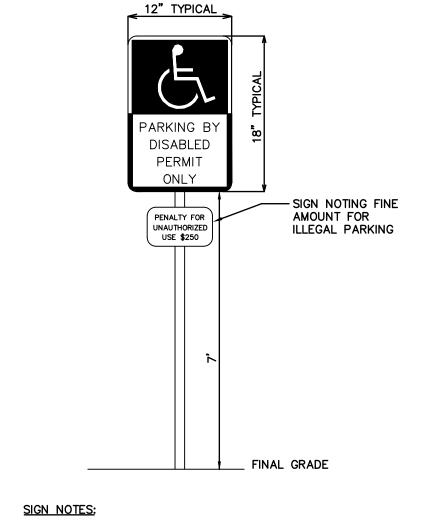

1. SIGN TO BE MADE OF 0.063" STEEL PAINTED WITH TRAFFIC PAINT 2. HANDICAP SIGN TO BE AS SHOWN ABOVE OR AS REQUIRED BY LOCAL CODE PAINT SIGN BLUE AND WHITE

HANDICAP PARKING SIGN DETAIL

N.T.S.

- 3000 PSI-CLASS I CONCRETE - 0.10 DROP (TYP. SEE GRADING PLAN) BASE SUBGRADE

6" LIMEROCK BASE, COMPACTED TO 98% OF MODIFIED PROCTOR DENSITY 12" SUBGRADE, LBR 40, COMP. TO 98% MODIFIED PROCTOR DENSITY

1-1/2" TYPE SP-9.5, ASPHALTIC CONCRETE

TYPICAL ASPHALT PAVEMENT DETAIL

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- 13. TREE BARRICADES MUST REMAIN IN PLACE AND IN THE DIMENSIONS SHOWN ON THE PLAN UNTIL LANDSCAPING BEGINS. SEE NOTE ON SHEET CO.20 AND THE DETAIL ON THE LANDSCAPE PLAN.



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> SCALES: AS SHOWN

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Professional Engineer of Record:

Claudia S. Vega, P.E. 51532 Certificate No. Engineer

2021-0162 Project phase:

REVISED FINAL Project title:


PREMIER PRESCHOOL ADDITION REVISED FINAL ALACHUA COUNTY, **FLORIDA**

Sheet title:

PAVING, GRADING, AND DRAINAGE DESIGN DETAILS


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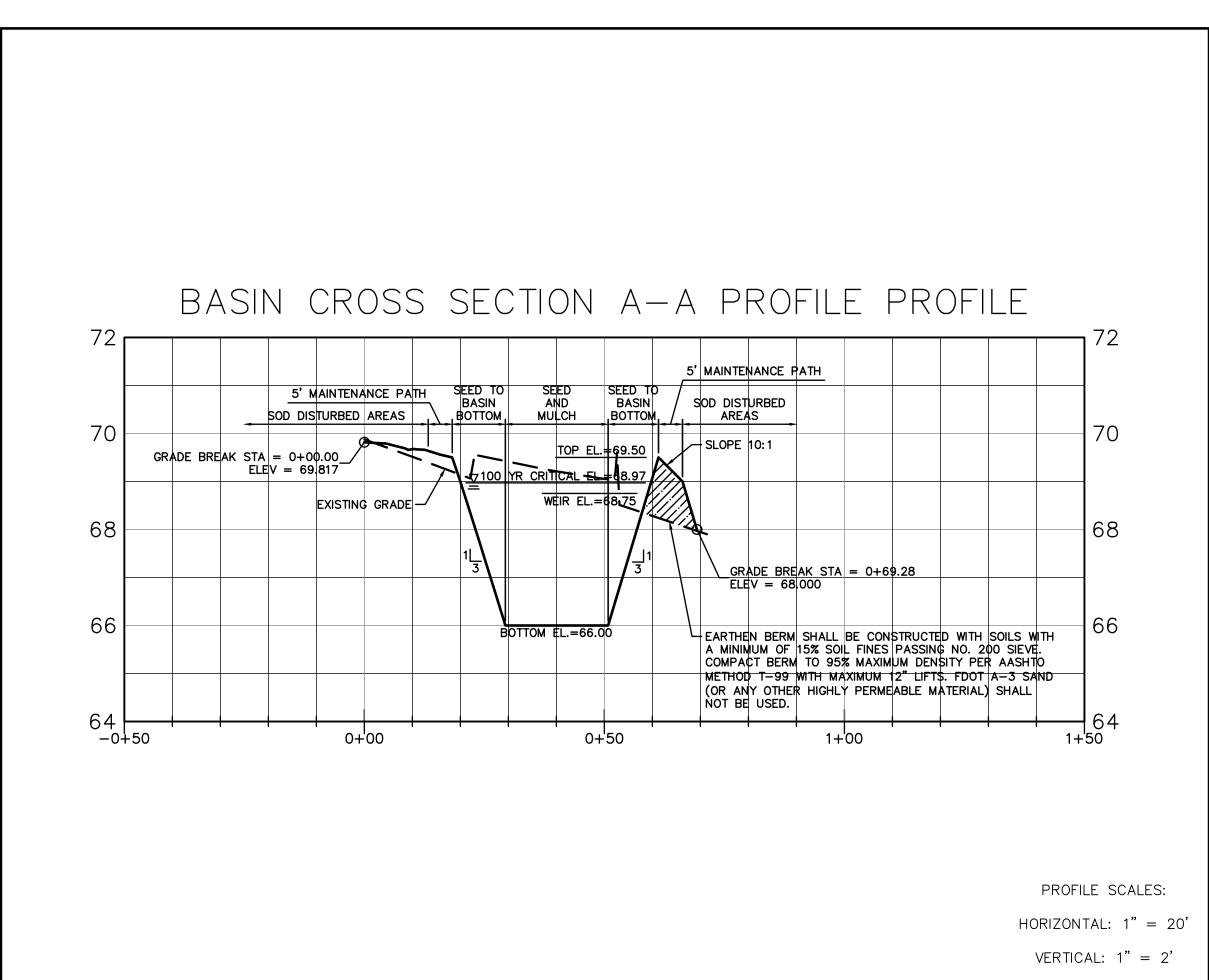
Date: 11/22/23

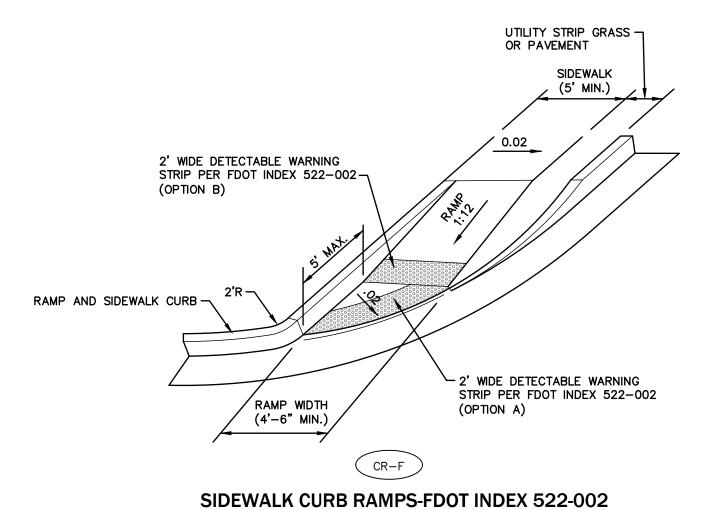


TYPICAL STEPUP SIDEWALK N.T.S.

N.T.S.



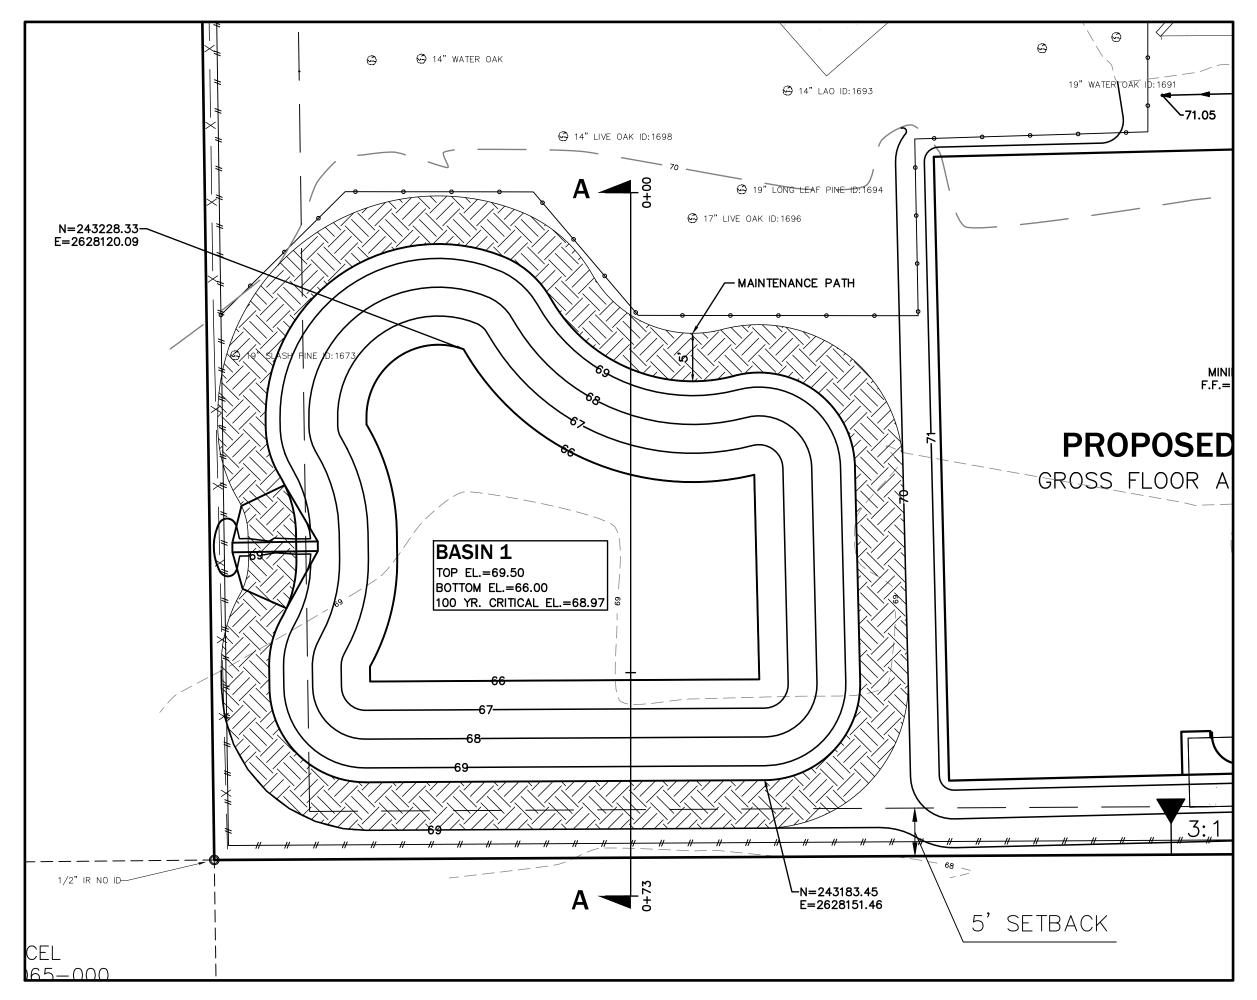

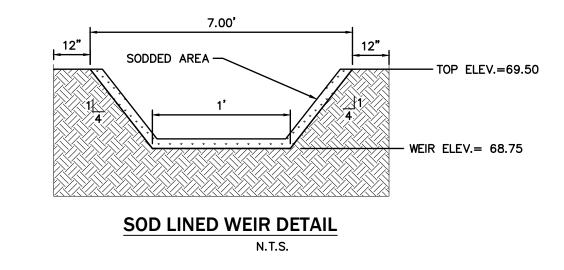

NOTE: OUTFALL WEIR SHALL BE LINED WITH ADS GEOCELL OR AN EQUAL ALTERNATIVE.

ENGINEER'S CERTIFICATION

1. ENGINEER'S CERTIFICATION:

CLAUDIA S.VEGA HEREBY CERTIFY THAT THE DESIGN OF THE STORMWATER MANAGEMENT SYSTEM FOR THE PROJECT KNOWN AS PREMIER SCHOOL MEETS ALL THE REQUIREMENTS AND HAS BEEN DESIGNED SUBSTANTIALLY IN ACCORDANCE WITH THE ALACHUA COUNTY STORMWATER MANAGEMENT ORDINANCE.

CLAUDIA S.VEGA

MAINTENANCE NOTES

1. MAINTENANCE RESPONSIBILITY:


INTERNATIONAL EDUCATION SOLUTIONS INC. WILL BE THE ENTITY RESPONSIBLE FOR THE MAINTENANCE OF THE EXISTING STORMWATER MANAGEMENT SYSTEM.

- 2. MAINTENANCE PLAN:
- A. BASINS SHALL BE MOWED REGULARLY TO AVOID EXCESSIVE VEGETATIVE GROWTH. MOWING SCHEDULE SHOULD BE MONTHLY DURING WINTER MONTHS AND MORE FREQUENTLY (BIWEEKLY) DURING SUMMER MONTHS.
- B. BASIN SHALL BE CLEANED OUT ANNUALLY OF ANY ACCUMULATED SEDIMENTATION BUILDUP. IF THE BASINS ARE SHOWING EXCESSIVE SEDIMENTATION ACCUMULATION AT THE BASIN BOTTOM, THE BASIN BOTTOM SHALL BE SCRAPED CLEAN MORE OFTEN AS THE CONDITION DICTATES.
- C. BASIN SIDE SLOPES SHALL BE MAINTAINED WITH A GOOD STAND OF GRASS. SEASONAL GRASSES SHALL BE PLANTED TO AVOID EROSION (WINTER RYE, SUMMER MILLET).
- D. BASIN THAT DO NOT DRAWDOWN PROPERLY AND MAINTAIN STANDING WATER FOR AN EXTENDED PERIOD OF TIME MAY REQUIRE REMEDIAL ACTION. THE ENGINEER SHALL BE NOTIFIED TO HELP COORDINATE REMEDIAL ACTION IN THE EVENT THIS OCCURS.
- E. THE REQUIRED LANDSCAPING SHALL BE MAINTAINED IN A SOUND CONDITION AT ALL TIMES. ANY DEAD LANDSCAPING MATERIALS SHALL BE REPLACED IMMEDIATELY TO ASSURE PUBLIC SAFETY.



consultants inc.

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Professional Engineer of Record:

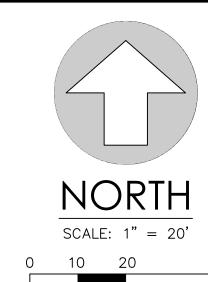Claudia S. Vega, P.E. Certificate No. Engineer

2021-0162

Project phase: REVISED FINAL

Project title:

PREMIER PRESCHOOL ADDITION REVISED FINAL ALACHUA COUNTY, FLORIDA

Sheet title:


BASIN DETAILS


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Drawn: LB(D/NJG	
Checked:	CSV	
Date: 11/2	22/23	


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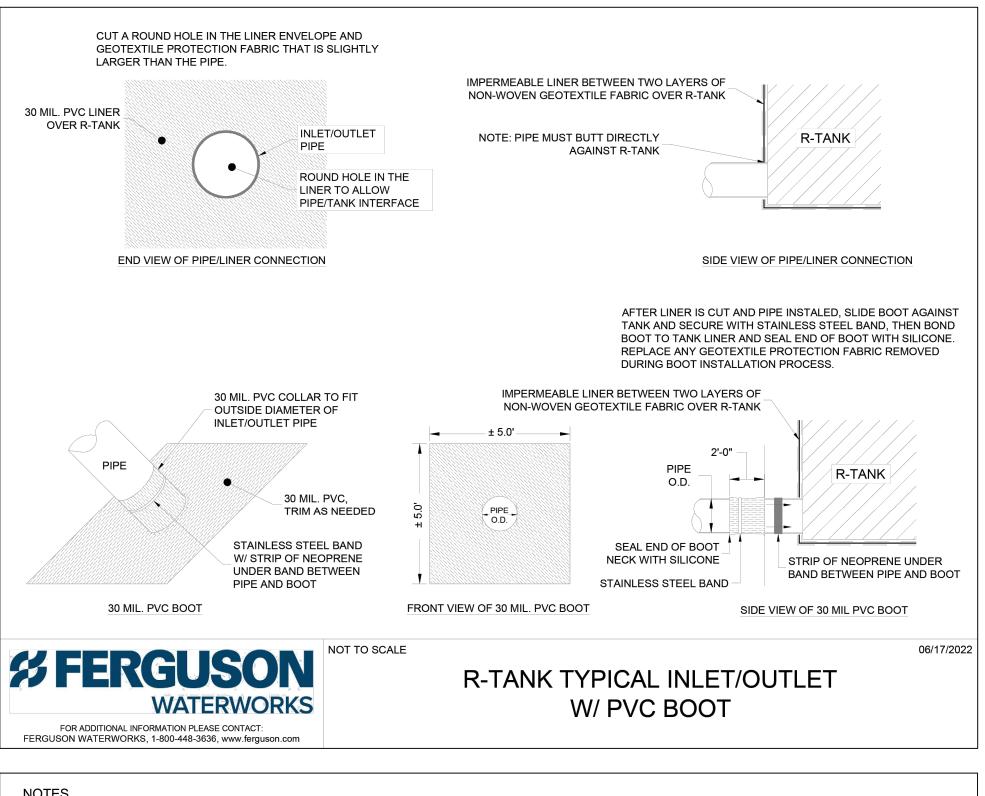
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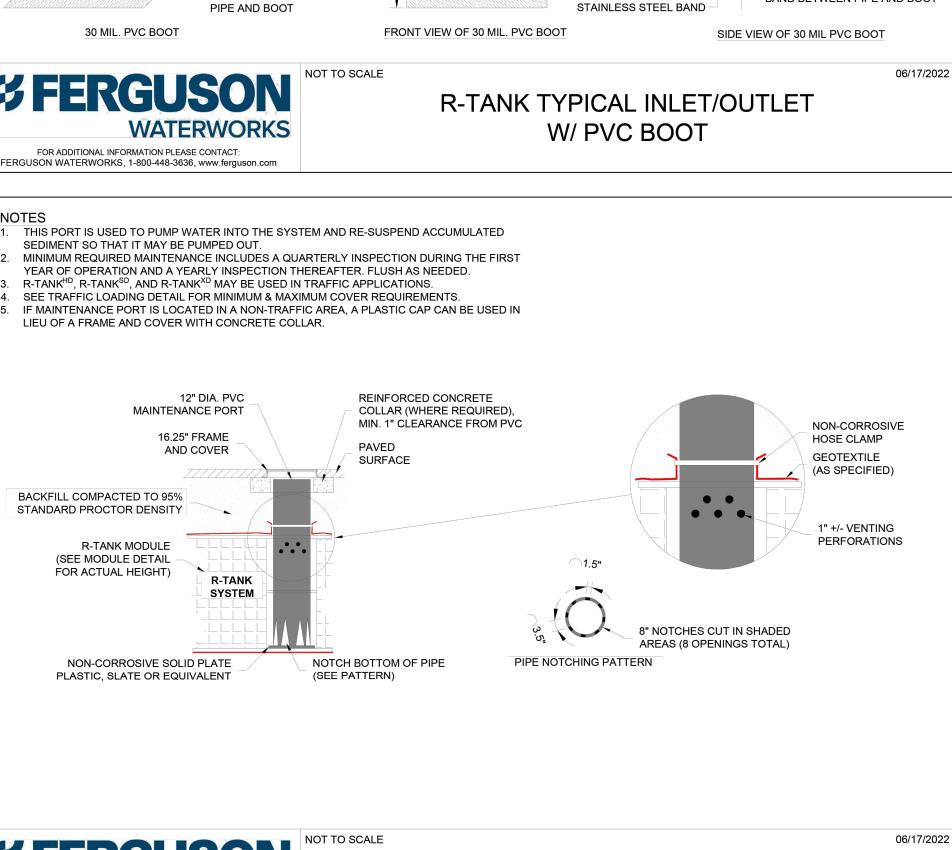
FERGUSON WATERWORKS, 1-800-448-3636, www.ferguson.com





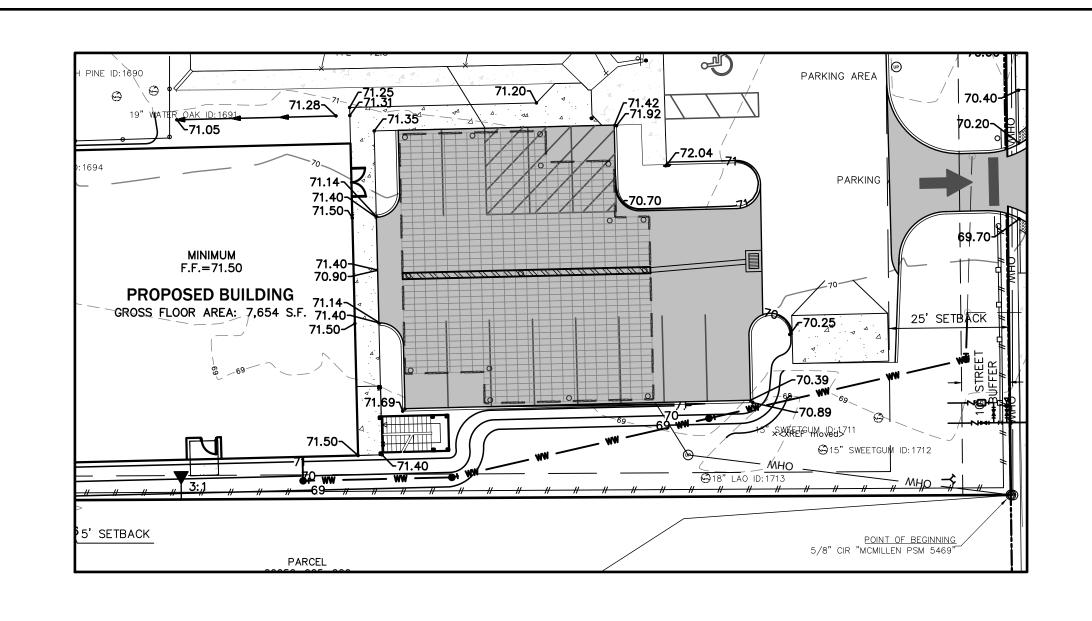

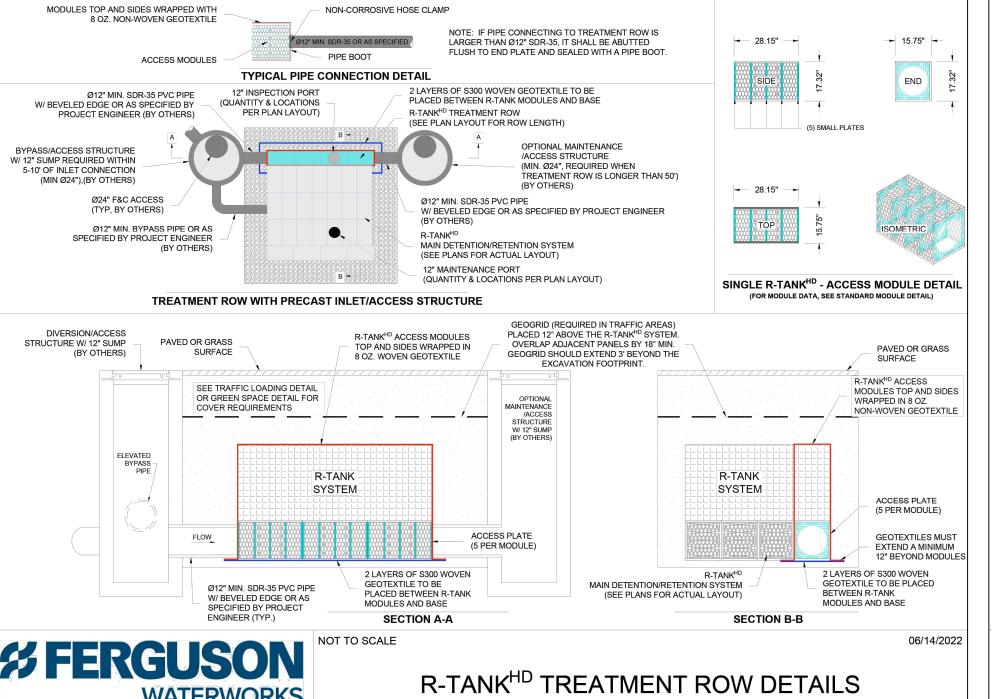


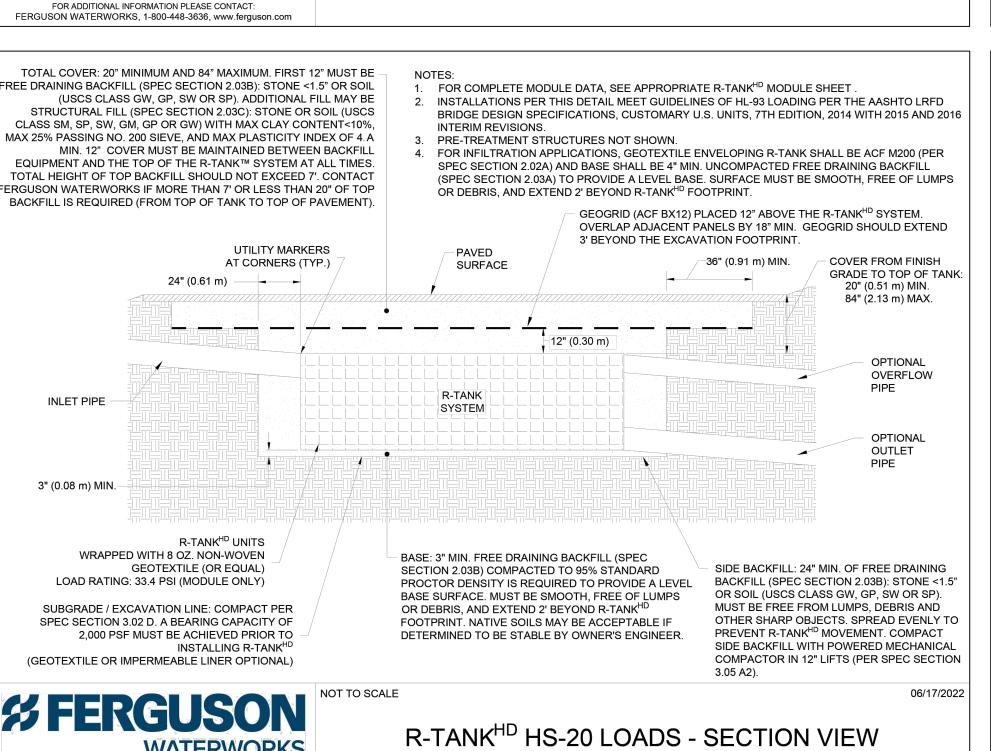


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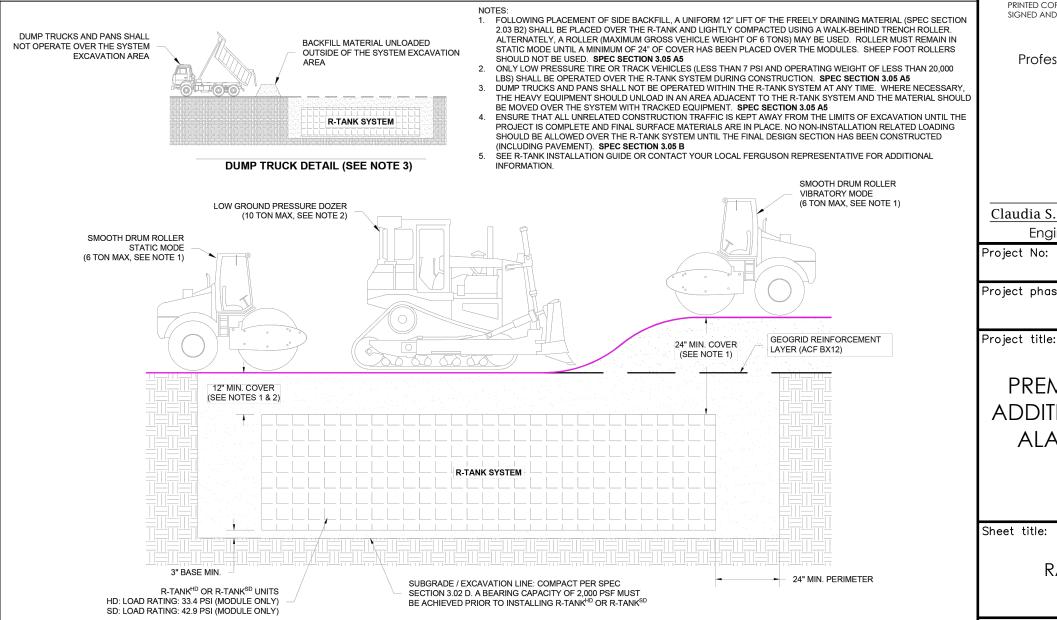
R-TANK^{HD/SD/XD/LD} 12" MAINTENANCE PORT





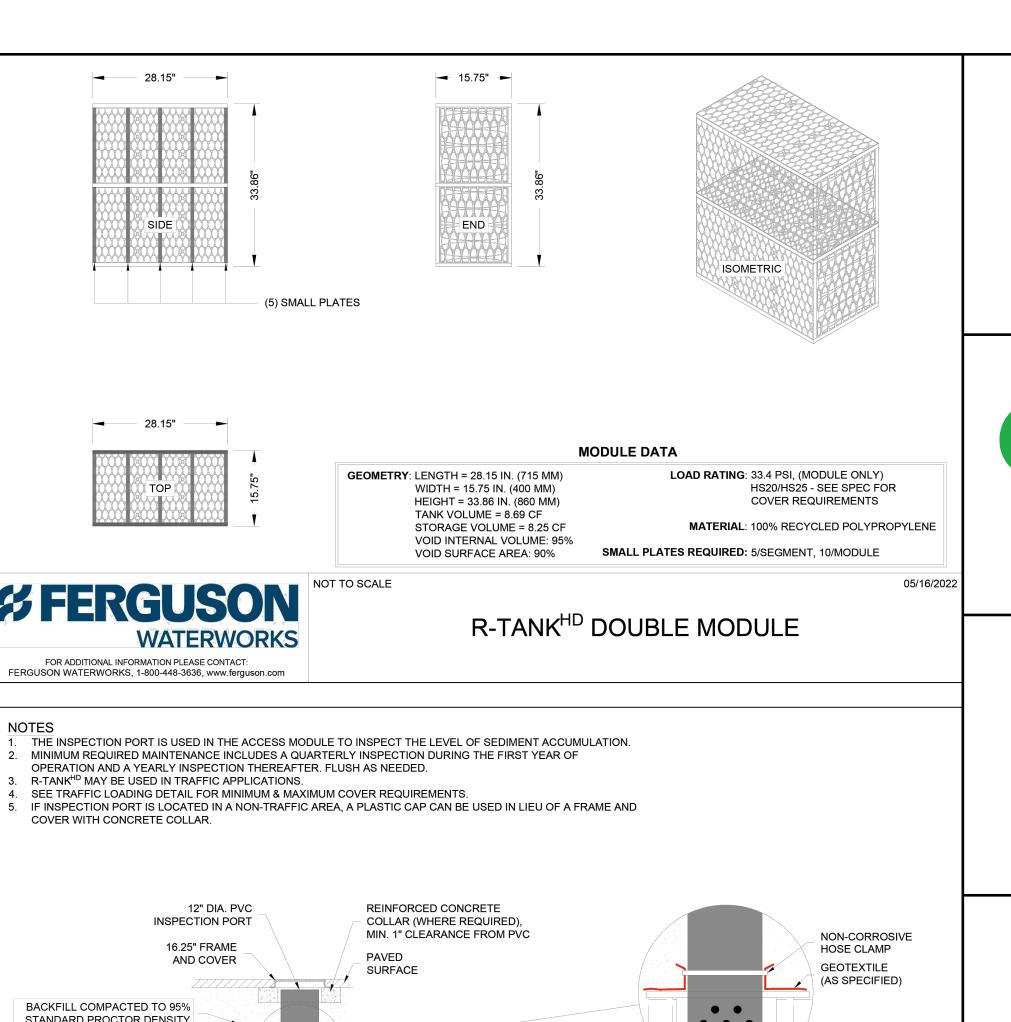

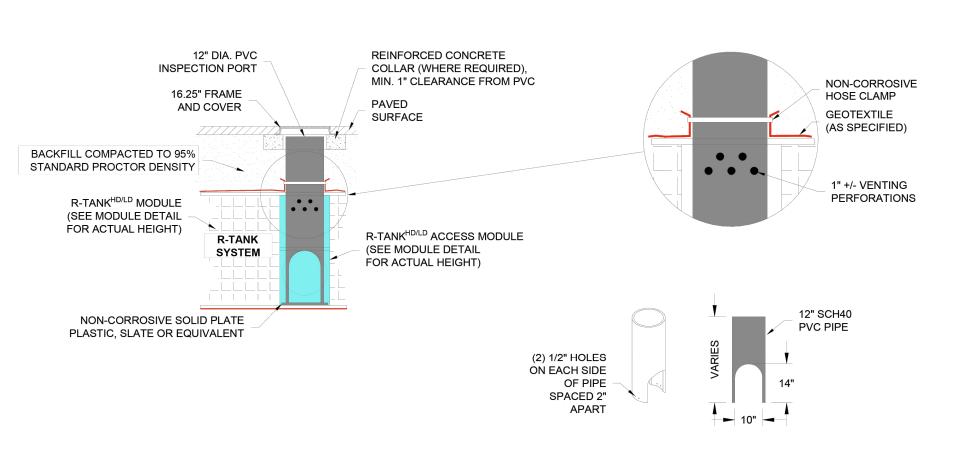R-TANK^{HD/LD} 12" INSPECTION PORT



FOR ADDITIONAL INFORMATION PLEASE CONTACT:

FERGUSON WATERWORKS 1-800-448-3636 www.ferguson.com

R-TANK^{HD/SD} CONSTRUCTION EQUIPMENT COVER DETAIL (TRAFFIC)

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SCALE: 1" = 20'

GRAPHIC SCALE

Comment

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CLAUDIA S. VEGA, P.E. ON THE DATE ADJACENT TO THE SEAL.

Professional Engineer of Record:

Claudia S. Vega, P.E. Certificate No. 2021-0162

Project phase: REVISED FINAL

PREMIER PRESCHOOL ADDITION REVISED FINAL ALACHUA COUNTY,

FLORIDA

Sheet title:

06/16/2022

RAINTANK DETAILS

esigned: Drawn: LBO/NJG Checked: Date: 11/22/23

THE STORMWATER POLLUTION PREVENTION PLAN (SWPPP) MAY BE MODIFIED AND UPDATED DURING CONSTRUCTION AS A RESULT OF WEATHER, UNPREDICTABLE EVENTS AND SITE INSPECTIONS.

THIS DOCUMENT WAS PREPARED IN ORDER TO BE IN COMPLIANCE WITH CHAPTER 62-621.300 (4) OF THE FLORIDA ADMINISTRATIVE CODE, WHICH PERTAINS TO THE GENERIC PERMIT FOR STORMWATER DISCHARGE FROM LARGE AND SMALL CONSTRUCTION ACTIVITIES. THE ADMINISTRATIVE CODE GRANTS THE FLORIDA DEPARTMENT OF ENVIRONMENTAL PROTECTION (FDEP) THE AUTHORITY TO REGULATE POINT SOURCE DISCHARGES OF STORM-WATER FROM CONSTRUCTION SITES. THIS DOCUMENT ESTABLISHES A STORMWATER POLLUTION PREVENTION PLAN FOR THE SITE AND IS ORGANIZED TO CORRESPOND TO PART V OF DEP DOCUMENT No. 62-621.300 (4) (A) FDEP FORM 62-261.300 (4) (B) IS TO BE SUBMITTED IN CONJUNCTION WITH THIS DOCUMENT.

I. PROJECT INFORMATION:

PROJECT: PREMIER PRESCHOOL ADDITION REVISED FINAL COUNTY: ALACHUA, FLORIDA SECTION/TOWNSHIP/RANGE: S 05, T 10 SOUTH, R 19 EAST COUNTY PARCEL NO.: 06656-057-001 LATITUDE AND LONGITUDE: 29°39'08.21"N 82°25'22.45"W STREET ADDRESS: 10 SW 75TH STREET GAINESVILLE, FLORIDA 32607 PROJECT AREA: 1.0 ACRE APPROXIMATE AREA TO BE DISTURBED BY CONSTRUCTION:

II. SITE DESCRIPTION:

THE PROPOSED DEVELOPMENT CONSISTS OF A BUILDING ADDITION WITH ASSOCIATED DRAINAGE AND UTILITY IMPROVEMENTS.

AT THE PREDEVELOPMENT CONDITIONS, THE PROJECT AREA IS DIVIDED INTO TWO DRAINAGE AREAS AS SHOWN IN THE STORMWATER PLAN AS DESCRIBED

AREA 1: DRAINS 0.28 Ac. 2.) AREA 2: DRAINS 0.73 Ac.

AT POST-DEVELOPMENT CONDITIONS, THE PROPOSED PROJECT AREA WILL HAVE THREE DRAINAGE AREAS AS SHOWN IN THE STORMWATER PLAN AND AS

AREA 1: WILL DISCHARGE 0.28 Ac. AREA 2: WILL DISCHARGE 0.22 Ac. 3.) AREA 3: WILL DISCHARGE 0.51 Ac.

•							
DRAINAGE AREA	BASIN NUMBER	PRE-DEVELOPMENT AREA	POST-DEVELOPMENT AREA	CURVE NUMBER	ENTIRE BASIN VOLUME (C.F.)	100 YR FLOOD PLAIN	BASIN TYPE
1	N/A	0.28 AC	0.28 AC	72.18	N/A	N/A	N/A
2	UNDEGROUND	0.73 AC	0.22 AC	77.81	6,920	67.81	UNDERGROUND
3	1	0.73 AC	0.51 AC	68.14	6,550	68.97	DRY

2. THE SOIL CONDITIONS WERE INVESTIGATED AND SUMMARIZED IN THE SOILS REPORTS PREPARED BY UNIVERSAL ENGINEERING SCIENCES. THE PROPOSED DRAINAGE PLAN WILL CONSIST OF 3 DRAINAGE AREAS.

AREA 1:0.28 ACRES OF RUNOFF WILL KEEP DISCHARGING TO THE SOUTH, UNALTERED BY CONSTRUCTION.

AREA 2:0.22 ACRES OF RUNOFF WILL DISCHARGE TO THE tO

AREA 3:0.51 ACRES OF RUNOFF WILL DISCHARGE TO THE DRY

- EXISTING AND FUTURE DRAINAGE PATTERNS ARE SHOWN ON THE DRAINAGE PLAN FOR PRE-DEVELOPMENT CONDITIONS AND POST-DEVELOPMENT CONDITIONS. OUTFALLS. AND STORMWATER BASINS ARE SHOWN IN THE
- 4. SEQUENCE OF CONSTRUCTION:

DRAINAGE PLAN AND THE DETAIL PLAN.

- A. PRIOR TO CONSTRUCTION, SILT FENCING AND TREE PROTECTION BARRICADES SHALL BE INSTALLED AND ALL EXISTING DRAINAGE STRUCTURES SHALL BE PROTECTED IN ACCORDANCE WITH THE FDOT FLORIDA EROSION AND SEDIMENTATION CONTROL MANUAL.
- B. THE CONSTRUCTION ENTRANCE WILL BE STABILIZED TO MINIMIZE THE CREATION OF DUST AND OFF SITE TRACKING OF SEDIMENTS.
- C. THE SITE SHALL BE CLEARED AND GRUBBED OF UNDESIRABLE VEGETATION.
- D. THE UNDERGROUND UTILITIES AND STORMWATER PIPING WILL BE INSTALLED AND CONNECTED TO EXISTING STRUCTURES.
- E. THE SITE WILL BE ROUGHLY GRADED. IF SUITABLE, THE EXCAVATED MATERIAL MAY BE USED AS FILL FOR ON-SITE GRADING, THE ROADWAYS SHALL BE GRADED. (THE BASIN AREA SHALL BE STABILIZED AS SPECIFIED IN THE PLANS.)
- ROADWAYS AND PARKING LOTS WILL BE COMPACTED AND A LIMEROCK BASE WILL BE ESTABLISHED FOLLOWED BY AN OVERLAY OF ASPHALTIC CONCRETE. BUILDINGS SHALL BE CONSTRUCTED.
- G. UPON SIGNIFICANT COMPLETION OF CONSTRUCTION, THE STORMWATER SYSTEM SHALL BE FLUSHED OUT TO REMOVE ACCUMULATED DEBRIS AND
- H. ALL DISTURBED AREAS WITHIN THE CONSTRUCTION AREA SHALL BE COMPLETELY GRASSED AND/OR LANDSCAPED. EVIDENCE OF GROWTH MUST BE PRESENT PRIOR TO REMOVAL OF SILT FENCING AND OTHER EROSION

III. CONTROLS:

THE CONTROLS SHALL BE IMPLEMENTED AND MAINTAINED DURING THE ENTIRE CONSTRUCTION OF THE PROJECT. IF SITE CONDITIONS ARE SUCH THAT ADDITIONAL CONTROL MEASURES ARE REQUIRED THAN WHAT IS SPECIFIED IN THE EROSION AND SEDIMENTATION CONTROL PLAN, THEN THE CONTRACTOR SHALL IMPLEMENT ADDITIONAL BEST MANAGEMENT PRACTICES NECESSARY

- THE CONSTRUCTION ACCESS SHALL BE STABILIZED WITH GRAVEL AND TEMPORARY VEGETATION TO PREVENT SILT LEAVING THE SITE.
- TREE BARRICADES SHALL BE IMPLEMENTED BEFORE CLEARING AND GRUBBING OF ANY OF THE WORK AREAS.
- 3. BEFORE CLEARING, SILT FENCES SHALL BE INSTALLED AROUND THE PERIMETER OF THE CONSTRUCTION AND AROUND THE BASIN AS SHOWN IN THE PLANS. ALL EXISTING STORM DRAINAGE SWALES AND INLETS SHALL BE PROTECTED PER THE FDOT FLORIDA EROSION AND SEDIMENTATION CONTROL MANUAL.
- 4. AFTER CLEARING BUT BEFORE EXCAVATION AND GRADING, TEMPORARY BERMS AND SWALES SHALL BE CONSTRUCTED AS REQUIRED TO DIVERT THE FLOW INTO THE CORRESPONDING STORMWATER BASIN.
- DURING CONSTRUCTION OF PAVING AND BUILDINGS, FROSION AND SEDIMENTATION CONTROL MEASURES SHALL BE INSTALLED AS REQUIRED.
- ALL DISTURBED AREAS WITHIN THE CONSTRUCTION SITE SHALL BE COMPLETELY LANDSCAPED AND/OR GRASSED. FINAL STABILIZATION (INCLUDING SEEDING, MULCHING, SODDING OR RIPRAP) SHALL BE INSTALLED AS REQUIRED. GRASS SEEDING RATES AND MIXTURES SHALL BE PER FDOT INDEX 104. EVIDENCE OF GROWTH MUST BE PRESENT PRIOR TO REMOVAL OF SILT FENCING AND OTHER EROSION CONTROL APPLICATIONS AND PRIOR TO FINAL RELEASE.

IV. EROSION AND SEDIMENTATION CONTROLS:

STABILIZATION PRACTICES

- THE ENTRANCE TO THE SITE SHALL BE STABILIZED BEFORE CONSTRUCTION AND FURTHER DISTURBANCE BEGINS. GRAVEL PAD SHALL PROVIDE STABILIZATION AND MINIMIZE THE AMOUNT OF SEDIMENT LEAVING THE SITE. MAINTENANCE OF THE ENTRANCE SHALL INCLUDE SWEEPING OF THE AREA ADJACENT TO THE ENTRANCE. STONE AND GRAVEL MIGHT NEED TO BE PERIODICALLY ADDED TO MAINTAIN THE EFFECTIVENESS OF THE ENTRANCE.
- 2. TREE BARRICADES SHALL BE INSTALLED AROUND THE TREES AS SHOWN IN THE DETAIL PLAN TO PROTECT THE EXISTING VEGETATION.
- 3. MULCH SHALL BE PLACED IN THE AREAS REQUIRED TO PREVENT EROSION FROM STORMWATER RUNOFF AND THE AREAS SHOWN ON THE PLANS. MULCH SHALL BE ANCHORED TO RESIST WIND DISPLACEMENT AND SHALL BE INSPECTED AFTER EVERY RAINSTORM TO IDENTIFY AREAS WHERE MULCH HAS BEEN WASHED OUT OR LOOSENED. THESE AREAS SHALL HAVE MULCH COVER
- 4. SEEDING SHALL BE STARTED AFTER GRADING HAS BEEN FINISHED ON THE AREAS SHOWN IN THE PLANS. SEEDED AREAS SHOULD BE INSPECTED FOR FAILURE TO ESTABLISH, AND NECESSARY REPAIRS AND RESEEDING SHOULD BE MADE AS SOON AS POSSIBLE. ADDITIONAL SEEDING AND MULCH MAY BE REQUIRED AS NECESSARY TO PREVENT EROSION DURING OR AFTER CONSTRUCTION HAS FINISHED.
- 5. SOD SHALL BE INSTALLED IN THE AREAS SHOWN IN THE PLANS, SOD SHALL BE PEGGED IF INSTALLED ON SLOPES GREATER THAN 3:1. SODDED AREAS SHALL BE MAINTAINED AND INSPECTED TO ENSURE SUCCESSFUL ESTABLISHMENT.

SEDIMENTATION PRACTICES

- SILT FENCES SHALL BE INSTALLED IN THE AREAS SHOWN IN THE PLANS AND AS REQUIRED TO PREVENT SEDIMENT FROM LEAVING THE CONSTRUCTION AREA. SILT FENCES SHALL BE INSPECTED AFTER EACH RAINFALL EVENT TO ENSURE THAT THERE ARE NO GAPS OR TEARS. IF GAPS OR TEARS ARE FOUND THE FABRIC SHOULD BE REPAIRED OR REPLACED. SEDIMENT REMOVAL SHALL BE PART OF THE REGULAR MAINTENANCE. SILT FENCES SHALL REMAIN IN PLACE UNTIL CONSTRUCTION HAS FINISHED AND DISTURBED AREAS ARE PERMANENTLY
- 2. DIVERSION SWALES, IF REQUIRED, SHALL BE CONSTRUCTED BEFORE MAJOR LAND DISTURBANCE OF THE RECEIVING BASIN. DIVERSION SWALES SHALL BE STABILIZED AFTER CONSTRUCTION TO MAINTAIN ITS EFFICIENCY.
- 3. INLETS SHOULD BE TEMPORARILY PROTECTED TO PREVENT SEDIMENT ENTERING THE INLET. BARRIERS WILL CATCH SOIL, DEBRIS AND SEDIMENT AT THE ENTRANCE OF THE INLET.
- 4. OUTFALL STRUCTURES SHALL HAVE SILT FENCES TO PREVENT SILT FROM ENTERING THE STORMWATER BASINS AND SHALL BE STABILIZED AS REQUIRED TO PREVENT EROSION FROM WASHOUTS.

V. STORMWATER MANAGEMENT:

- 1. THE PROPOSED PROJECT OBTAINED AN ENVIRONMENTAL RESOURCE PERMIT FROM ST. JOHNS RIVER WATER MANAGEMENT DISTRICT (SJRWMD) FOR THE CONSTRUCTION AND OPERATION OF A STORMWATER TREATMENT SYSTEM AND CONTROLS. THE PROPOSED SYSTEM (AS SHOWN ON THE PLANS) INCLUDED THE USE OF THE BEST MANAGEMENT PRACTICES (BMP) CONSISTENT WITH THE APPLICABLE REQUIREMENTS OF RULE 40C-42 OF THE DISTRICT. THE OWNER AND/OR THE CONTRACTOR SHALL BE RESPONSIBLE FOR THE OPERATION AND MAINTENANCE OF THE STORMWATER TREATMENT SYSTEM AND CONTROLS UNTIL CONSTRUCTION ACTIVITIES ARE COMPLETED AND FINAL STABILIZATION HAS BEEN ACCOMPLISHED. HOWEVER, THE OWNER AND/OR AN ENTITY SIMILAR TO A HOMEOWNERS ASSOCIATION SHALL BE RESPONSIBLE FOR THE OPERATION AND MAINTENANCE OF THE STORMWATER SYSTEM IN PERPETUITY, IN ACCORDANCE WITH THE REQUIREMENTS OF THE ENVIRONMENTAL RESOURCE PERMIT.
- 2. TO TREAT AND CONTROL THE STORMWATER PRODUCED BY THE PROPOSED DEVELOPMENT, THE PROJECT REQUIRES THE INSTALLATION AND CONSTRUCTION OF THE FOLLOWING BMP'S: 1 DRY RETENTION BASINS AND 1 UNDERGROUND BASIN WITH ALL GRADING ASSOCIATED WITH THE CONSTRUCTION. THE BASINS HAS BEEN DESIGNED TO CONTAIN AND ATTENUATE THE STORMS AND DISCHARGE AT PRE-DEVELOPMENT CONDITIONS. WHILE PROVIDING TREATMENT TO THE RUNOFF AS REQUIRED BY THE DISTRICT AND STATE RULES USING THE GUIDELINES CONTAINED IN THE SJRWMD HANDBOOK.
- 3. AREA 2 WILL HAVE SELF CONTAINED UNDERGROUND BASIN. AREA 3 WILL HAVE A DRY RETENTION BASIN THAT WILL OVERFLOW TO THE SOUTH VIA A SOD LINER WEIR.

VI. CONTROLS FOR OTHER POTENTIAL POLLUTANTS:

- WASTE DISPOSAL: NO SOLID MATERIALS, INCLUDING CONSTRUCTION MATERIALS, SHALL BE DISCHARGED TO SURFACE WATERS AND ARE NOT AUTHORIZED UNDER THE ISSUED ENVIRONMENTAL RESOURCE PERMIT.
- 2. THE USE OF GRAVEL AND CONTINUING SWEEPING ACTIVITIES AT THE ENTRANCE OF THE SITE WILL CONTROL THE TRACKING OF SEDIMENT AND DUST LEAVING
- 3. THE PROPOSED DEVELOPMENT WILL PROVIDE WATER AND SEWER SYSTEM BY CONNECTING INTO THE CENTRAL MUNICIPAL SYSTEM OF GAINESVILLE REGIONAL
- 4. ANY APPLICATION OF FERTILIZERS AND PESTICIDES NECESSARY TO ESTABLISH AND MAINTENANCE OF VEGETATION DURING CONSTRUCTION AND THROUGH PERPETUITY MAINTENANCE SHALL FOLLOW THE MANUFACTURERS RECOMMENDATIONS AND THE APPLICABLE RULES OF THE STATE OF FLORIDA.
- 5. ANY TOXIC MATERIALS REQUIRED DURING CONSTRUCTION SHALL BE PROPERLY STORED, DISPOSED OF AND CONTRACTOR AND/OR OWNER SHALL PROVIDE THE APPROPRIATE PERMITS FROM THE LOCAL OR STATE AGENCIES.

VII. APPROVED STATE OR LOCAL PLANS:

- 1. ALL THE SEDIMENT AND EROSION CONTROLS THAT ARE LISTED IN THE SITE PLAN AS APPROVED BY THE SJRWMD ARE INCLUDED IN THIS STORMWATER POLLUTION PREVENTION PLAN (SEE ITEM III AND IV).
- 2. THIS STORMWATER POLLUTION PREVENTION PLAN SHALL BE AMENDED IF REQUIRED BY ANY LOCAL OR STATE AGENCY OR AS REQUIRED BY UNFORESEEABLE CONDITIONS AND THE OWNER SHALL SUBMIT A RE-CERTIFICATION TO THE NPDES STATE OFFICE THAT THE PLAN HAS BEEN AMENDED TO ADDRESS THOSE CHANGES.

VIII. MAINTENANCE:

THE CONTRACTOR IS RESPONSIBLE FOR THE MAINTENANCE, INSPECTION SCHEDULE, AND REPAIRS OUTLINED IN THIS PLAN. MAINTENANCE SHALL CONTINUE THROUGHOUT THE PROJECT UNTIL WORK IS COMPLETE. THE CONTRACTOR IS RESPONSIBLE FOR REMOVING ALL TEMPORARY EROSION AND SEDIMENT CONTROL DEVICES AFTER CONSTRUCTION IS COMPLETE.

IN ADDITION TO THE ITEMS MENTIONED IN THE PREVIOUS SECTIONS, THE CONTRACTOR SHALL INITIATE ANY REPAIRS WITHIN 24 HOURS OF BEING REPORTED. IN THE EVENT THAT THE BASINS DO NOT PERFORM PROPERLY OR IF A SINKHOLE DEVELOPS, THE PROJECT ENGINEER SHALL BE NOTIFIED TO ASSIST IN COORDINATING REMEDIAL ACTION.

- 1. MAINTENANCE WOULD BE DIVIDED IN ROUTINE MAINTENANCE AND REPAIR MAINTENANCE. ALL STORMWATER BMP'S SHOULD BE INSPECTED FOR CONTINUED EFFECTIVENESS AND STRUCTURAL INTEGRITY ON A REGULAR BASIS. THE SYSTEMS SHOULD BE CHECKED AFTER EACH STORM EVENT IN ADDITION TO REGULARLY SCHEDULED INSPECTIONS.
- 2. ROUTINE MAINTENANCE REQUIREMENTS SHOULD BE INCLUDED IN THE INSPECTOR CHECKLIST TO AID THE INSPECTOR IN DETERMINING WHETHER A BMP'S MAINTENANCE IS ADEQUATE OR NEEDS A REVISION. INSPECTORS
- 3. SIDE ENTRANCES: MAINTENANCE SHALL INCLUDE REPLACEMENT OF GRAVEL AND CLEANING THE SOIL THAT IS TRACKED OFFSITE FOR PROPER

SHALL KEEP RECORD OF MAINTENANCE, ROUTINE OR REPAIR, TO PROVIDE

4. TREE BARRICADES: MAINTENANCE SHALL INCLUDE INSPECTION OF MESH AND POSTS AND REPAIR OR REPLACEMENT OF DAMAGED VEGETATION.

EVIDENCE OF AN EFFICIENT INSPECTION AND MAINTENANCE.

- 5. SILT FENCES: MAINTENANCE SHALL INCLUDE SEDIMENT REMOVAL AND INSPECTION TO ENSURE PROPER ANCHORING AND THAT NO TEARING OR GAPS HAVE OCCURRED. ACCUMULATED SEDIMENT SHALL BE REMOVED WHEN IT HAS REACHED ONE-THIRD THE HEIGHT OF SILT FENCE.
- 6. DIVERSION SWALES: MAINTENANCE SHALL INCLUDE INSPECTION AFTER EVERY RAINFALL EVENT AND ONCE EVERY TWO WEEKS BEFORE FINAL STABILIZATION. THEY SHOULD BE CLEARED OF SEDIMENT AND MAINTAIN
- 7. TEMPORARY BERMS: MAINTENANCE SHALL INCLUDE REMOVAL OF DEBRIS, TRASH SEDIMENT AND LEAVES. SIDES OF THE BERM SHALL BE INSPECTED FOR EROSION AFTER EACH STORM EVENT.
- 8. MULCHING: ROUTINE MAINTENANCE SHALL INCLUDE REPLACEMENT
- 9. SEEDING: ROUTINE MAINTENANCE SHALL INCLUDE RESEEDING OF AREAS THAT FAILED TO ESTABLISH.
- 10. SODDING: ROUTINE MAINTENANCE SHALL INCLUDE WATERING AND MOWING. REPLACEMENT OF GRASS MAY BE NECESSARY IF COVER IS NOT FULLY

STORM EVENT AND MIGHT INCLUDE REMOVAL OF ACCUMULATED SEDIMENT.

OWNER: INTERNATIONAL EDUCATION SOLUTIONS INC.

Location

CONSTRUCTION MANAGER:

Date of

Inspection

CONDITION CODE:

CONTROL TYPE CODES

3. Structural diversion

Silt Fence

6. Check dam

4. Swale

above.

2. Earth dikes

5. Sediment Trap

7. Subsurface drain 8. Pipe slope drain

9. Level spreaders

INSPECTOR INFORMATION:

- 11. INLETS: ROUTINE MAINTENANCE SHALL INCLUDE INSPECTION AFTER EVERY
- 12. OUTFALL STRUCTURES: ROUTINE MAINTENANCE SHALL INCLUDE INSPECTION AFTER EVERY STORM EVENT TO ASSURE NO EROSION OR SCOUR HAS

IX. INSPECTIONS:

- THE OWNER AND /OR CONTRACTOR SHALL PROVIDE QUALIFIED PERSONNEL TO INSPECT ALL POINTS OF POTENTIAL DISCHARGE FROM THE PROJECT SITE FOR DISTURBED AREAS, THE EROSION AND SEDIMENTATION CONTROLS AND BMP'S AS LISTED IN THIS PLAN. THE INSPECTION SHALL BE PERFORMED DURING CONSTRUCTION AND BEFORE FINAL STABILIZATION, ONCE EVERY SEVEN-CALENDAR DAYS AND WITHIN 24 HOURS OF THE END OF A STORM THAT IS GREATER THAN 0.50 INCHES. AFTER FINAL STABILIZATION AND BEFORE FINISH OF CONSTRUCTION THE INSPECTION SHALL BE CONDUCTED ONCE EVERY MONTH.
- 2. THE CONTRACTOR SHALL INSTALL A RAIN GAUGE AT THE SITE TO MONITOR AND DOCUMENT RAINFALL EVENTS IN EXCESS OF 0.50 INCHES.
- 3. ALL DISTURBED AREAS AND AREAS USED FOR MATERIALS STORAGE SHALL BE INSPECTED FOR POLLUTANTS ENTERING THE STORMWATER SYSTEM. THE STORMWATER MANAGEMENT SYSTEM AND EROSION AND SEDIMENT CONTROL MEASURES IDENTIFIED IN THE PLAN SHALL BE INSPECTED TO ENSURE THEY ARE OPERATING CORRECTLY. LOCATIONS WHERE VEHICLES ENTER AND LEAVE THE SITE SHALL BE INSPECTED FOR EVIDENCE OF OFFSITE SEDIMENT
- 4. REPAIR OR MAINTENANCE NEEDED TO ASSURE PROPER OPERATION OF THE STORMWATER POLLUTION PREVENTION PLAN SHALL BE DONE IN A TIMELY MANNER BUT NO LATER THAN 7 CALENDAR DAYS FOLLOWING THE
- 5. A REPORT SHALL BE KEPT OF EACH INSPECTION FOR THREE YEARS AFTER FINAL STABILIZATION AND SHALL INCLUDE THE DATES OF EACH INSPECTION, THE SCOPE OF THE INSPECTION, MAJOR OBSERVATIONS, ANY REPAIR AND/OR MAINTENANCE REQUIRED AND ANY INCIDENT OF NON-COMPLIANCE. IF THE REPORT DOES NOT CONTAIN ANY INCIDENTS OF NON-COMPLIANCE, THE REPORT SHALL CONTAIN A CERTIFICATION THAT THE FACILITY HAS BEEN IN COMPLIANCE WITH THE STORMWATER POLLUTION PREVENTION PLAN AND THE NPDES PERMIT. THE REPORT SHALL INCLUDE THE NAME AND QUALIFICATIONS OF THE INSPECTOR AND SHALL BE SIGNED IN ACCORDANCE TO FDEP RULE 62-621.300, PART VII.C. A COPY OF THE CONSTRUCTION INSPECTION FORM IS INCLUDED ON THIS STORMWATER POLLUTION PREVENTION PLAN SHEET. A COPY SHALL BE RETAINED AT THE CONSTRUCTION SITE FROM THE DATE OF PROJECT INITIATION TO THE DATE OF FINAL STABILIZATION.

X. NON-STORMWATER DISCHARGES:

- 1. THE FOLLOWING NON-STORMWATER DISCHARGES MIGHT BE COMBINED WITH STORMWATER AND WOULD BE AUTHORIZED AS PART OF THIS PERMIT: FIRE HYDRANT FLUSHING, CONTROL OF DUST, POTABLE WATER FLUSHING AND IRRIGATION DRAINAGE. BECAUSE OF THE NATURE OF THESE DISCHARGES, THE EROSION, STABILIZATION AND TREATMENT SYSTEMS TO BE IMPLEMENTED, AS PART OF THIS PLAN WOULD BE APPROPRIATE TO PREVENT AND TREAT ANY POLLUTION RELATED TO THESE NON-STORMWATER DISCHARGES.
- 2. DISCHARGES FROM DEWATERING ACTIVITIES ASSOCIATED WITH SITE CONSTRUCTION ARE NOT AUTHORIZED AND REQUIRED CONSTRUCTION OF TEMPORARY SEDIMENTATION BASINS AND USE OF APPROPRIATE FLOCCULATING AGENTS TO ENHANCE PARTICLE SEGREGATION AND SPEED UP SETTLING OF PARTICLES.

XI. CONTRACTORS:

PREMIER PRESCHOOL ADDITION REVISED FINAL

G = Good

C = Needs to be cleaned

10. Storm drain inlet protection

12. Vegetative preservation area

14. Construction entrance stabilization

11. Vegetative buffer strip

13. Retention Pond

15. Perimeter ditch

the possibility of fine and imprisonment for knowing violations.

16. Curb and gutter

17. Paved road surface

18. Rock outlet protection

(see below)

1. ALL CONTRACTORS AND/OR SUBCONTRACTORS RESPONSIBLE FOR IMPLEMENTING THE PLAN SHALL SIGN THE CERTIFICATION STATEMENT BEFORE STARTING CONSTRUCTION ACTIVITIES OF THE PROJECT. THE CERTIFICATION MUST INCLUDE THE NAME AND TITLE OF THE PERSON PROVIDING THE SIGNATURE, THE NAME, ADDRESS AND TELEPHONE NUMBER OF THE CONTRACTING FIRM, THE ADDRESS OF THE SITE AND THE DATE THE CERTIFICATION IS MADE. THE OWNER SHALL KEEP THESE CERTIFICATIONS AS PART OF THIS POLLUTION PLAN. MULTIPLE COPIES OF THE CERTIFICATION STATEMENT MAY BE NECESSARY DEPENDING UPON THE NUMBER OF SUBCONTRACTORS ASSOCIATED WITH THE PROJECT.

STORMWATER POLLUTION PREVENTION PLAN INSPECTION REPORT FORM

20. Gabion

24. Mulch

25. Hay Bales

26. Geotextile

27. Rip-rap

The above signature also shall certify that this facility is in compliance with the Stormwater Pollution Prevention Plan and the State of Florida

"I certify under penalty of law that this document and all attachments were prepared under my direction or supervision in accordance with a

Generic Permit for Stormwater Discharge from Large and Small Construction Activities if there are not any incidents of non compliance identified

* * * * * *

21. Sediment Basin

22. Temporary seed / sod

23. Permanent seed / sod

Rain data | Type of control | Date installed | Current Condition |

/ modified

Inspections must occur at least once a week and within 24 hours of the end of a storm event that is 0.50 inches or greater.

(see below)

CONTRACTOR: ___

M = Marginal, needs maintenance or replacement soon O = Other

19. Reinforced soil retaining system | 28. Tree protection

P = Poor, needs immediate maintenance or replacement

FDEP NPDES STORMWATER IDENTIFICATION NO.: FLR10 _____

Observations or Corrective Action /

Other Remarks

29. Detention pond

30. Retention pond

32. Dam

34. Other

33. Sand Bag

31. Waste disposal / housekeeping

Inspected

By

CERTIFICATION STATEMENT

"I CERTIFY UNDER PENALTY OF LAW THAT I UNDERSTAND AND SHALL COMPLY WITH THE TERMS AND CONDITIONS OF THE STATE OF FLORIDA GENERIC PERMIT FOR STORMWATER DISCHARGE FROM LARGE AND SMALL CONSTRUCTION ACTIVITIES AND THIS STORMWATER POLLUTION PREVENTION PLAN PREPARED THEREUNDER."

CONTRACTING FIRM:
ADDRESS:
CITY, STATE, ZIP CODE:
TELEPHONE:
FAX:
PROJECT NAME: PREMIER PRESCHOOL ADDITION REVISED FINAL
PROJECT ADDRESS:
PROJECT ADDRESS:
CITY, STATE, ZIP CODE: , FLORIDA,
NAME: SIGNATURE:



consultants inc. 720 S.W. 2nd Ave, South Tower, Suite 300 GAINESVILLE, FLORIDA 32601

TEL. (352) 373-3541

www.edafl.com permitting@edafl.com

No.	Date	Comment

THIS ITEM HAS BEEN DIGITALLY SIGNED AND SEALED BY CLAUDIA S. VEGA, P.E. ON THE DATE ADJACENT TO THE SEAL PRINTED COPIES OF THIS DOCUMENT ARE NOT CONSIDERED ON ANY ELECTRONIC COPIES.

Professional Engineer of Record:

Claudia S. Vega, P.E. 51532 Certificate No. Engineer

2021-0162

Project phase: **REVISED FINAL**

Project title:

PREMIER PRESCHOOL addition revised final ALACHUA COUNTY, **FLORIDA**

STORMWATER POLLUTION PREVENSION PLAN

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)rawn:	LB	O/NJG	
Checke	d:	CSV	
Date:	11/:	22/23	

system designed to assure that qualified personnel properly gathered and evaluated the information submitted. Based on my inquiry of the person or persons who manage the system or those persons directly responsible for gathering the information, the information submitted is, to the best of my knowledge and belief, true, accurate and complete. I am aware that there are significant penalties for submitting false information, including

GRU UTILITY NOTES