

# FINAL DEVELOPMENT PLANS

FOR:

# FLETCHER CENTER EAST

# ALACHUA COUNTY, FLORIDA

SECTION 3, TOWNSHIP 10 SOUTH, RANGE 18 EAST

## SUBMITTED TO:

ALACHUA COUNTY  
 SUWANNEE RIVER WATER MANAGEMENT DISTRICT  
 FLORIDA DEPARTMENT OF TRANSPORTATION  
 FLORIDA DEPARTMENT OF ENVIRONMENTAL PROTECTION  
 GAINESVILLE REGIONAL UTILITIES

## GENERAL NOTES

- PROJECT NAME:  
FLETCHER CENTER EAST
- PROJECT DESCRIPTION:  
PHASE 1 OF THE FLETCHER CENTER EAST PROJECT INCLUDES ±6,000 SF COMMERCIAL RETAIL AND ASSOCIATED DRIVES, PARKING, STORMWATER MANAGEMENT FACILITIES AND UTILITY INFRASTRUCTURE. PHASE 2 INCLUDES A SINGLE BAY CARWASH FACILITY (3,450 SF), 400 SF STORAGE BUILDING AND ASSOCIATED DRIVES, PARKING/VACUUM BAYS, STORMWATER MANAGEMENT FACILITIES AND UTILITY INFRASTRUCTURE. FUTURE PHASES (PERMITTED SEPARATELY) MAY PROVIDE ADDITIONAL COMMERCIAL RETAIL AND/OR QUICK SERVE RESTAURANT. REFER TO C1.00 SERIES FOR DETAILS.
- PROJECT ADDRESS:  
WEST OF SW 138TH TERRACE AND SOUTH OF W. NEWBERRY ROAD IN JONESVILLE, FL
- TAX PARCEL NUMBER(S):  
04344-003-000; 04344-009-000; AND 04345-011-000
- ENGINEERS OF RECORD:  
DANIEL H. YOUNG, P.E.  
CHW  
11801 RESEARCH DRIVE  
ALACHUA, FLORIDA 32615  
(352) 331-1976  
DanielY@chw-inc.com
- NUMBER OF UNITS/AREA OF BUILDINGS:  
ONE CARWASH BUILDING THAT CONSISTS OF ±3,450 SF, ONE STORAGE BUILDING THAT CONSISTS OF ±400 SF, AND ONE RETAIL BUILDING THAT CONSISTS OF ±6,000 SF.
- DENSITY:  
N/A.
- PHASING:  
PROJECT CONSISTS OF 2 PHASES. REFER TO C1.00 FOR PHASE DETAILS.
- DEVELOPMENT CRITERIA:


### 10. DEVELOPMENT SITE AREA:

TYPE	ACRES	SF	% OF TOTAL
TOTAL PROJECT AREA:	12.51 AC	544,936 SF	100%
NON-RESIDENTIAL BUILDING AREA:	0.198 AC	8,625 SF	1.58%
ROW/PAVEMENT/SIDEWALK/EASEMENTS AREA:	0.00 AC	0 SF	0.00%
EXISTING IMPERVIOUS AREA:	0.00 AC	0 SF	0.00%
PROPOSED IMPERVIOUS AREA:	2.50 AC	108,772 SF	20.0%
TOTAL IMPERVIOUS AREA:	4.88 AC	212,402 SF	39.0%
OPEN SPACE AREA (THIS PHASE):	N/A	N/A	N/A
CONSERVATION/PRESERVATION AREA:	0.00 AC	0 SF	0%
STORMWATER MANAGEMENT AREA:	1.35 AC	58,914 SF	10.8%
FLOOD PLAINS AREA:	N/A	N/A	N/A
WETLANDS AREA:	N/A	N/A	N/A
SURFACE WATER AREA:	N/A	N/A	N/A
STRATEGIC ECOSYSTEMS AREA:	N/A	N/A	N/A
SIGNIFICANT/LISTED SPECIES AREA:	N/A	N/A	N/A
BUFFERS/SCREENING AREA:	0.36 AC	15,489 SF	2.9%
GEOLOGICAL FEATURES AREA:	N/A	N/A	N/A

### 11. LOT/BUILDING REQUIREMENTS:

TYPE	REQUIRED	PROVIDED
MINIMUM LOT AREA (ACRES)	0.118 AC	12.51 AC
MINIMUM WIDTH AT FRONT BUILDING LINE (FT)	50	± 425'
MINIMUM DEPTH (FT)	100	± 342'
FRONT SETBACK (FT)	25	± 68'
REAR SETBACK (FT)	10	± 52'
SIDE SETBACK (FT)	5	5'
STREET SIDE (FT)	25	N/A
MAXIMUM BUILDING HEIGHT (FT)	BR/BH = 65' ; AP = 45'	RETAIL = 28' ; CARWASH = 22'
MAXIMUM BUILDING COVERAGE	BR/BH = N/A ; AP = 40%	BR/BH = N/A ; AP = 0%

TYPE	CRITERIA	REQUIRED	PROVIDED
OPEN SPACE	N/A (COMMERCIAL)	N/A	N/A
BUFFERS	NORTH - 10' ARTERIAL/COLLECTOR STREET BUFFER EAST - 40' HIGH-DENSITY BUFFER WITH 50% REDUCTION TO 20' ON THE NORTHERN BLOCK SOUTH/WEST - NONE	N/A	NORTH - 10' ARTERIAL/COLLECTOR STREET BUFFER EAST - 40' HIGH-DENSITY BUFFER WITH 50% REDUCTION TO 20' ON THE NORTHERN BLOCK SOUTH/WEST - NONE
TREE CANOPY	RETAIN 20% OF EXISTING CANOPY	2.47 AC.	2.51 AC. (20.1%)
SITE CANOPY	PROVIDE 30% COVERAGE	3.70 AC.	3.81 AC. (30.5%)
PARKING	CARWASH = 1 PER SERVICE BAY; PLUS 3 STACKING SPACE RETAIL = MIN 5 / 1000 SF; MAX 5.5 / 1000 SF	CARWASH = 1 PLUS 3 STACKING SPACES RETAIL = MIN. 29 SPACES / MAX. 32 SPACES	CARWASH = 17 SPACES AND 3 STACKING SPACES SHARED PARKING BETWEEN ALL PROPOSED AND FUTURE USES = 59 SPACES
BICYCLE PARKING	1 PER 10 SPACES	9 SPACES	10 SPACES (5 RACKS)
MOTORCYCLE PARKING	1 PER 40 SPACES	2 SPACES	3 SPACES

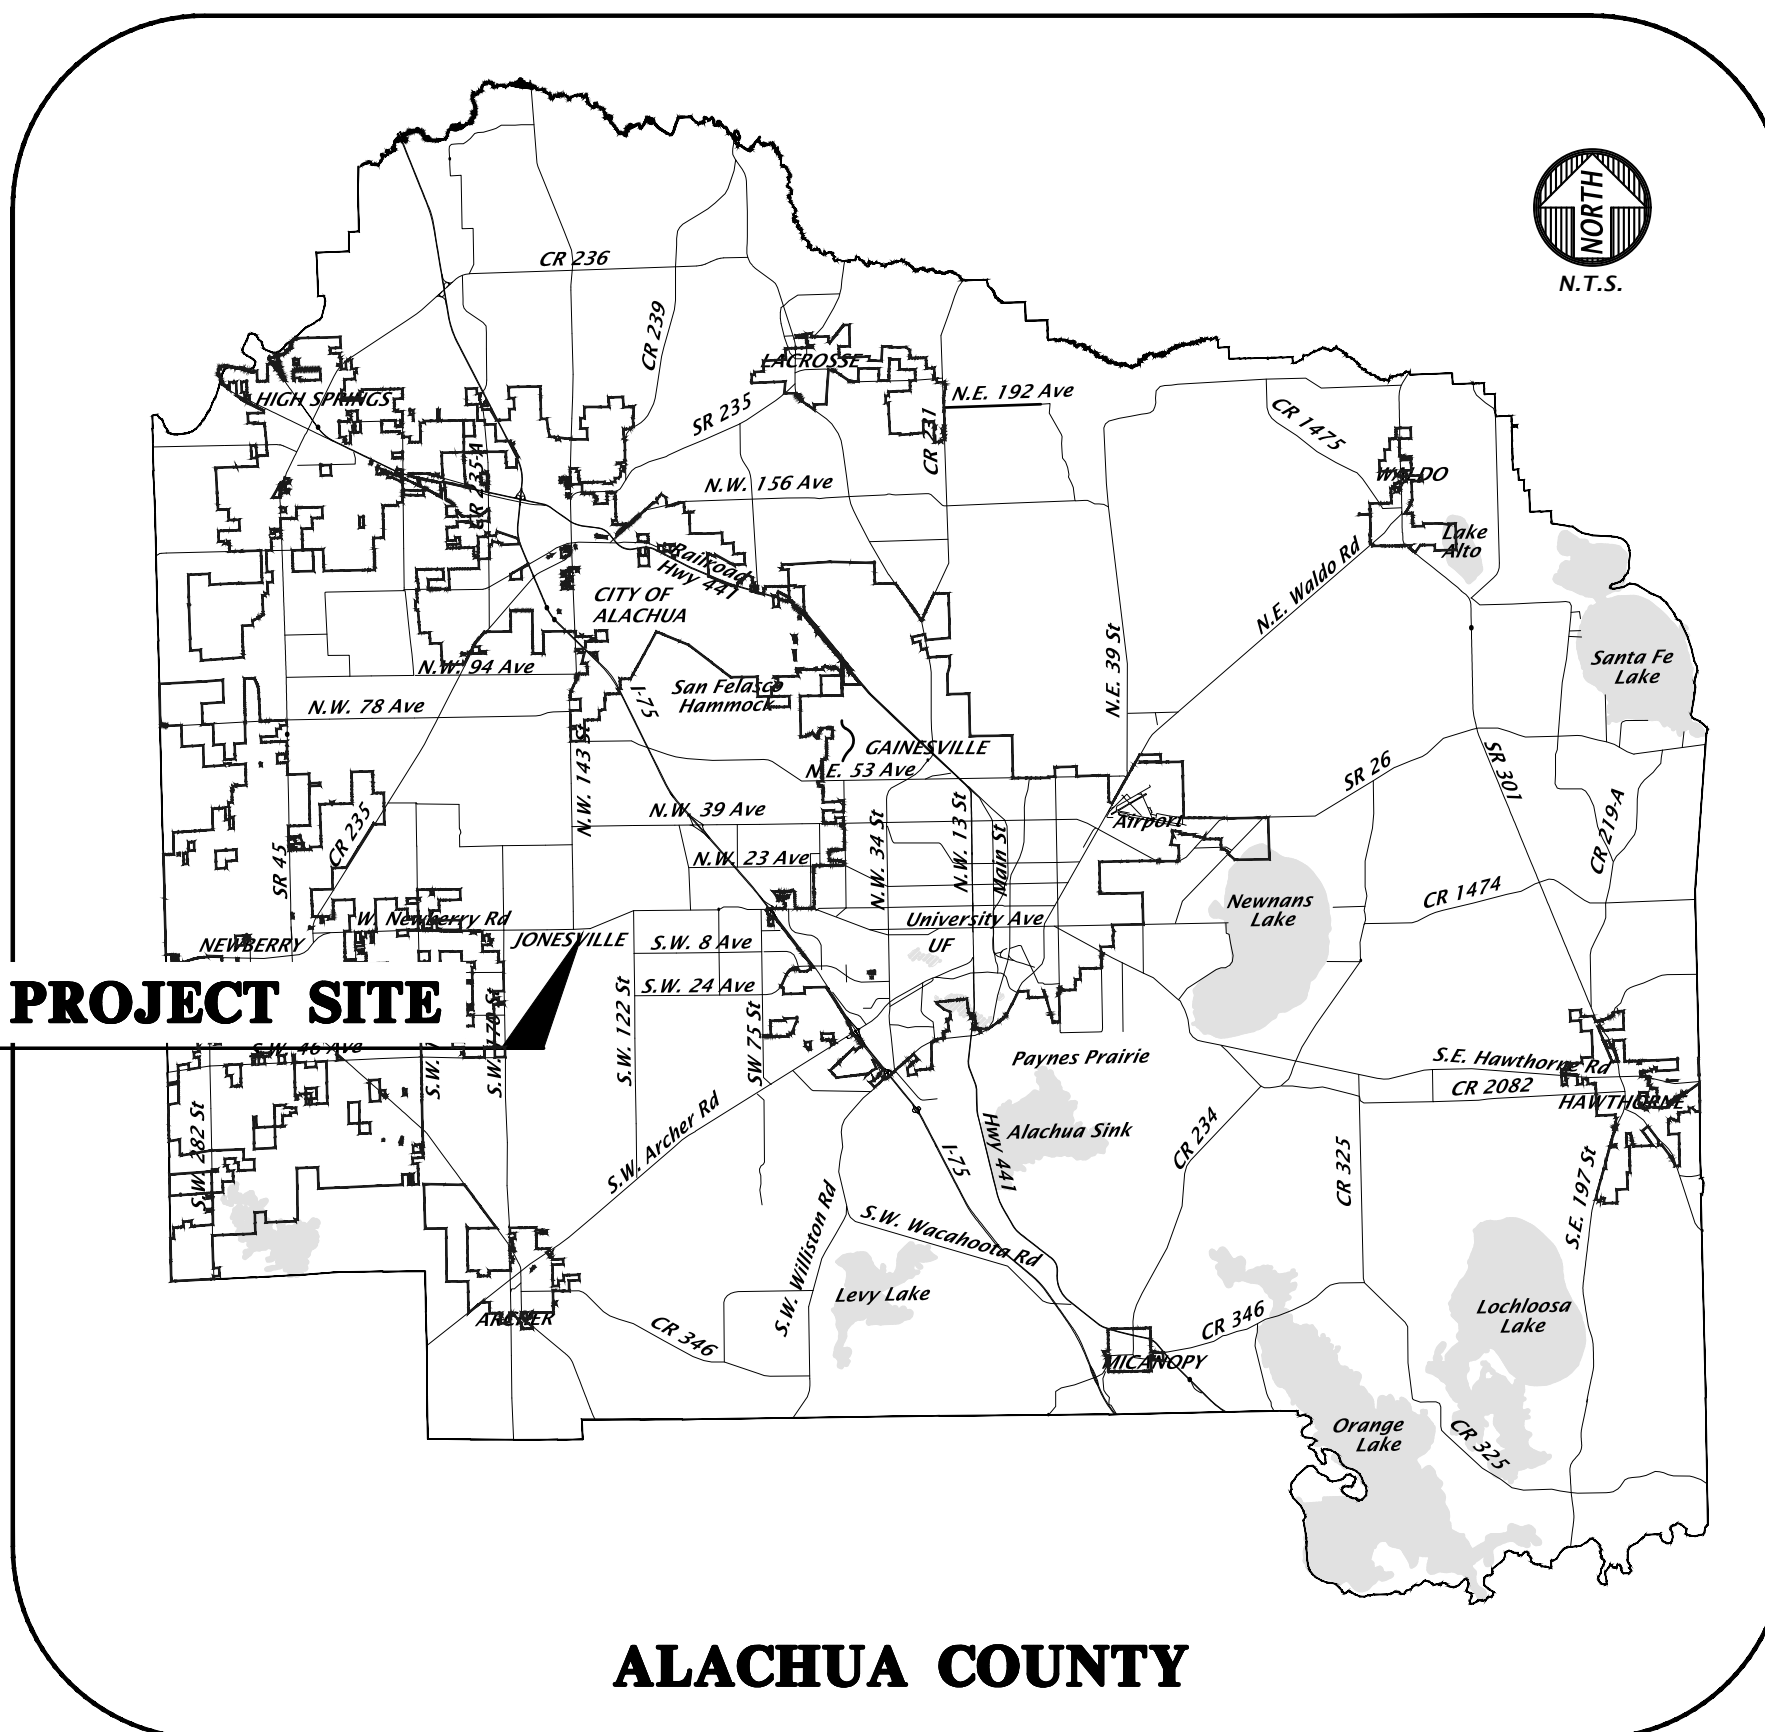

**BEFORE YOU DIG!**  
 CALL SUNSHINE STATE ONE CALL OF FLORIDA  
 AT LEAST TWO FULL BUSINESS DAYS BEFORE  
 DIGGING OR DISTURBING EARTH

1-800-432-4770 Know what's below. Call before you dig.

**GRU NOTIFICATIONS**

- NOTIFY GRU WASTEWATER ENGINEERING 48 HOURS PRIOR TO CONSTRUCTION AT 352-393-1633; IF PROPER NOTIFICATION IS NOT MADE, CONTRACTOR IS SUBJECT TO STOP WORK ORDER.
- NOTIFY GRU ELECTRIC INSPECTIONS 48 HOURS PRIOR TO CONSTRUCTION AT 352-339-0430; IF PROPER NOTIFICATION IS NOT MADE, CONTRACTOR IS SUBJECT TO BE SHUT DOWN.

**FOR REVIEW ONLY**  
**GRU CERTIFICATION**  
 THE WATER & WASTEWATER SYSTEM DESIGN IS IN ACCORDANCE WITH CURRENT GRU DESIGN STANDARDS.

DATE: \_\_\_\_\_

Title: gmp For Date: Oct 23, 2023 4:33pm Filename: N:\2023\11-0571\Department\GA\_Engineering\02\_DWG\Production\Flm\31-0571\_CV.dwg

11801 Research Drive  
 Alachua, Florida 32615  
 (352) 331-1976  
 www.chw-inc.com

**CHW**  
 Professional Consultants

est. 1988 FLORIDA CA-5075

N/A

VERIFY SCALE  
 BAR IS ONE INCH ON  
 ORIGINAL DRAWING  
 IF NOT ONE INCH ON  
 SCALES ACCORDINGLY.

CONSTRUCTION AND REVISIONS:

SUBMITTALS:  
 6/5/23 - SUBMITTAL TO ALACHUA COUNTY, GRU, FOOT, AND SRWMD  
 7/31/23 - SUBMITTAL TO ALACHUA COUNTY, GRU, FOOT, AND SRWMD  
 10/10/23 - SUBMITTAL TO ALACHUA COUNTY  
 10/23/23 - BID SET

CLIENT: FLETCHER DEVELOPMENT  
 PROJECT: FLETCHER CENTER EAST  
 SHEET TITLE: COVER SHEET AND INDEX  
 PROJECT NUMBER: 21-0571

TECHNICIAN: G. WADZANSKI  
 DESIGNER: G. LEDFORD, E.I.  
 QUALITY CONTROL: D. YOUNG, P.E.  
 PROJECT NUMBER: 21-0571

Daniel H. Young, P.E.  
 State of Florida, Professional Engineer, License No. 78788  
 This item has been digitally signed and sealed by Daniel H. Young, P.E. on the date indicated here: 10/26/2023  
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FL PE No. 70780  
 SHEET NO. **C0.00**






### ABBREVIATIONS

SYMBOLS		N	
'	FEET (WHEN USED WITH LENGTHS)	N	NORTH
°	DEGREES	N-E	NORTHING - EASTING
'	MINUTES (WHEN USED WITH ANGLES)	N/A	NOT APPLICABLE
"	SECONDS	NAVD	NORTH AMERICAN VERTICAL DATUM OF 1988
%	PERCENT	NGVD	NATIONAL GEODETIC VERTICAL DATUM OF 1929
@	AT	NO	NUMBER
		NPDES	NATIONAL POLLUTANT DISCHARGE ELIMINATION SYSTEM
		NTS	NOT TO SCALE
		O	ON CENTER
		OC	OVERHEAD WIRE
		OHW	OFFICIAL RECORDS BOOK
		ORB	OCCUPATIONAL SAFETY AND HEALTH ADMINISTRATION
		OSHA	
		P	PAVEMENT
		PAVT	POINT OF CURVATURE
		PC	POINT OF COMPOUND CURVE
		PCC	POLYETHYLENE
		PE	PERFORATED
		PERF	POST INDICATOR VALVE
		PIV	PROPOSED
		PROP	POINT OF TANGENCY
		PT	POLYVINYL CHLORIDE
		PVC	PUBLIC UTILITY EASEMENT
		PUE	POINT OF VERTICAL INTERSECTION
		PVI	
		R	RADIUS
		R	REINFORCED CONCRETE PIPE
		RCP	RAISED REFLECTIVE PAVEMENT MARKER
		RFM	REDUCED PRESSURE ZONE
		RZ	RIGHT
		RT	RECLAIMED WATER MAIN
		RWM	RIGHT-OF-WAY
		R/W	
		S	SOUTH
		S	SANITARY
		SAN	SEASONAL HIGH WATER ELEVATION
		SHWE	SILT FENCE
		SL	SLOPE
		SP	SUPERPAVE
		SR	STATE ROAD
		SS	SANITARY SEWER
		ST	STORM
		STA	STATION
		STD	STANDARD
		T	TREE BARRICADE
		TB	TEMPORARY CONSTRUCTION EASEMENT
		TCE	TEMP
		TEMP	TOP OF BANK
		TOB	TELEVISION
		TV	TOP OF WALL
		TW	TYPICAL
		TYP	
		U	UNITED STATES FOUNDRY
		USF	UNITED STATES GEOLOGICAL SURVEY
		USGS	UTILITY
		UTIL	
		V	VERTICAL
		V	VERTICAL CURVE
		VC	VITRIFIED CLAY PIPE
		VCP	
		W	WEST
		W	WATER
		W	WITH
		W/	WATER MAIN
		WM	WASTEWATER
		WW	WELDED WIRE FABRIC
		WWF	
		G	GALVANIZED
		GALV	GAS MAIN
		GM	GATE VALVE
		GV	
		H	HIGH DENSITY POLYETHYLENE
		HDPE	HIGH POINT
		HP	
		I	IDENTIFICATION
		ID	INVERT
		INV	INVERT ELEVATION
		INV EL	IRON PIPE
		IP	
		K	VERTICAL CURVE RATE OF CHANGE
		L	LENGTH
		L	LANDSCAPE ARCHITECT
		LA	LIMEROCK BEARING RATIO
		LBR	LAND DEVELOPMENT REGULATION
		LDR	LINEAR FEET
		LF	LOW POINT
		LP	LEFT
		LT	
		M	MAXIMUM
		MAX	MATCH EXISTING
		ME	MANHOLE
		MH	MINIMUM
		MIN	MISCELLANEOUS
		MISC	MECHANICAL JOINT
		MJ	MANUAL ON UNIFORM TRAFFIC CONTROL DEVICES
		MUTCD	

### SIGNAGE


SIGNS ARE PER FDOT SPECIFICATIONS OR PER MUTCD. SIGN POSTS AND INSTALLATION SHALL BE PER FDOT INDEX NO. 700-010. SIGN PLACEMENT SHALL BE PER FDOT INDEX NO. 700-101.

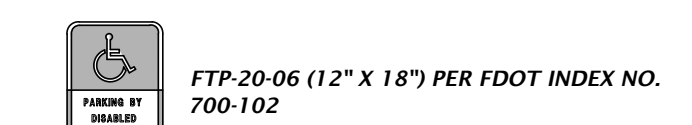

FTP-20-06 (12" x 18") PER FDOT INDEX NO. 700-102


R1-1 "STOP" - SEE PLANS FOR SIZE

### SITE INFORMATION

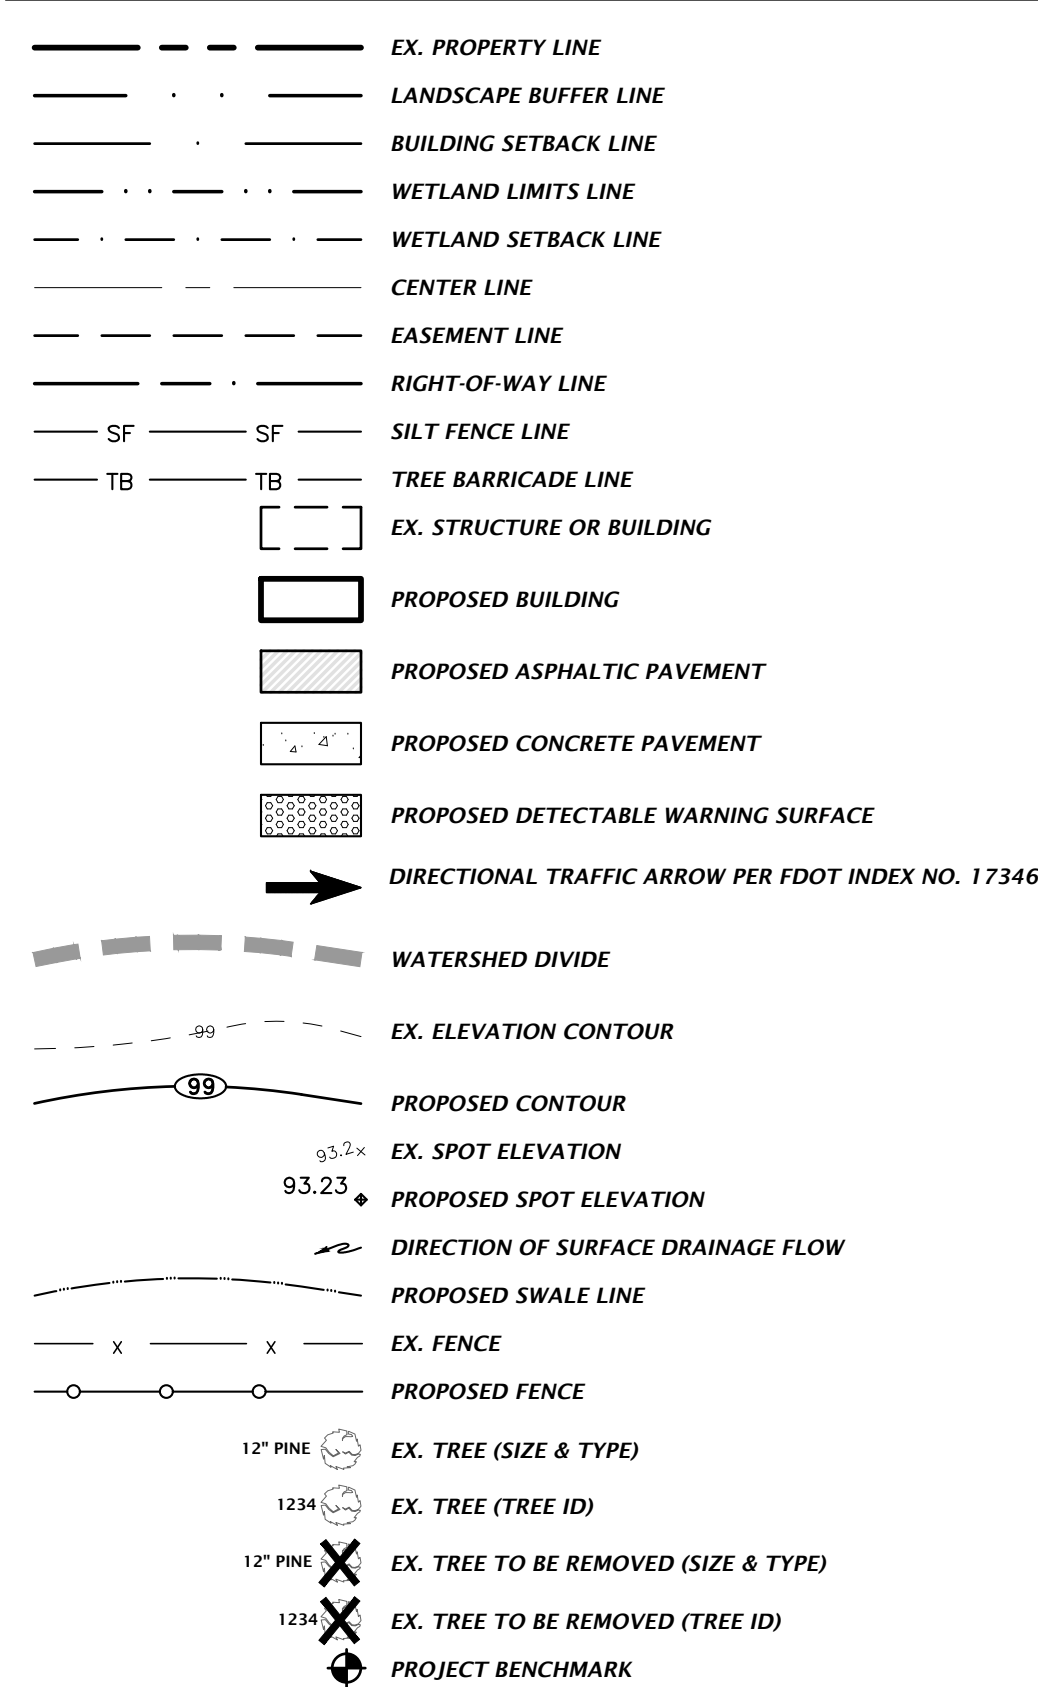


### STORMWATER


THE PROPOSED STORMWATER STRUCTURES DEPICTED BELOW ARE DRAWN PER FDOT SPECIFICATIONS AND TO SCALE WHEN SHOWN ON THE PLAN SHEETS.

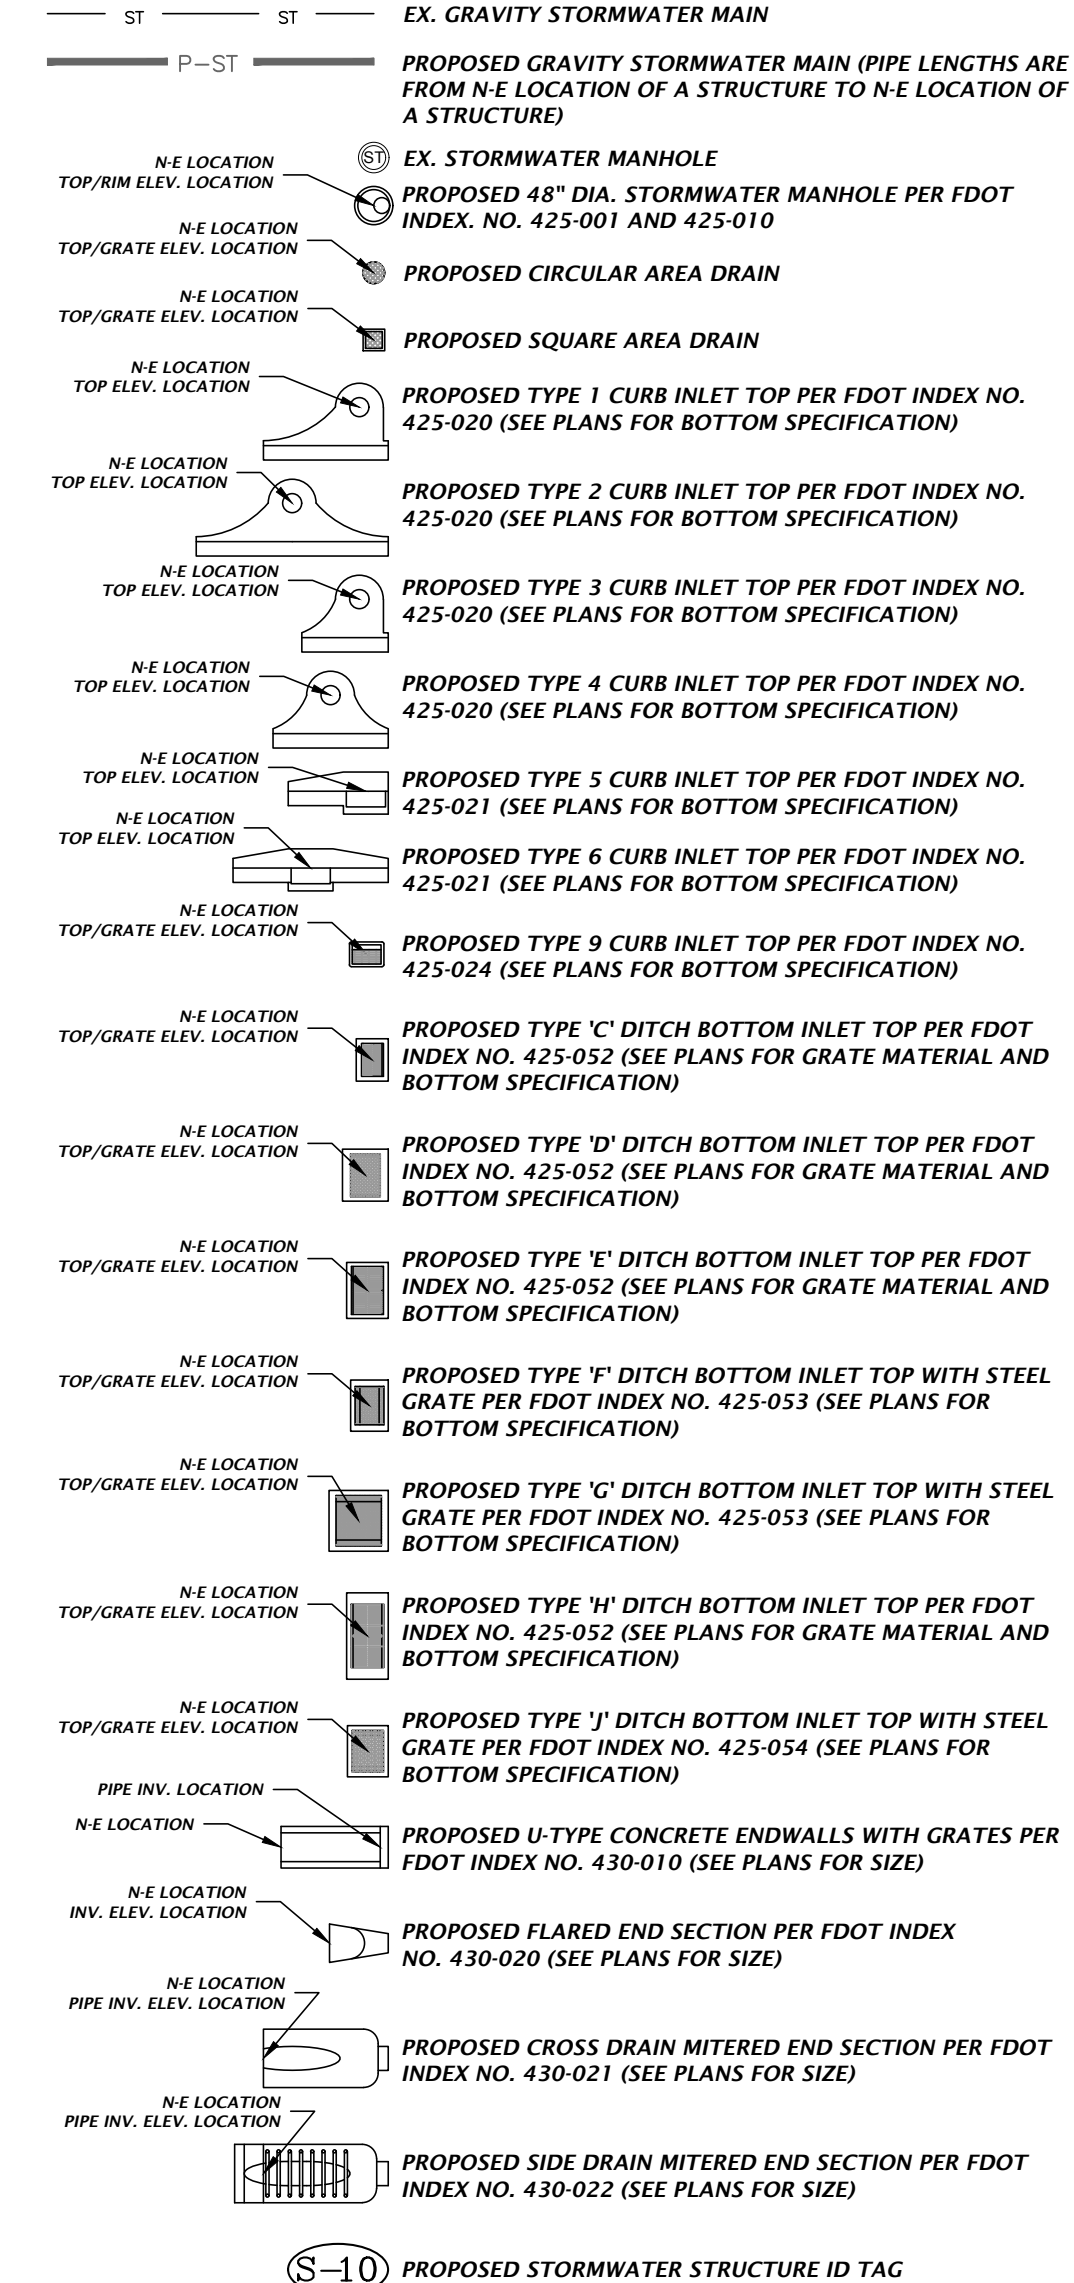


### POTABLE AND RECLAIMED WATER

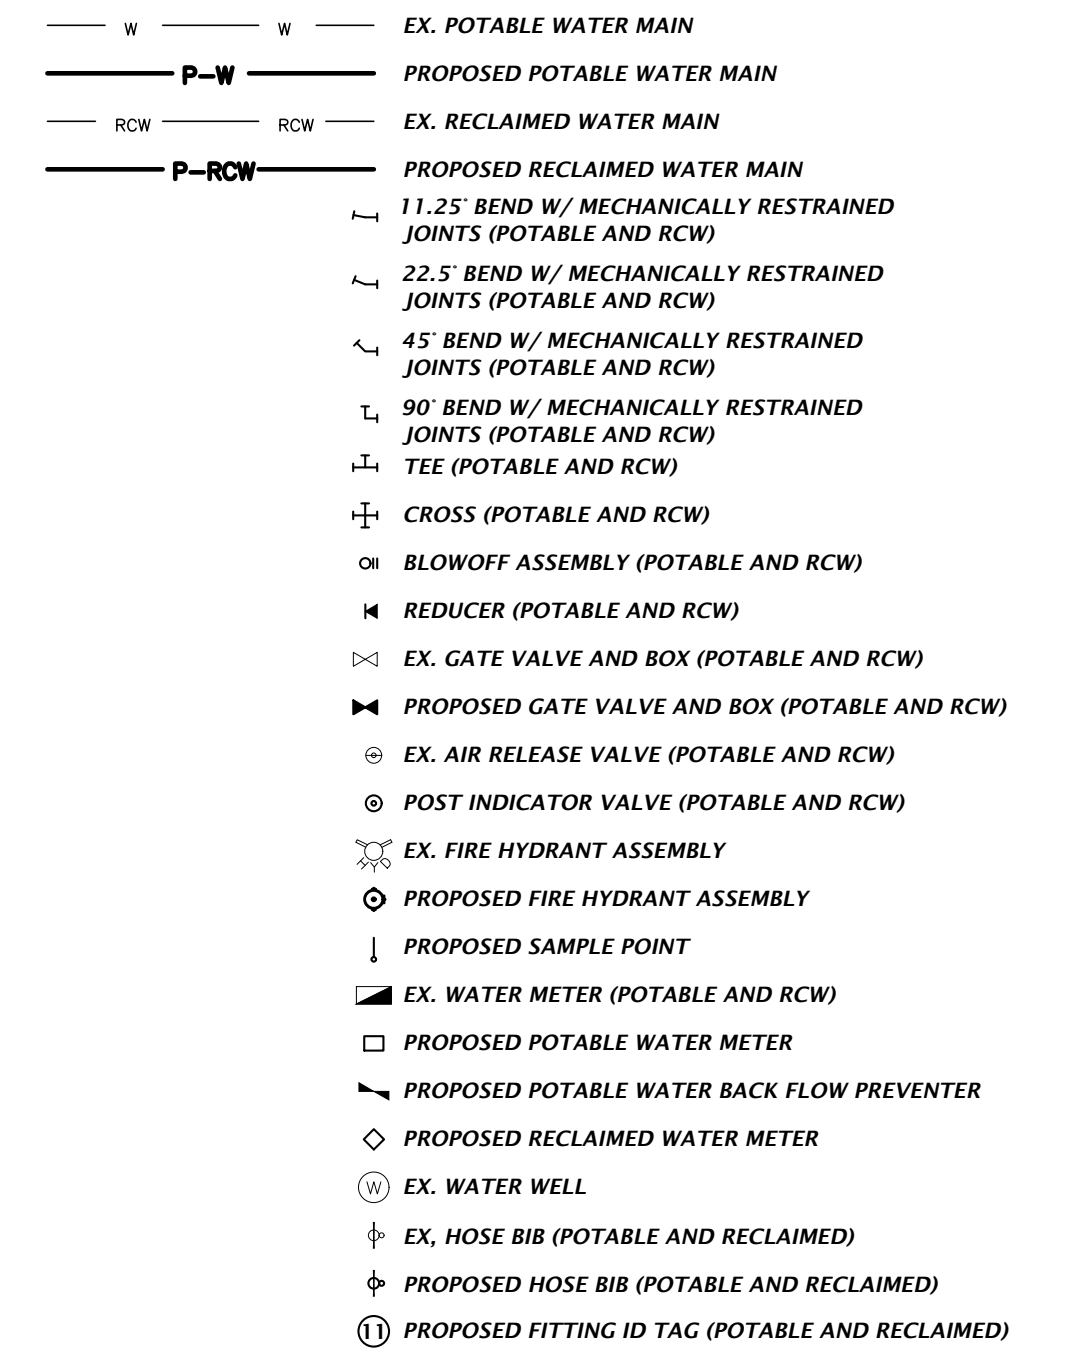

### WASTEWATER

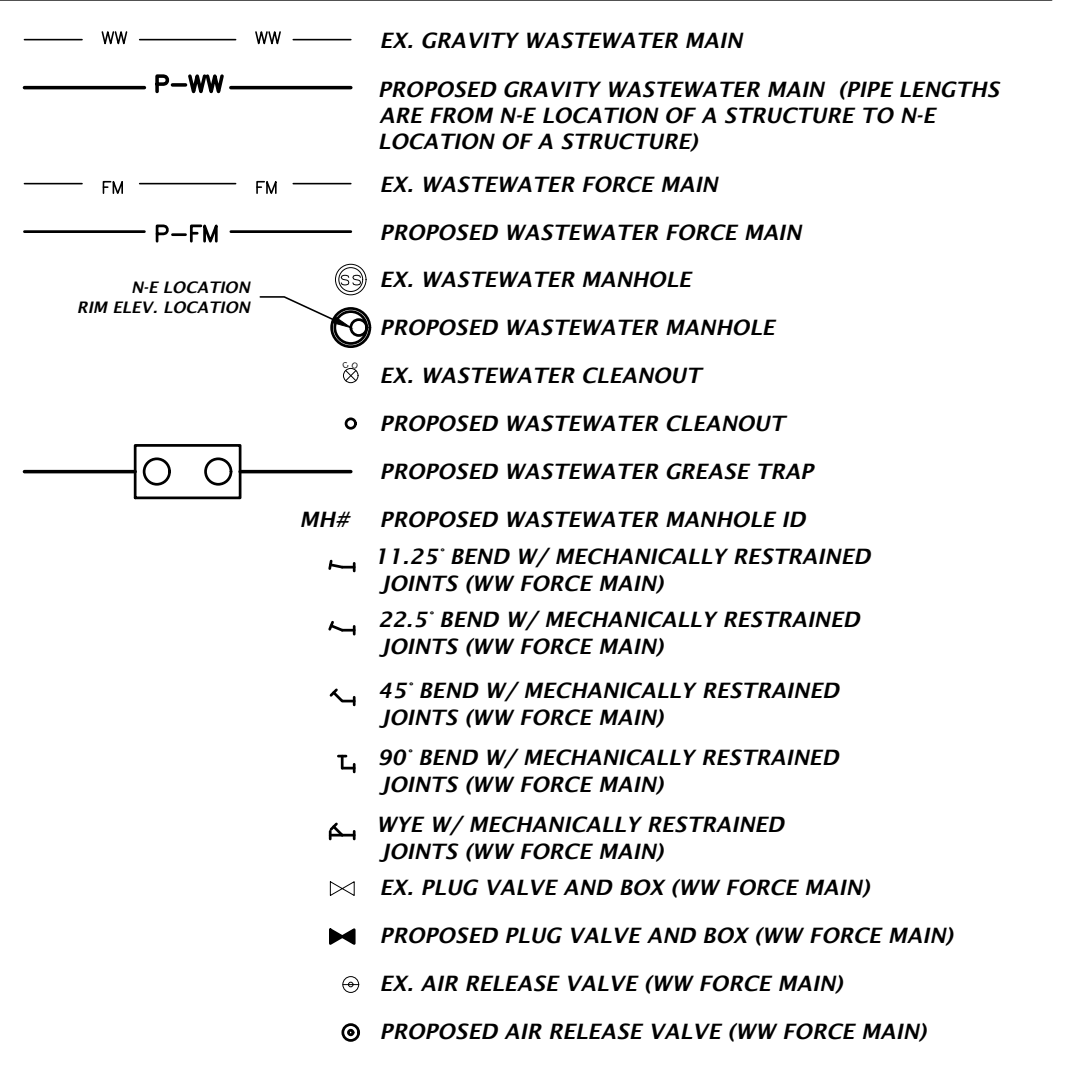

### MISCELLANEOUS UTILITIES

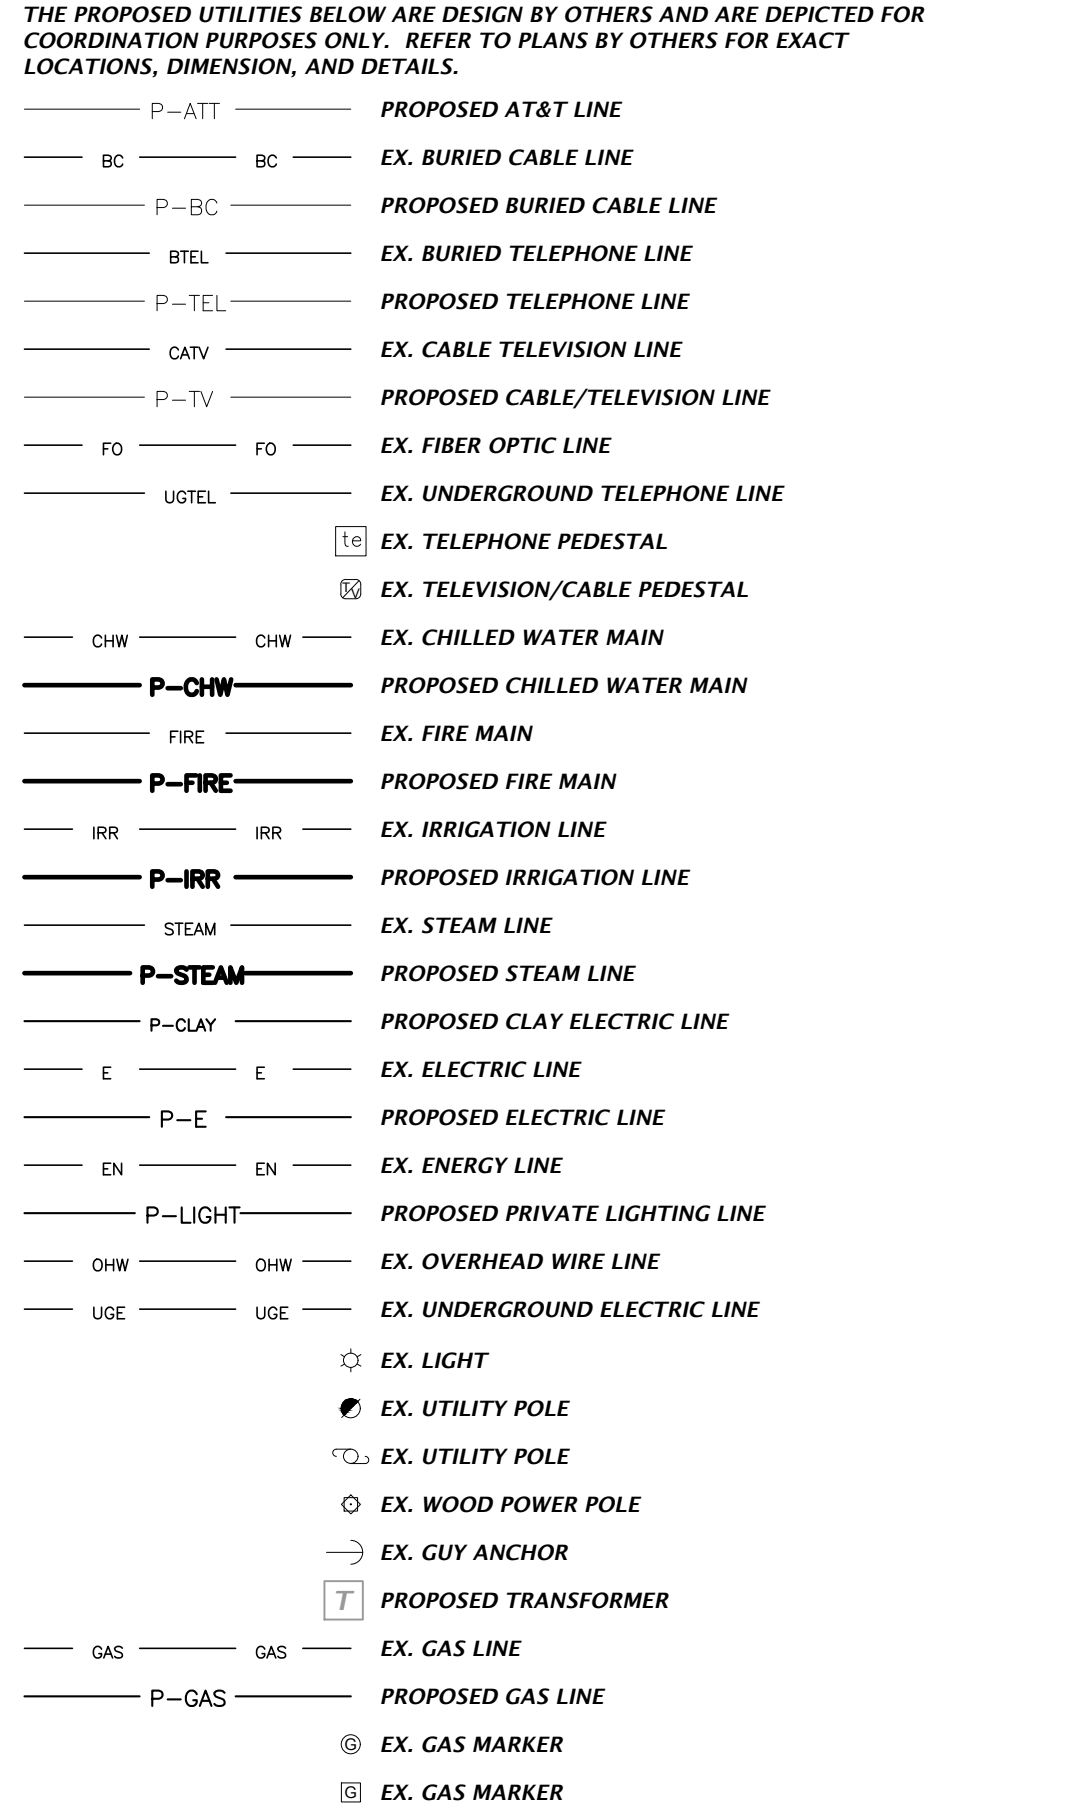

NOTES:  
 1. THIS LEGEND IS ALL INCLUSIVE AND MAY INCLUDE ITEMS NOT A PART OF THIS PLAN SET.  
 2. SYMBOLS SHOWN ON THIS SHEET ARE FOR ILLUSTRATIVE PURPOSES ONLY. UNLESS NOTED OTHERWISE, SYMBOLS IN THESE PLANS MAY NOT BE REPRESENTATIVE OF SIZE.

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CONSTRUCTION REVISIONS

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 QUALITY CONTROL: D. YOUNG, P.E.  
 PROJECT NUMBER: 21-0571

CLIENT: FLETCHER DEVELOPMENT  
 PROJECT: FLETCHER CENTER EAST  
 SHEET TITLE: LEGEND

DATE: DANIEL H. YOUNG  
 State of Florida, Professional Engineer, License No. 78780

This item has been digitally signed and sealed by Daniel H. Young, P.E., on the date indicated here: 10/26/2023

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FL PE No. 70780  
 SHEET NO. C0.11

I. INTRODUCTION

THIS DOCUMENT WAS PREPARED IN ORDER TO ILLUSTRATE COMPLIANCE WITH CHAPTER 62-621.300 (4) OF THE FLORIDA ADMINISTRATIVE CODE, WHICH PERTAINS TO THE GENERIC PERMIT FOR STORMWATER DISCHARGE FROM LARGE AND SMALL CONSTRUCTION ACTIVITIES...

II. SITE DESCRIPTION

COUNTY: ALACHUA COUNTY, FLORIDA
SECTION, TOWNSHIP, RANGE: SECTIONS 3, TOWNSHIP 10 SOUTH, RANGE 18 EAST
COUNTY PARCEL NO.: 04344-003-000; 04344-009-000; AND 04345-011-000

A. NATURE OF CONSTRUCTION ACTIVITY

THE PROPOSED DEVELOPMENT INCLUDES THE CONSTRUCTION OF A MIXTURE OF COMMERCIAL USES THAT INCLUDES RETAIL SPACE, A CAR WASH, AND A FUTURE QUICK SERVICE RESTAURANT WITH ASSOCIATED STORMWATER MANAGEMENT FACILITIES, UTILITY INFRASTRUCTURE, AND RELATED IMPROVEMENTS...

B. SEQUENCE OF MAJOR SOIL DISTURBING ACTIVITIES - CONTRACTOR MUST FILL IN DAYS

FROM \_\_\_\_\_ TO \_\_\_\_\_ PRIOR TO CONSTRUCTION, SILT FENCING AND TREE PROTECTION FENCING SHALL BE INSTALLED AND ALL EXISTING STORM DRAINAGE SWALE AND INLETS SHALL BE PROTECTED IN ACCORDANCE WITH THE STATE OF FLORIDA EROSION AND SEDIMENT CONTROL DESIGNER AND REVIEWER MANUAL, DATED JULY 2013, AND THESE PLANS.

C. SITE DEVELOPMENT DATA:

TOTAL PROJECT SITE AREA: 12.51 ACRES
TOTAL SITE AREA TO BE DISTURBED: 5.90 ACRES
TOTAL IMPERVIOUS AREA (AS SHOWN IN CONSTRUCTION DRAWINGS): 3.09 ACRES

D. SOIL CONDITIONS AND STORMWATER QUALITY

THE NRCS DATA FOR THE SITE REVEALS THAT THE SITE SOILS ARE COMPRISED OF ARREDONDO FINE SAND (0 TO 5 PERCENT SLOPE), KENDRICK FINE SAND (2 TO 5 PERCENT SLOPE), AND NORFOLK LOAMY FINE SAND (2 TO 4 PERCENT). GSE ENGINEERING & CONSULTING, INC. CONDUCTED A GEOTECHNICAL EXPLORATION OF THE PROPOSED STORMWATER MANAGEMENT FACILITY(S) LOCATION IN APRIL OF 2023.

ELEVATION OF EFFECTIVE OR MOBILIZED AQUIFER: GREATER THAN 30 FEET (MGVD29)
ELEVATION OF SEASONAL HIGH WATER TABLE: 45 FEET (MGVD29)
HORIZONTAL HYDRAULIC CONDUCTIVITY: 3.7 FEET/DAY
UNSATURATED VERTICAL INFILTRATION: 2.5 FEET/DAY

DESIGN PERCOLATION RATES FOR THE STORMWATER MANAGEMENT FACILITY(S) WERE DETERMINED BASED ON LABORATORY PERMEABILITY TEST RESULTS FROM BORING SAMPLES TAKEN WITHIN THE LIMITS OF THE STORMWATER MANAGEMENT FACILITY(S).

THE STORMWATER MANAGEMENT FACILITY(S) WAS DESIGNED TO PROVIDE RATE AND VOLUME CONTROL AND WATER QUALITY TREATMENT OF THE STORMWATER RUNOFF RESULTING FROM THE POST-DEVELOPMENT SITE UNDER 100-YEAR CRITICAL STORM EVENT RAINFALL CONDITIONS. THE STORMWATER POLLUTION PREVENTION PLAN (CO.21) DEPICTS THE POST-DEVELOPMENT WATERSHED(S) LIMITS AND THE TABLE BELOW SUMMARIZES EACH WATERSHED.

Table with 7 columns: WATERSHED ID, POST DEVELOPMENT AREA (ACRES), POST DEVELOPMENT RUNOFF FACTOR (CW), POST DEVELOPMENT IMPERVIOUS AREA (ACRES), STORMWATER MANAGEMENT FACILITY TYPE, FACILITY DETENTION CAPACITY (ACRE-FEET), 100-YEAR FLOOD ELEVATION (FT)

E. SITE MAP

PLEASE SEE THE STORMWATER POLLUTION PREVENTION PLAN (CO.21) FOR DETAILS.

F. STORMWATER OUTFALL LOCATION AND RECEIVING WATER BODY

IN THE CASE EXTREME STORM EVENTS BEYOND THE DESIGN STORM, THE WATER WOULD BE RECEIVED BY THE ALACHUA COUNTY MS4. THE SMF IS DESIGNED TO FULLY RETAIN ALL DESIGN STORM EVENTS.

III. CONTROLS TO REDUCE POLLUTION

AS OUTLINED IN THE SUWANNEE RIVER WATER MANAGEMENT DISTRICT (SRWMD) PERMIT, ALL CONSTRUCTION ACTIVITIES SHALL BE CONDUCTED IN A MANNER AS TO NOT VIOLATE STATE WATER QUALITY STANDARDS. PRIOR TO CONSTRUCTION, THE CONTRACTOR SHALL IMPLEMENT AND MAINTAIN ALL EROSION AND SEDIMENT CONTROL MEASURES REQUIRED TO RETAIN SEDIMENT ON-SITE.

IV. EROSION AND SEDIMENT CONTROLS

A. STABILIZATION PRACTICES

EXISTING TREES AND NATURAL VEGETATION TO REMAIN ON-SITE SHALL BE PROTECTED BY TREE BARRICADE FENCING AS DEPICTED ON THE STORMWATER POLLUTION PREVENTION PLAN (CO.21 - CO.23). TYPE III SILT FENCING SHALL PROTECT ALL DRAINAGE STRUCTURES AND SHALL BUFFER AREAS WITH POTENTIAL TO CONTRIBUTE OFF-SITE RUNOFF AND AS SPECIFICALLY DEPICTED ON THE STORMWATER POLLUTION PREVENTION PLAN (CO.21).

B. STRUCTURE PRACTICES

AS DEPICTED IN THE STORMWATER POLLUTION PREVENTION PLAN (CO.21 - CO.23), A STORMWATER MANAGEMENT SYSTEM WILL BE CONSTRUCTED AND WILL BE COMPRISED OF ONE DRY RETENTION FACILITY AND A STORM PIPE CONVEYANCE SYSTEM. TO PREVENT EROSION DURING CONSTRUCTION, TYPE III SILT FENCING WILL BE INSTALLED IN THE LOCATIONS SHOWN ON THE PLANS.

C. DRAINAGE LOCATIONS THAT SERVE AREAS WITH LESS THAN 10 DISTURBED ACRES

AS SPECIFIED IN THE "SEQUENCE OF MAJOR SOIL DISTURBING ACTIVITIES," THE SMF(S) WILL BE CONSTRUCTED PRIOR TO CLEARING AND GRUBBING OUTSIDE OF THE SMF(S) AREAS AND CONSTRUCTION OF THE PERMANENT PAVED AREAS. THE TOTAL CONTRIBUTING DRAINAGE AREA TO THE STORMWATER MANAGEMENT SYSTEM IS APPROXIMATELY 12.02 ACRES AND WILL CONSIST OF APPROXIMATELY 5.90 ACRES OF DISTURBED CONSTRUCTION AREA.

D. DRAINAGE LOCATIONS THAT SERVE AREAS WITH MORE THAN 10 DISTURBED ACRES

NOT APPLICABLE, SEE SECTION C, ABOVE.

V. STORMWATER MANAGEMENT

A. BEST MANAGEMENT PRACTICES

AFTER CONSTRUCTION, THE STORMWATER MANAGEMENT SYSTEM SHALL BE MAINTAINED IN ACCORDANCE WITH THE SPECIFIED STORMWATER MAINTENANCE NOTES IN THE INCLUDED CONSTRUCTION DRAWINGS AND/OR RESPECTIVE MAINTENANCE REPORTS. SPECIFICALLY, THE PROPOSED SMF(S) SHALL BE MOWED REGULARLY IN THE SPECIFIED AREAS.

B. VEGETATED SWALES

WHEN VEGETATED SWALES ARE UTILIZED, SILT FENCING OR EQUIVALENT SEDIMENT CONTROLS SHALL BE INSTALLED AT ADEQUATE INTERVALS TO COLLECT SEDIMENT ALONG THE SWALE. THE SEDIMENT SHALL BE REMOVED WHEN SEDIMENT REACHES ONE-THIRD OF THE HEIGHT OF THE SILT FENCING.

C. VELOCITY DISSIPATION DEVICES AT DISCHARGE POINTS

WHEN DISCHARGE POINTS ARE NOT LOCATED UNDER WATER, RIP RAP PADS HAVE BEEN PROVIDED AT LOCATIONS WHERE NECESSARY DUE TO ANTICIPATED DISCHARGE VELOCITIES. PLEASE SEE THE CONSTRUCTION PLANS FOR DETAILS AND LOCATIONS, AS NEEDED.

VI. CONTROLS FOR OTHER POTENTIAL POLLUTANTS

A. WASTE DISPOSAL

THE CONTRACTOR SHALL PROVIDE LITTER COLLECTION CONTAINERS WITHIN THE PROJECT BOUNDARIES DURING CONSTRUCTION. CONTRACTOR SHALL DISPOSE OF ALL UNSUITABLE MATERIALS AND CONSTRUCTION DEBRIS IN ACCORDANCE WITH ALL APPLICABLE LOCAL, STATE, AND FEDERAL REQUIREMENTS.

B. DUST CONTROL

TO PREVENT OFF-SITE VEHICULAR TRACKING OF SEDIMENTS AND DUST GENERATION, A STABILIZED CONSTRUCTION ENTRANCE SHALL BE ESTABLISHED BY THE SITE CONTRACTOR. PLEASE SEE THE STORMWATER POLLUTION PREVENTION PLAN (CO.21) FOR DETAILS AND LOCATIONS.

C. EXISTING VERSUS PROPOSED POTABLE AND SANITARY SEWER SYSTEMS

THERE ARE EXISTING SANITARY SEWER AND POTABLE WATER SYSTEMS LOCATED NEAR THE PROJECT SITE. EXTENSION AND UPGRADES ARE PROPOSED. IF TEMPORARY SANITARY SYSTEMS ARE UTILIZED DURING CONSTRUCTION, THE CONTRACTOR SHALL PROPERLY CONTROL AND DISCHARGE ANY SANITARY WASTE IN ACCORDANCE WITH ALL APPLICABLE LOCAL, STATE, AND FEDERAL REGULATIONS.

D. FERTILIZER & PESTICIDES

THE USE OF FERTILIZERS, HERBICIDES, AND PESTICIDES ON THE PROJECT SITE, WILL BE DIRECTED BY THE LANDSCAPE PLAN AND THE FDOT STANDARD SPECIFICATIONS SECTION 570, TO SUPPORT THE GROWTH OF THE PROPOSED VEGETATION. ESTABLISHING THIS VEGETATION WILL AID IN THE STABILIZATION OF THE PROJECT SITE AND REDUCE EROSION.

E. TOXIC MATERIAL

THE CONSTRUCTION SITE WILL BE IN FULL COMPLIANCE WITH STATE AND FEDERAL REQUIREMENTS. A PLASTIC MAT, TAR PAPER, OR OTHER IMPERVIOUS MATERIAL SHALL BE PLACED UNDER AREAS WHERE TOXIC LIQUIDS ARE TO BE OPENED AND STORED.

F. HAZARDOUS MATERIALS

ALL HAZARDOUS MATERIALS SHALL BE STORED IN A SECURE LOCATION, UNDER COVER, AND IN APPROPRIATE TIGHTLY, SEALED CONTAINERS WHEN NOT IN USE. ALL PRODUCTS SHALL BE STORED IN AND USED FROM THE ORIGINAL CONTAINER WITH THE ORIGINAL PRODUCT LABEL.

ALL PRODUCTS SHALL BE USED IN STRICT COMPLIANCE WITH THE INSTRUCTIONS ON THE PRODUCT LABEL.

SUFFICIENT EQUIPMENT AND/OR MATERIALS SHALL BE KEPT ONSITE TO CONTAIN AND CLEAN UP SPILLS OF HAZARDOUS MATERIALS IN THE AREAS WHERE THESE MATERIALS ARE STORED OR USED. SPILL CONTROL AND CONTAINMENT KIT SUPPLIES SHALL BE OF SUFFICIENT QUANTITIES AND APPROPRIATE CONTENT TO CONTAIN A SPILL FROM THE LARGEST ANTICIPATED PIECE OF EQUIPMENT AND FROM THE LARGEST ANTICIPATED QUANTITIES OF PRODUCTS STORED ON THE SITE AT ANY GIVEN TIME.

CONTRACTOR TO CONTAIN AND CLEAN UP ANY SPILLS IMMEDIATELY AFTER THEY OCCUR. ANY SPILLS OF PETROLEUM PRODUCTS OR HAZARDOUS MATERIALS IN EXCESS OF REPORTABLE QUANTITIES AS DEFINED BY EPA, STATE, OR LOCAL AGENCY REGULATIONS SHALL BE REPORTED TO THE APPROPRIATE AGENCIES IN THE REQUIRED TIME FRAMES.

ALL EXCESS, USED, OR SPILLED PRODUCTS, INCLUDING CONTAMINATED SOIL, SHALL BE DISPOSED OF BY THE CONTRACTOR IN STRICT COMPLIANCE WITH INSTRUCTIONS ON THE PRODUCT LABEL AND ALL APPLICABLE REGULATIONS.

VII. APPROVED STATE AND LOCAL PLANS

THE CONSTRUCTION DRAWINGS FOR THE PROJECT WERE APPROVED AND PERMITTED BY THE FOLLOWING AGENCIES:
\* ALACHUA COUNTY
\* SUWANNEE RIVER WATER MANAGEMENT DISTRICT
\* FLORIDA DEPARTMENT OF ENVIRONMENTAL PROTECTION

VIII. CONSTRUCTION ACTIVITY DISCHARGES

IN ACCORDANCE WITH THIS PLAN, THERE ARE NO ANTICIPATED DISCHARGES OF STORMWATER ASSOCIATED WITH CONSTRUCTION ACTIVITIES.

IX. CHANGES TO THE POLLUTION PREVENTION PLAN

THIS STORMWATER POLLUTION PREVENTION PLAN SHALL BE AMENDED TO REFLECT ANY APPLICABLE CHANGE IN A STATE, REGIONAL, OR LOCAL PERMIT FOR WHICH THE PERMITTEE RECEIVES WRITTEN NOTICE. WHEN WRITTEN NOTICE IS RECEIVED, THE PERMITTEE SHALL PROVIDE A RE-CERTIFICATION OF THIS POLLUTION PREVENTION PLAN, WHICH HAS BEEN REVISED TO ADDRESS SUCH CHANGES.

X. ALTERNATIVE PERMIT REQUIREMENTS

NO ALTERNATIVE PERMIT REQUIREMENTS ARE REQUESTED.

XI. MAINTENANCE

THE CONTRACTOR IS RESPONSIBLE FOR THE MAINTENANCE, INSPECTION SCHEDULE, AND REPAIRS OUTLINED IN THIS PLAN. MAINTENANCE SHALL CONTINUE THROUGHOUT THE PROJECT UNTIL WORK IS COMPLETE. THE CONTRACTOR IS RESPONSIBLE FOR REMOVING ALL TEMPORARY EROSION AND SEDIMENT CONTROL DEVICES AFTER CONSTRUCTION IS COMPLETE.

XII. INSPECTIONS

THE CONTRACTOR SHALL INSPECT ALL POINTS OF POTENTIAL DISCHARGE FROM THE PROJECT SITE FOR ALL DISTURBED AREAS ON THE CONSTRUCTION SITE AT LEAST ONCE EVERY SEVEN CALENDAR DAYS AND WITHIN 24 HOURS OF THE END OF A STORM THAT IS 0.50 INCHES OR GREATER. FOR POINTS OF DISCHARGE INTO SURFACE WATERS OF THE STATE OR AN MS4, A QUALIFIED INSPECTOR (PROVIDED BY THE OPERATOR) SHALL PERFORM THE REQUIRED INSPECTIONS.

A. DISTURBED AREAS

ALL DISTURBED AREAS AND AREAS USED FOR MATERIAL STORAGE SHALL BE INSPECTED FOR POLLUTANTS ENTERING THE STORMWATER SYSTEM. THE STORMWATER MANAGEMENT SYSTEM AND EROSION AND SEDIMENT CONTROL MEASURES IDENTIFIED IN THE PLAN SHALL BE INSPECTED TO ENSURE THEY ARE OPERATING CORRECTLY.

B. MAINTENANCE PERFORMANCE

BASED ON THE RESULTS OF THE INSPECTION, ALL MAINTENANCE OPERATIONS NEEDED TO ASSURE PROPER COMPLIANCE WITH THIS PLAN SHALL BE DONE IN A TIMELY MANNER, BUT IN NO CASE LATER THAN 7 DAYS FOLLOWING THE INSPECTION.

C. REPORTING REQUIREMENTS

ALL INSPECTIONS SHALL BE RECORDED ON THE CONSTRUCTION INSPECTION FORM. THIS FORM IS CREATED TO SUMMARIZE THE SCOPE OF THE INSPECTION, THE NAME(S) AND QUALIFICATION OF THE INSPECTOR(S), THE DATE OF INSPECTION, RAINFALL DATA, OBSERVATIONS, THE ACTIONS TAKEN TO CORRECT INCIDENTS OF NON-COMPLIANCE WITH THE PROVISIONS OF THIS PLAN.

XIII. NON-STORMWATER DISCHARGES

IN ADDITION TO STORMWATER RUNOFF, THIS PLAN APPLIES TO RUNOFF FROM IRRIGATION OPERATIONS AND CONSTRUCTION PRACTICES. THIS PLAN DOES NOT PERTAIN TO DISCHARGES FROM FIRE FIGHTING ACTIVITIES.

XIV. CONTRACTORS CERTIFICATION

THE CONTRACTORS OR SUB-CONTRACTORS SHALL PHOTOCOPY AND COMPLETE THE FORM ON THIS PAGE. IT SHALL BE PROVIDED TO THE OWNER AND KEPT ON FILE PURSUANT TO SECTION XV REGARDING PROJECT RECORDS.

XV. RETENTION OF RECORDS

THE PERMITTEE SHALL RETAIN COPIES OF STORMWATER POLLUTION PREVENTION PLANS AND ALL REPORTS REQUIRED BY THIS PERMIT, AND RECORDS OF ALL DATA USED TO COMPLETE THE NOTICE OF INTENT TO BE COVERED BY THIS PERMIT, FOR A PERIOD OF AT LEAST THREE YEARS FROM THE DATE THAT THE SITE IS FINALLY STABILIZED.

THE PERMITTEE SHALL RETAIN A COPY OF THE STORMWATER POLLUTION PREVENTION PLAN AND ALL REPORTS, RECORDS, AND DOCUMENTATION REQUIRED BY THIS PERMIT AT THE CONSTRUCTION SITE, OR AN APPROPRIATE ALTERNATIVE LOCATION AS SPECIFIED IN THE NOTICE OF INTENT, FROM THE DATE OF PROJECT INITIATION TO THE DATE OF FINAL STABILIZATION.

XVI. NOTICE OF TERMINATION

NOTICE OF TERMINATION:

- 1. WHERE A SITE HAS BEEN FINALLY STABILIZED AND ALL STORMWATER DISCHARGES AUTHORIZED BY THIS PERMIT ARE ELIMINATED, THE PERMITTEE SHALL SUBMIT A NOTICE OF TERMINATION (DEP FORM 62-621.300(6)). SIGNED IN ACCORDANCE WITH PART VII.C OF DEP DOCUMENT NO. 62-621.300(4)(a), WITHIN 14 DAYS OF FINAL STABILIZATION OF THE SITE TO TERMINATE COVERAGE UNDER THIS PERMIT.
2. ELIMINATION OF STORMWATER DISCHARGES ASSOCIATED WITH CONSTRUCTION ACTIVITY MEANS THAT ALL DISTURBED SOILS AT THE SITE HAVE BEEN FINALLY STABILIZED AND TEMPORARY EROSION AND SEDIMENT CONTROL MEASURES HAVE BEEN REMOVED OR WILL BE REMOVED AT AN APPROPRIATE TIME, OR THAT ALL STORMWATER DISCHARGES ASSOCIATED WITH CONSTRUCTION ACTIVITY FROM THE SITE THAT ARE AUTHORIZED BY THIS GENERIC PERMIT HAVE OTHERWISE BEEN ELIMINATED.
3. FOR CONSTRUCTION ACTIVITIES WHERE THE OPERATOR CHANGES, THE EXISTING OPERATOR SHALL FILE AN N.O.T. IN ACCORDANCE WITH THIS PART WITHIN 14 DAYS OF RELINQUISHING CONTROL OF THE PROJECT TO A NEW OPERATOR.

THE PERMITTEE SHALL SUBMIT A NOTICE OF TERMINATION TO THE FOLLOWING ADDRESS:

NPDES STORMWATER NOTICES CENTER, MS# 2510
FLORIDA DEPARTMENT OF ENVIRONMENTAL PROTECTION
2600 BLAIR STONE ROAD
TALLAHASSEE, FLORIDA 32399-2400

PROJECTS THAT DISCHARGED STORMWATER ASSOCIATED WITH CONSTRUCTION ACTIVITY TO A MUNICIPAL SEPARATE STORM SEWER SYSTEM (MS4) SHALL SUBMIT A COPY OF THE N.O.T. TO THE OPERATOR OF THE MS4.

Contractor/Subcontractor Certification Statement
Stormwater Pollution Prevention Plan
Site Name: FLETCHER CENTER EAST
Site Location: WEST OF SW 138TH TERRACE AND SOUTH OF W. NEWBERRY ROAD JONESVILLE, FL


Table with 5 columns: DATE, RESPONSIBLE INDIVIDUAL'S NAME, RESPONSIBLE INDIVIDUAL'S SIGNATURE, TITLE, COMPANY NAME, ADDRESS, AND PHONE NUMBER

DANIEL H. YOUNG
Daniel H. Young, P.E.
State of Florida, Professional Engineer, License No. 70780
This item has been digitally signed and sealed by Daniel H. Young, P.E., on the date indicated here: 10/02/23

Vertical sidebar containing CHWA Professional Consultants logo, scale information (N/A), submission dates (6/5/23 - 10/2/23), and sheet number (21-0571).


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Title: gpage Plot Date: Oct 23, 2023 4:33pm



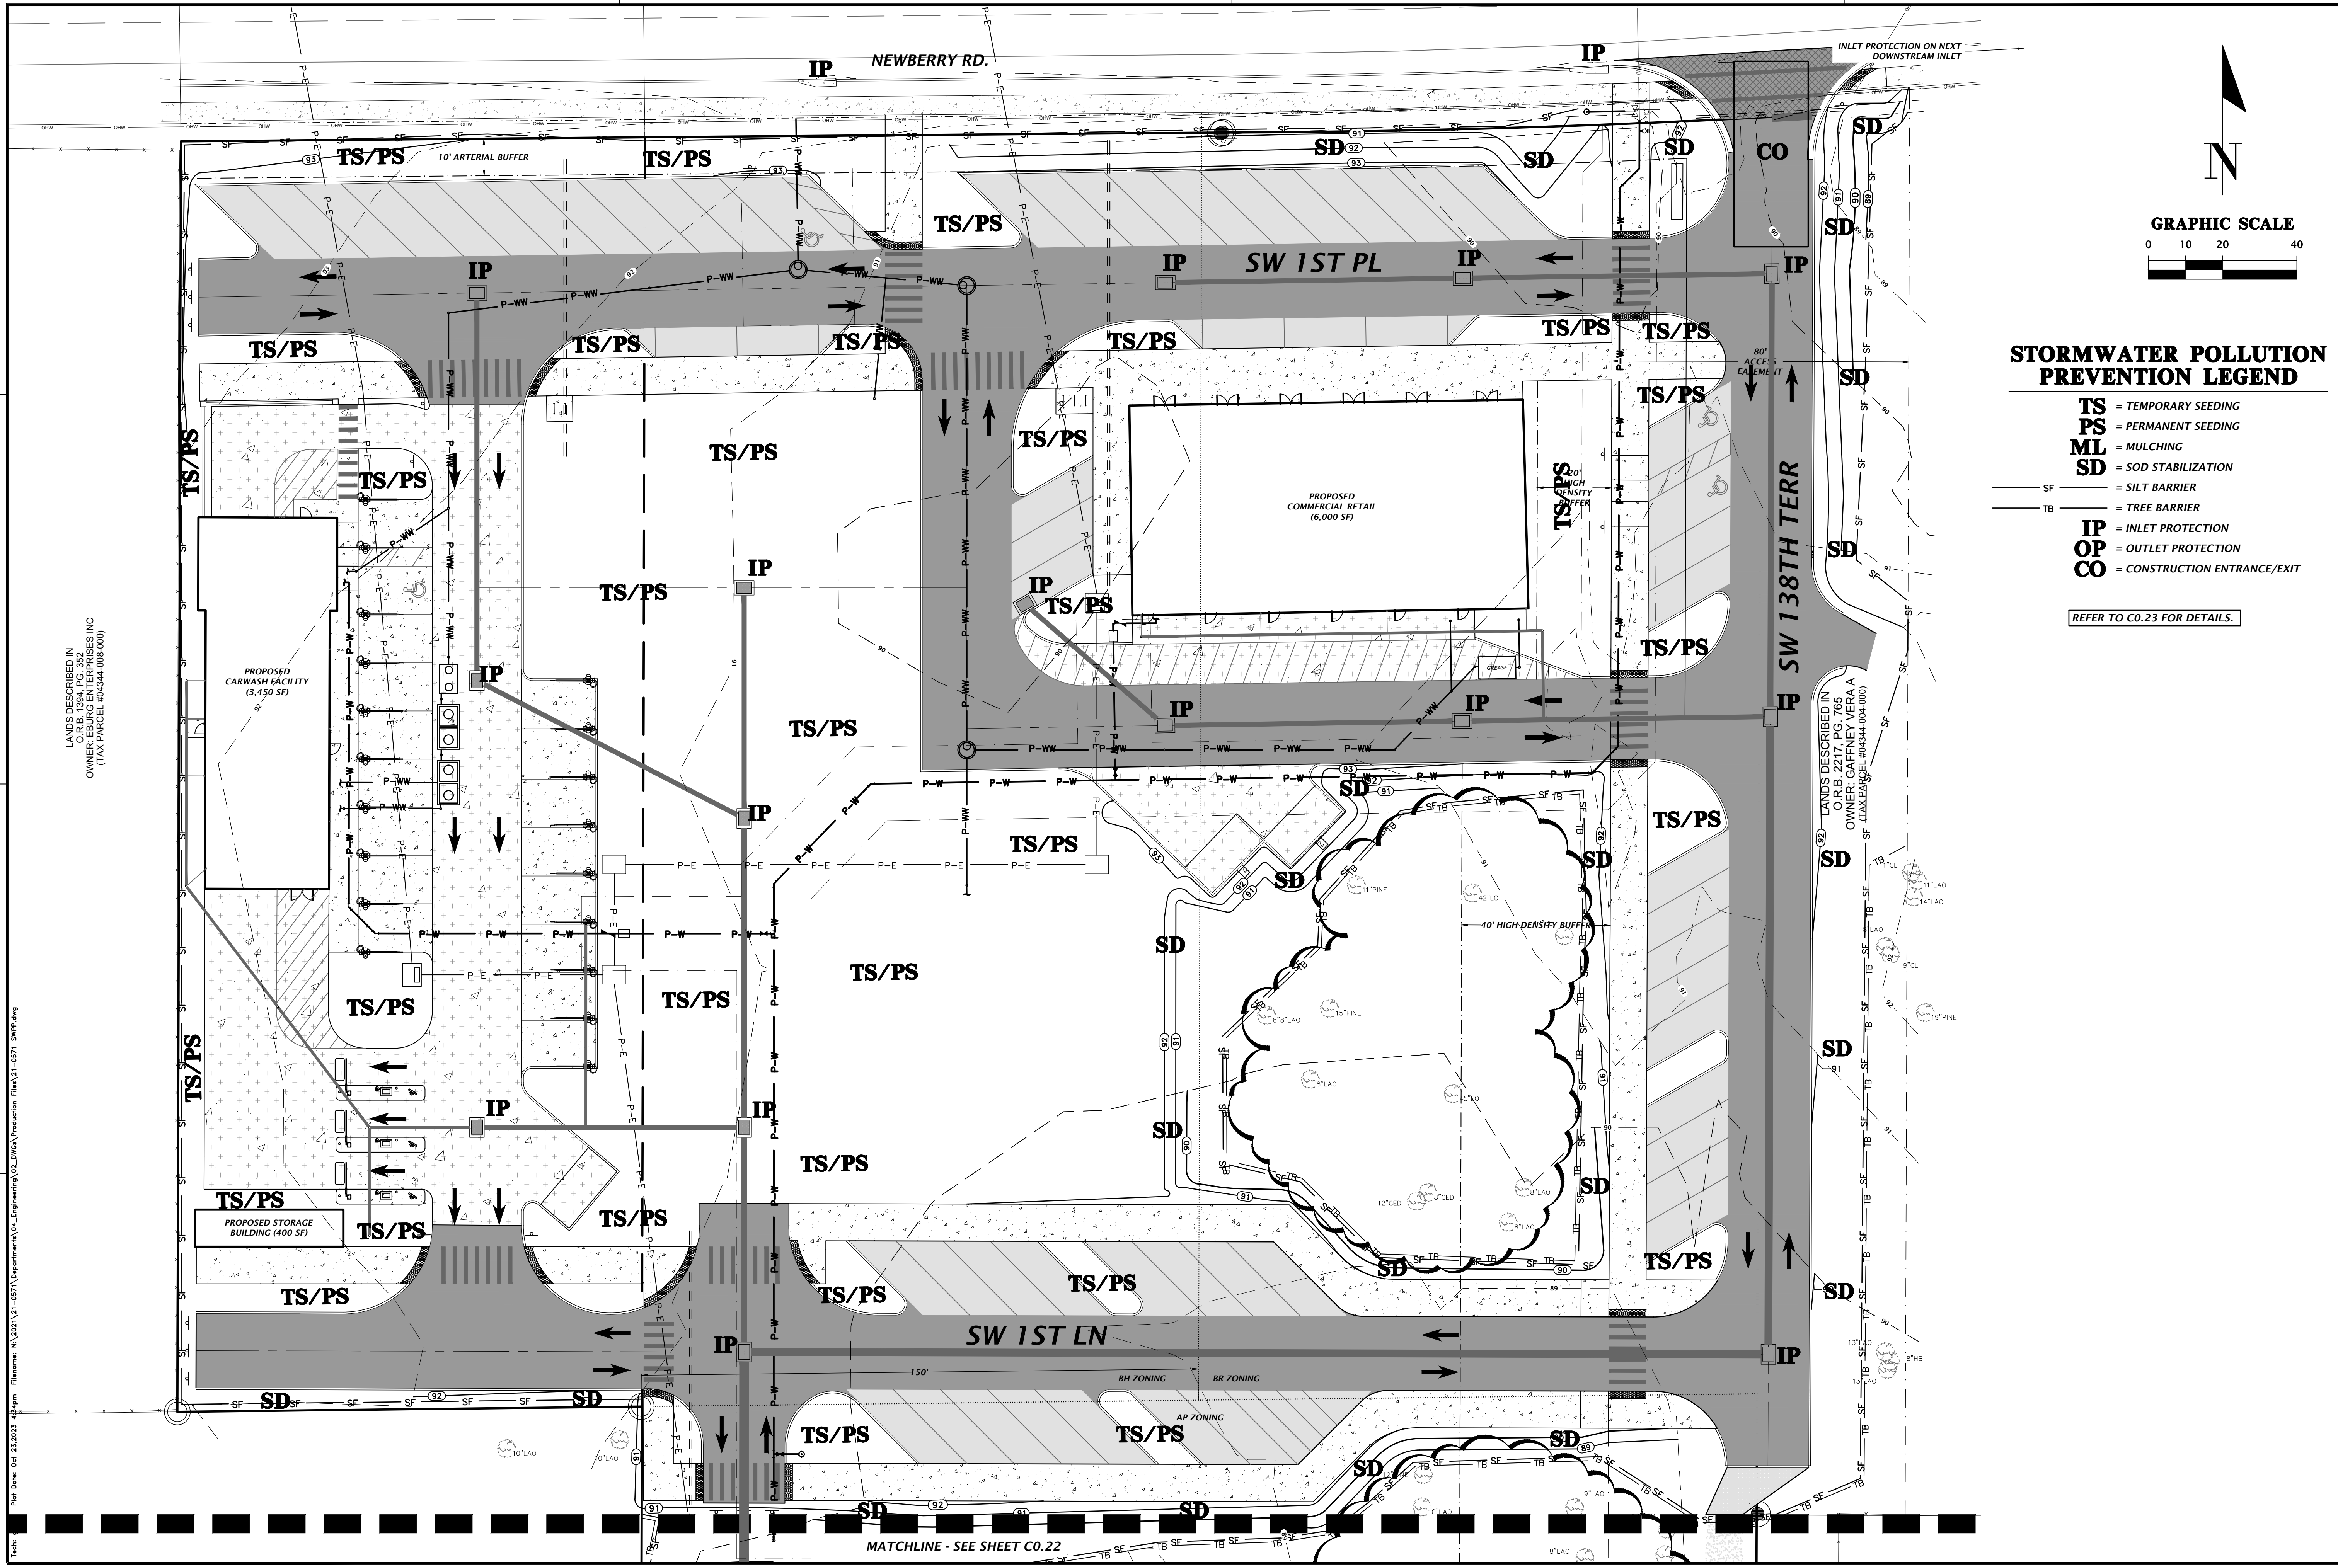

LANDS DESCRIBED IN  
 COLUMBIA ENTERPRISES INC  
 OWNER: EBRIGS ENTERPRISES INC  
 (TAX PARCEL #04344-008-000)

LANDS DESCRIBED IN  
 COLUMBIA ENTERPRISES INC  
 OWNER: GATLEY, VERA A  
 (TAX PARCEL #04344-004-000)

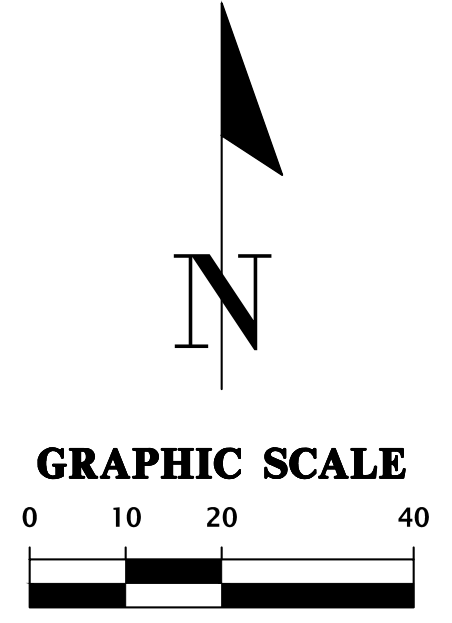

**STORMWATER POLLUTION PREVENTION LEGEND**

- TS** = TEMPORARY SEEDING
- PS** = PERMANENT SEEDING
- ML** = MULCHING
- SD** = SOD STABILIZATION
- SF** = SILT BARRIER
- TB** = TREE BARRIER
- IP** = INLET PROTECTION
- OP** = OUTLET PROTECTION
- CO** = CONSTRUCTION ENTRANCE/EXIT

REFER TO C0.23 FOR DETAILS.

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 Plot Date: Oct 23, 2023 4:38pm

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 Alachua, Florida 32615  
 (352) 351-1976  
 www.chwa-inc.com  
 est. 1988 FLORIDA  
 CA-5075

SCALE

1"=50'  
 VERIFY SCALE  
 BAR IS ONE INCH ON  
 0" ORIGINAL DRAWING  
 IF NOT ONE INCH ON  
 SCALES ACCORDINGLY

SUBMITTALS

6/5/23 - SUBMITTAL TO ALACHUA COUNTY, CRU, FOOT, AND SRWMD  
 7/31/23 - SUBMITTAL TO ALACHUA COUNTY, CRU, FOOT, AND SRWMD  
 10/10/23 - SUBMITTAL TO CRU & FOOT  
 10/23/23 - BID SET

CLIENT

FLETCHER DEVELOPMENT  
 FLETCHER CENTER EAST  
 STORMWATER POLLUTION  
 PREVENTION PLAN

TECHNICIAN

G. WADZINSKI  
 C. LEDFORD, E.I.  
 QUALITY CONTROL  
 D. YOUNG, P.E.  
 PROJECT NUMBER  
 21-0571



SHEET TITLE

Daniel H. Young, P.E.  
 State of Florida, Professional  
 Engineer, License No. 70780  
 This item has been digitally  
 signed and sealed by Daniel  
 H. Young, P.E., on the date  
 indicated here: 10/20/2023  
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 signature must be verified on  
 any electronic copies.

SHEET NO.

C0.21

MATCHLINE - SEE SHEET C0.22

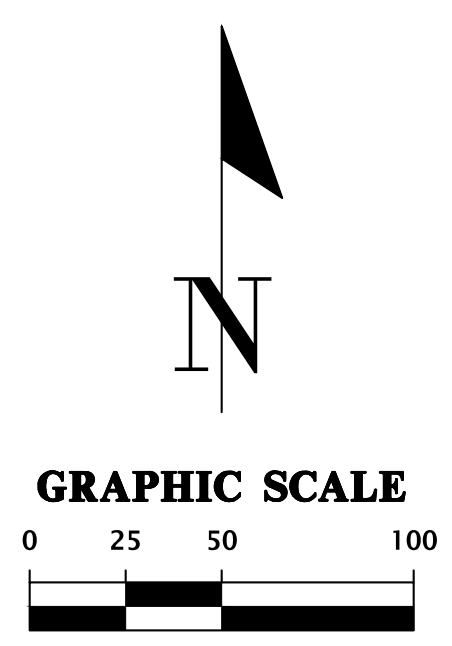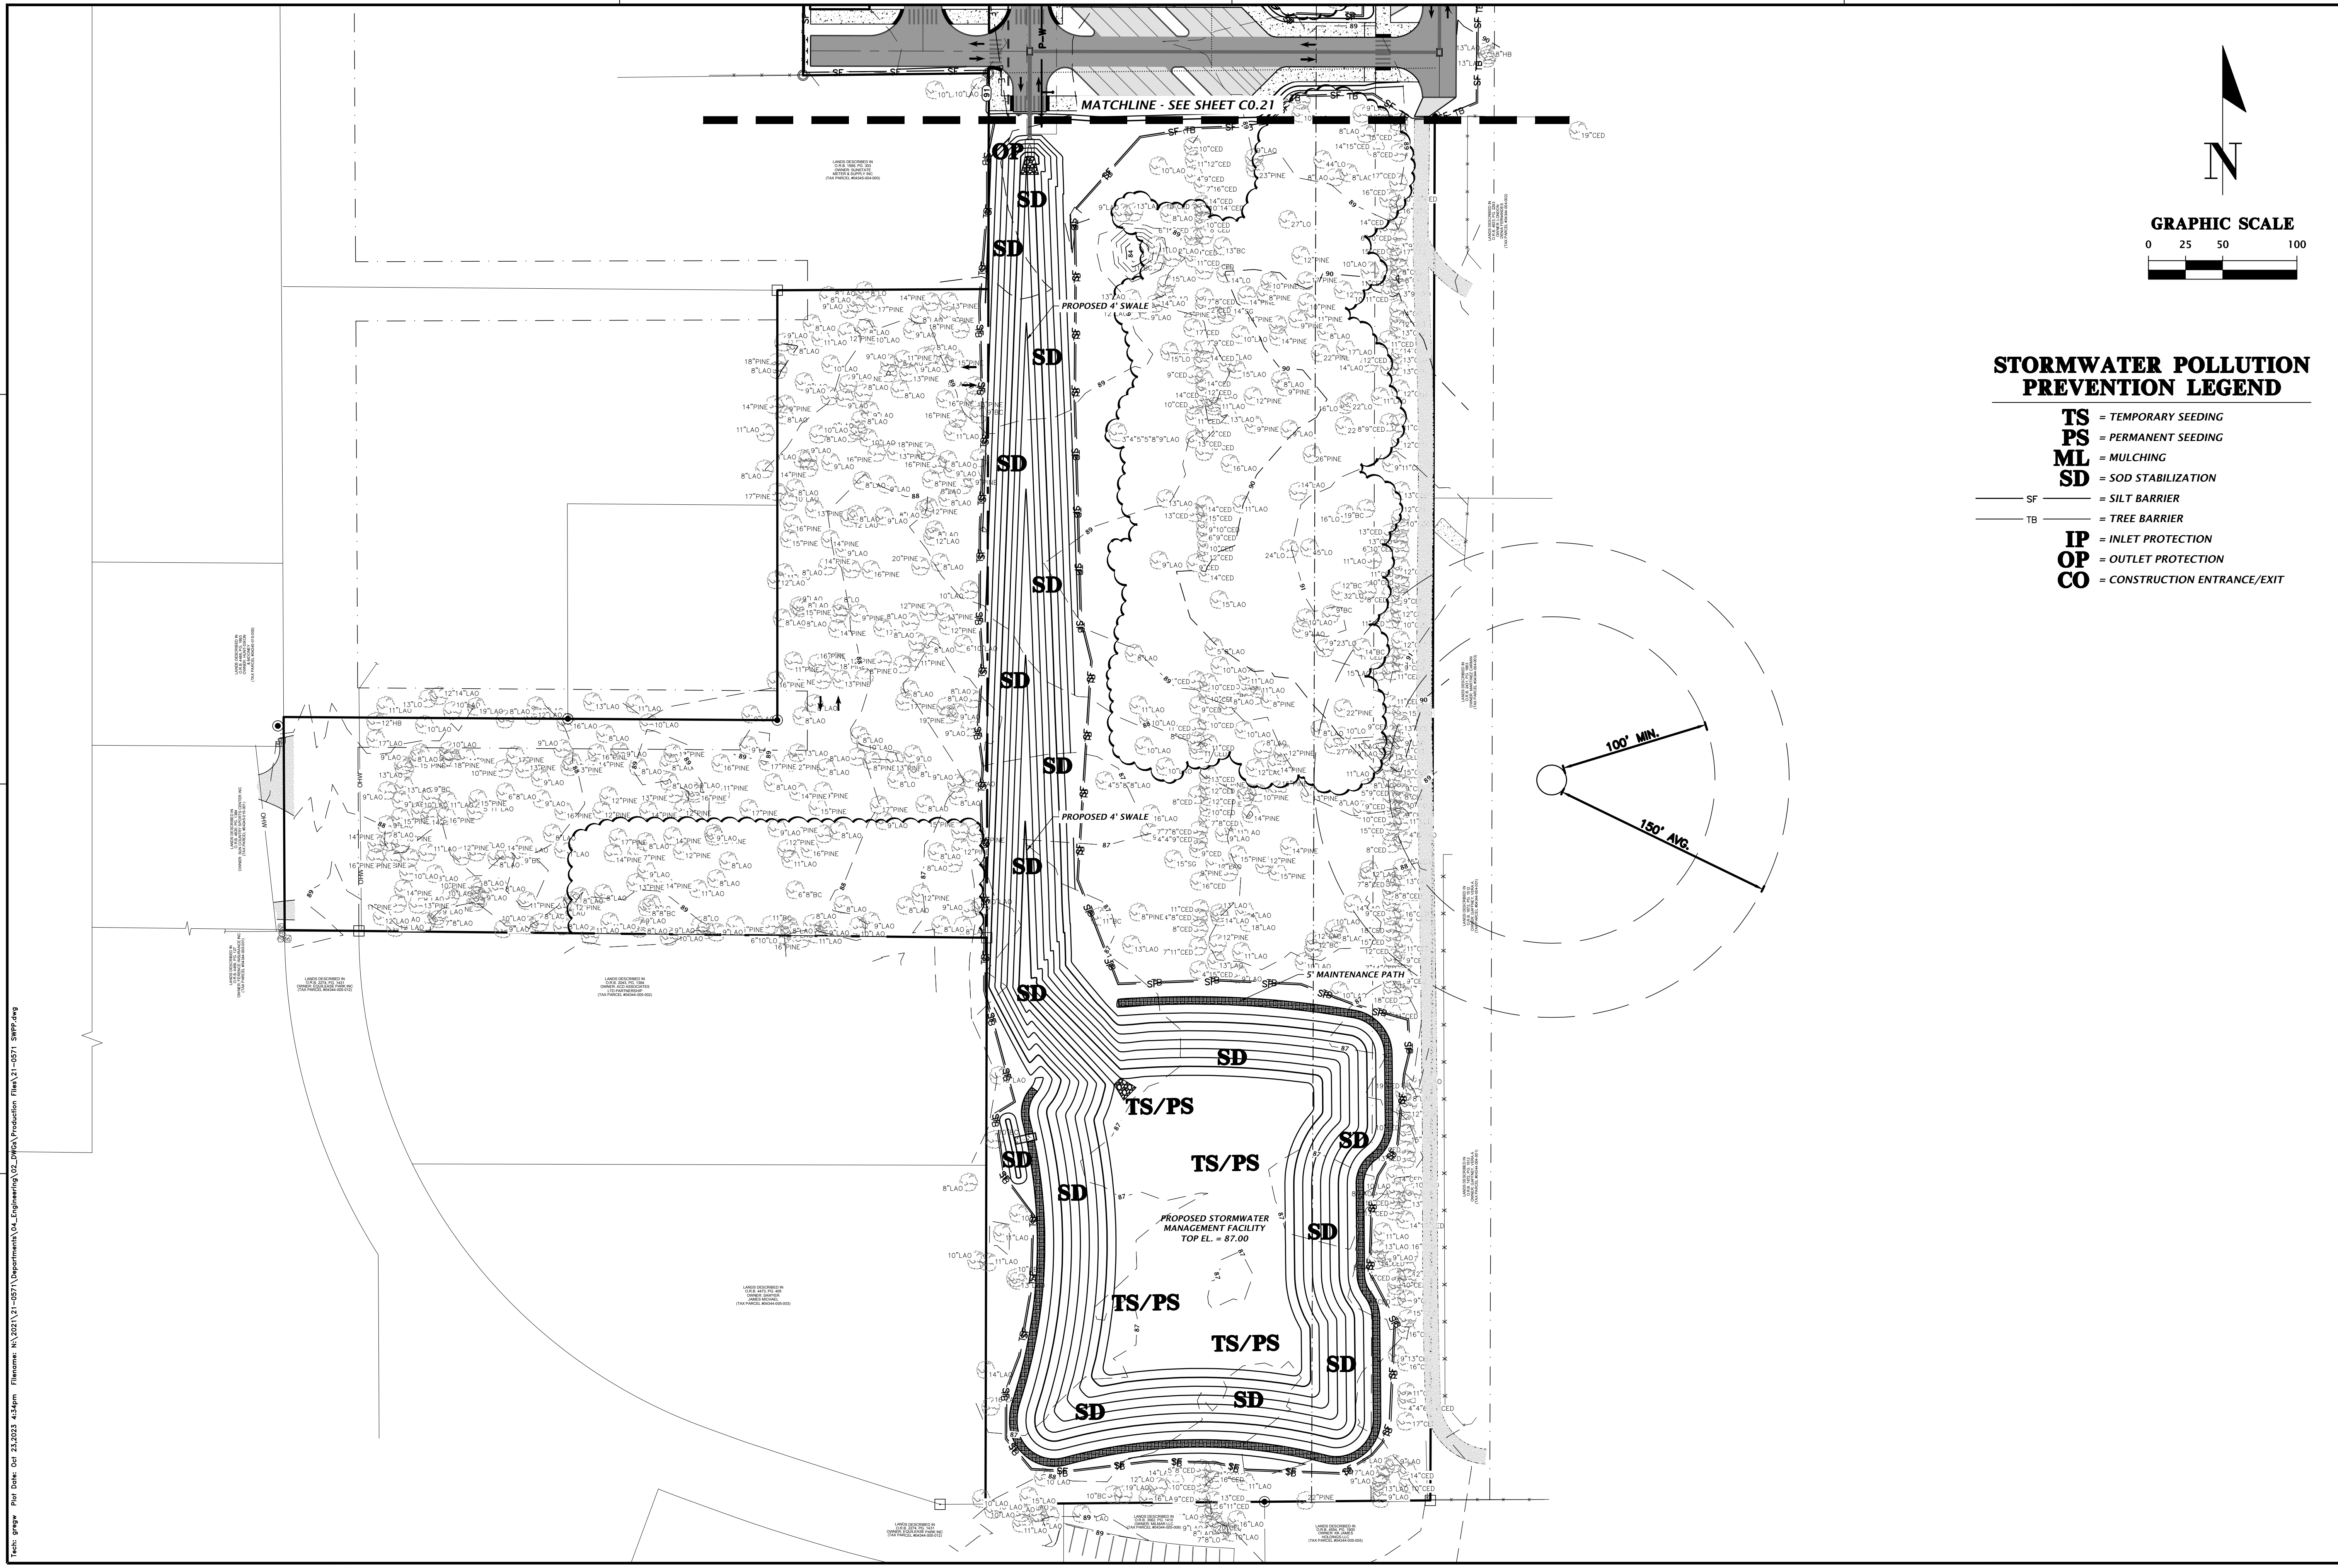

**STORMWATER POLLUTION PREVENTION LEGEND**


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		11801 Research Drive Alachua, Florida 32615 (352) 351-1976 www.chwa-inc.com est. 1988 FLORIDA CA-5075				
<p>SCALE: 1"=50'</p> <p>VERIFY SCALE          BAR IS ONE INCH ON          ORIGINAL DRAWING 1"          IF NOT ONE INCH ON          SCALES ACCORDINGLY.</p>	<p>CONSTRUCTION AND REVISIONS:</p> <table border="1" style="width: 100%; border-collapse: collapse;"> <tr> <td style="width: 20%;">DATE</td> <td style="width: 80%;">REVISION</td> </tr> <tr> <td> </td> <td> </td> </tr> </table>		DATE	REVISION		
DATE	REVISION					
SUBMITTALS: 6/5/23 - SUBMITTAL TO ALACHUA COUNTY, CRU, FOOT, AND SWMWD 7/31/23 - SUBMITTAL TO ALACHUA COUNTY, CRU, FOOT, AND SWMWD 10/10/23 - SUBMITTAL TO CRU & FOOT 10/23/23 - BID SET						
<p>CLIENT:</p> <p>FLETCHER DEVELOPMENT</p>	<p>PROJECT:</p> <p>FLETCHER CENTER EAST</p> <p>SHEET TITLE:</p> <p>STORMWATER POLLUTION PREVENTION PLAN</p>					
<p>TECHNICIAN:</p> <p>G. WADZANSKI</p> <p>DESIGNER:</p> <p>G. LEDFORD, E.I.</p> <p>QUALITY CONTROL:</p> <p>D. YOUNG, P.E.</p> <p>PROJECT NUMBER:</p> <p>21-0571</p>	<p>CLIENT:</p> <p>DANIEL H. YOUNG</p> <p>Daniel H. Young, P.E.          State of Florida, Professional Engineer, License No. 70780</p> <p>This item has been digitally signed and sealed by Daniel H. Young, P.E., on the date indicated here: 10/26/2023</p> <p>Printed copies of this document are not considered signed and sealed and the signature must be verified on any electronic copies.</p>					
<p>FL PE No. 70780</p> <p>SHEET NO. <b>C0.22</b></p>						

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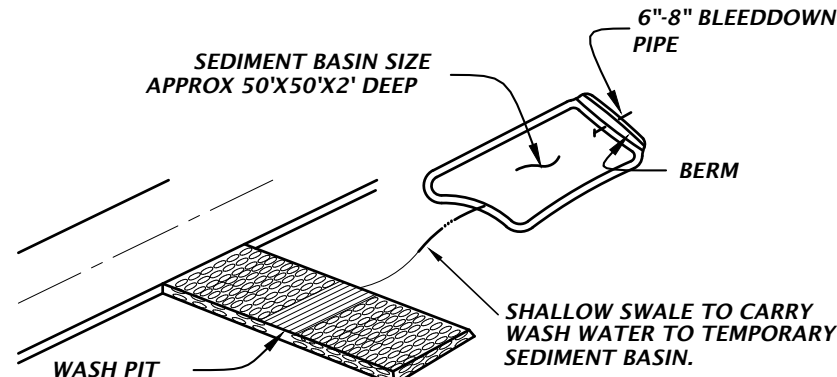
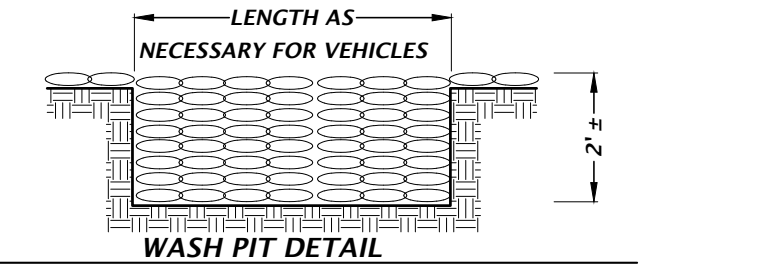


NOTE:  
 1. CONSTRUCTION EXIT INSTALLATION SHALL REMOVE MUD/SOILS FROM TIRES TO PREVENT TRACKING ONTO PUBLIC ROADS.  
 2. TOP DRESSING WITH 2" STONE MAY BE REQ'D AS DETERMINED BY THE USE AND FUNCTION OF THE SYSTEM.  
 3. THE WASH PIT SHOULD BE INSTALLED IF THE STANDARD CONSTRUCTION EXIT DOES NOT SUFFICIENTLY REMOVE SOILS AND WASHING IS REQ'D.




STONE SIZE:  
 ASTM D448 SIZE #1 (1-1/2" TO 3-1/2" DIA)  
 STANDARD CONSTRUCTION EXIT

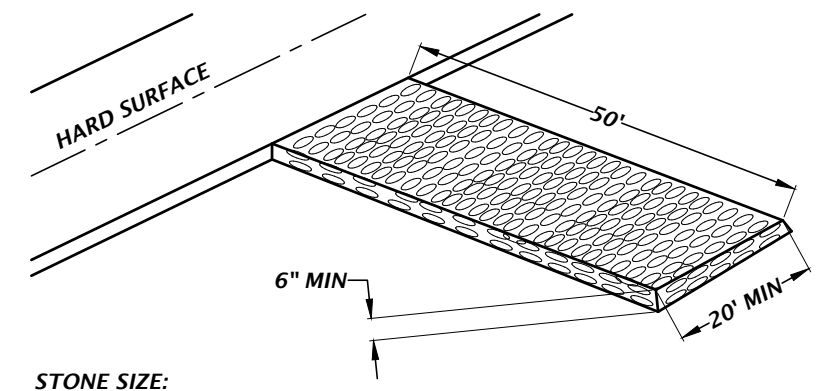**TEMPORARY CONSTRUCTION EXIT DETAIL**



CONSTRUCTION EXIT WITH WASH PIT

NTS

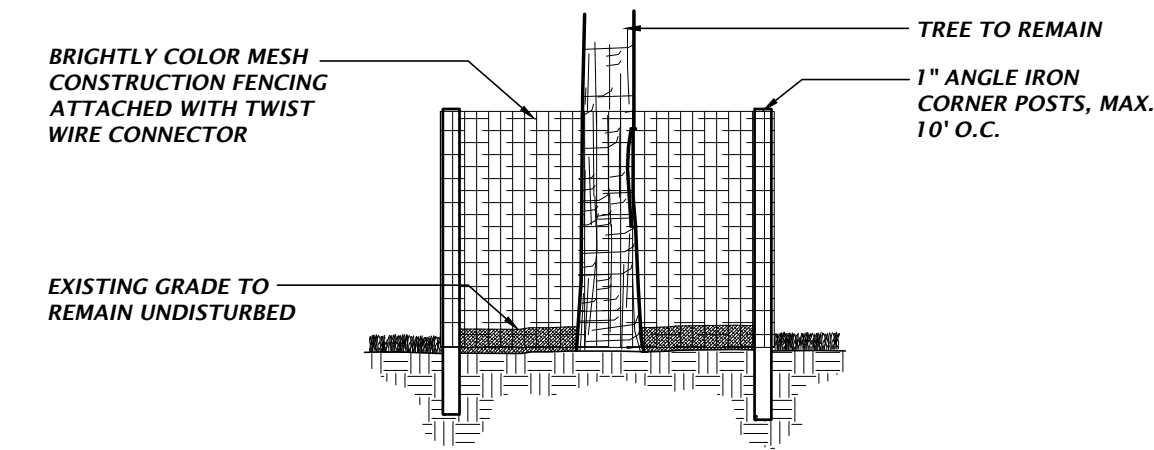

**TREE PROTECTION DETAIL**


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**TREE PROTECTION NOTES**


- PROTECTIVE BARRIERS SHALL BE CONSTRUCTED, AS NECESSARY, TO PREVENT THE DESTRUCTION OR DAMAGING OF REGULATED TREES THAT ARE LOCATED WITHIN 50 FEET OF ANY CONSTRUCTION ACTIVITY OR STORAGE OF EQUIPMENT AND MATERIALS.
- PROTECTIVE BARRIERS SHALL BE PLAINLY VISIBLE AND SHALL CREATE A CONTINUOUS BOUNDARY AROUND TREES OR VEGETATION CLUSTERS IN ORDER TO PREVENT ENCROACHMENT BY MACHINERY, VEHICLES OR STORED MATERIALS.
- NO GRADE CHANGES SHALL BE MADE WITHIN ANY UNDISTURBED AREA WITHOUT PRIOR APPROVAL BY THE COUNTY INSPECTOR. IF A GRADE CHANGE IS MADE AND ROOTS LARGER THAN ONE (1) INCH IN DIAMETER ARE DAMAGED OR EXPOSED, THEY SHALL BE CUT CLEANLY AND RECOVERED WITH SOIL.
- THE PROTECTIVE BARRIERS SHALL REMAIN IN PLACE AND INTACT UNTIL CONSTRUCTION IS COMPLETED.
- LANDSCAPE PREPARATION IN THE UNDISTURBED AREA SHALL BE PROHIBITED UNLESS SPECIFICALLY APPROVED OTHERWISE BY THE COUNTY. LANDSCAPING SHALL BE LIMITED TO PLACEMENT OF SOIL, MULCH, OR OTHER GROUND COVERS.
- ALL CONSTRUCTION ACTIVITIES SHALL BE PROHIBITED WITHIN THE UNDISTURBED AREA INCLUDING ALL DIGGING, TRENCHING, CONSTRUCTION LAY-DOWN AREA, PLACEMENT OF HAZARDOUS MATERIALS, INCLUDING FUELS AND SOLVENTS. PLACEMENT OF FILL OR SOILS, AND PARKING OF CONSTRUCTION VEHICLES OR EMPLOYEES VEHICLES.
- THE AMERICAN NATIONAL STANDARDS INSTITUTE A-300 PART V: MANAGEMENT OF TREES AND SHRUBS DURING SITE PLANNING, SITE DEVELOPMENT, AND SITE CONSTRUCTION OR OTHER NATIONALLY RECOGNIZED ARBORICULTURAL STANDARDS SHALL BE USED AS GUIDELINES FOR TREE PROTECTION, PLANTING, PRUNING AND CARE DURING DEVELOPMENT AND CONSTRUCTION.

**TYPICAL INSTALLATION SEQUENCE FOR SILT-SAVER FRAME AND FILTER**

- EXCAVATE APPROXIMATELY 4" TO 6" BELOW THE TOP OF THE INLET STRUCTURE.
- PLACE THE FRAME ONTO THE INLET STRUCTURE, ENSURING PROPER SEATING OF FRAME TO STRUCTURE.
- SLIDE THE FILTER OVER THE FRAME.
- FILL THE FILTER POCKETS WITH SOIL, #57 GRAVEL OR EQUIVALENT. THE FILTER POCKETS SHOULD BE COMPLETELY FILLED TO ENSURE A GOOD SEAL BETWEEN THE GROUND AND INLET STRUCTURE.
- BACK FILL AROUND THE FRAME AND FILTER ASSEMBLY IS NOT REQUIRED TO COMPLETE INSTALLATION; HOWEVER, BACK FILLING MAY BE NECESSARY TO COMPLETE EXCAVATION REQUIREMENTS FOR THE SITE.

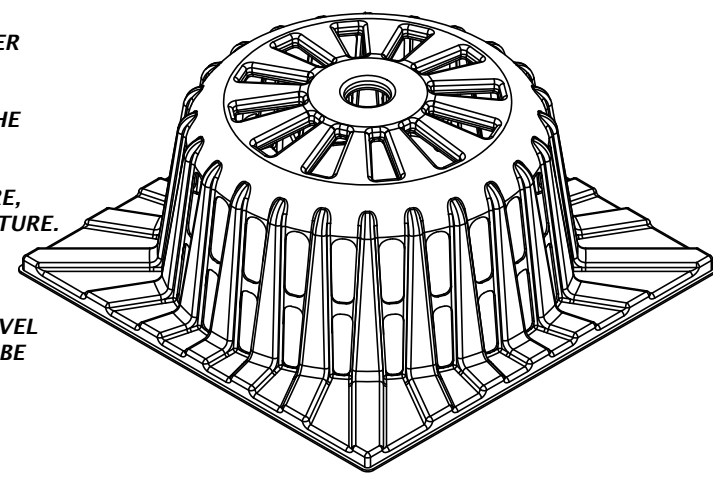

BASE OF FRAME SHAPED & SIZED TO FIT INLET TOP

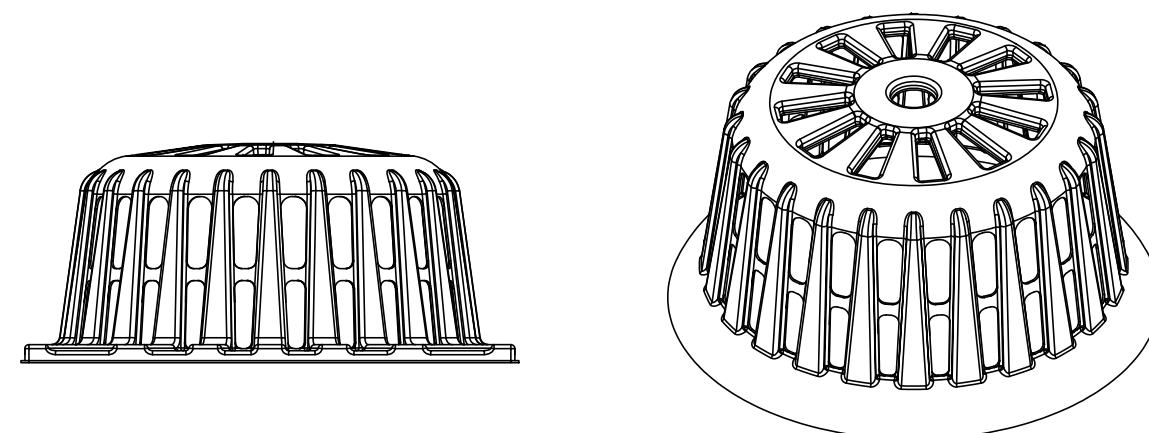

**SILT-SAVER® DETAIL**


NTS

**INSTALLATION:**

REMOVE THE GRATE FROM INLET. IF USING OPTIONAL OIL ABSORBENTS, PLACE ABSORBENT PILLOW IN UNIT. STAND THE GRATE ON END. MOVE THE TOP LIFTING STRAPS OUT OF THE WAY AND PLACE THE GRATE INTO THE DANDY SACK™ SO THAT THE GRATE IS BELOW THE TOP STRAPS AND ABOVE THE LOWER STRAPS. HOLDING THE LIFTING DEVICES, INSERT THE GRATE INTO THE INLET.

**MAINTENANCE:**

REMOVE ALL ACCUMULATED SEDIMENT AND DEBRIS FROM VICINITY OF UNIT AFTER EACH STORM EVENT. AFTER EACH STORM EVENT AND AT REGULAR INTERVALS, LOOK INTO THE DANDY SACK™. IF THE CONTAINMENT AREA IS MORE THAN 1/3 FULL OF SEDIMENT, THE UNIT MUST BE EMPTIED. TO EMPTY UNIT, LIFT THE UNIT OUT OF THE INLET USING THE LIFTING STRAPS AND REMOVE THE GRATE. IF USING OPTIONAL OIL ABSORBENTS, REPLACE ABSORBENT WHEN NEAR SATURATION.

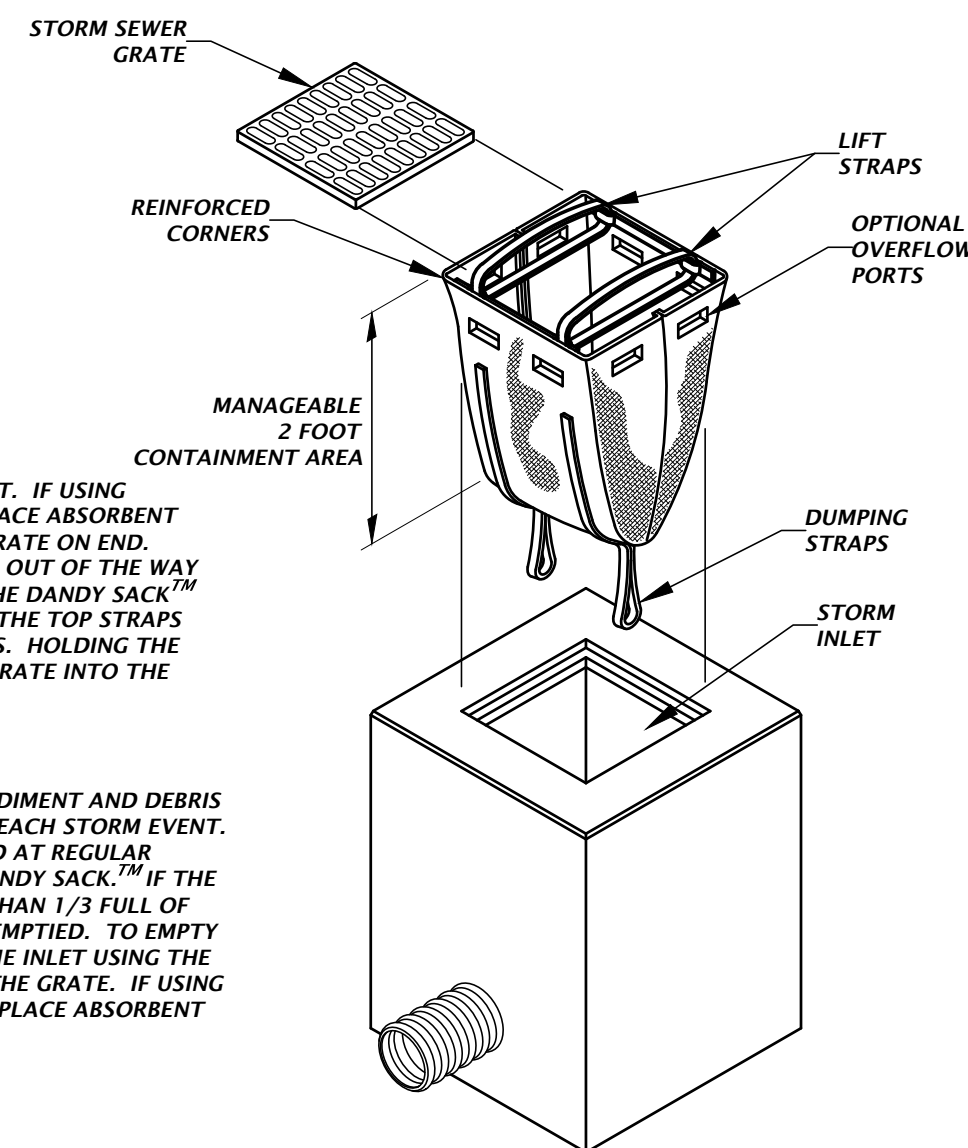


**DANDY SACK™ DETAIL**

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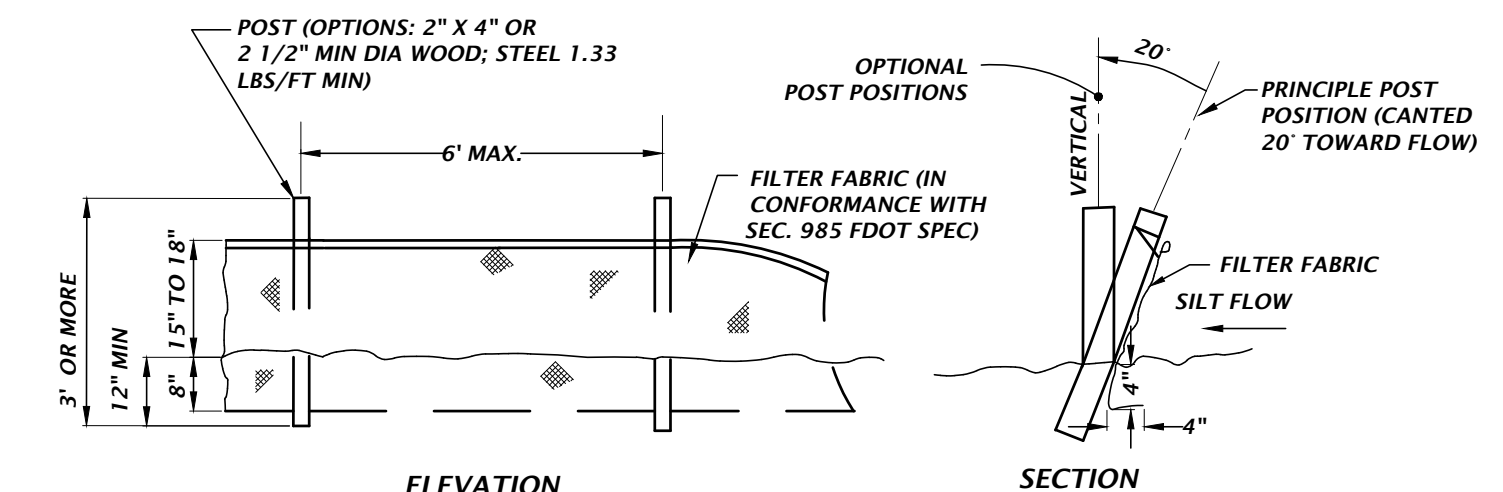
**INLET PROTECTION OPTIONS DETAIL**

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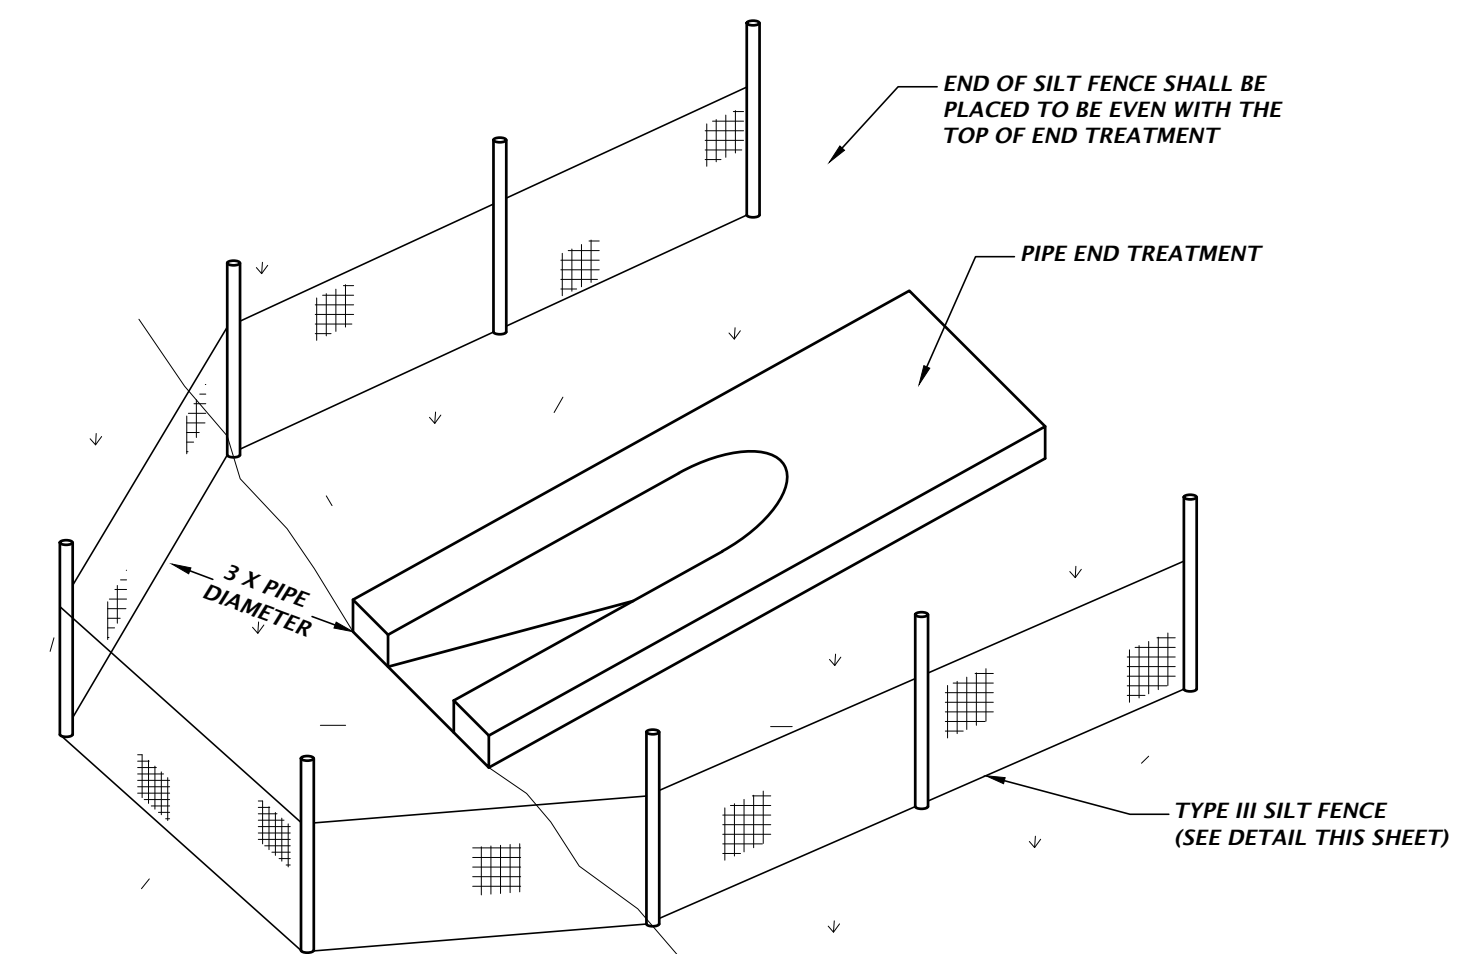
**TYPE III SILT FENCE WRAPPING DETAIL**

NTS

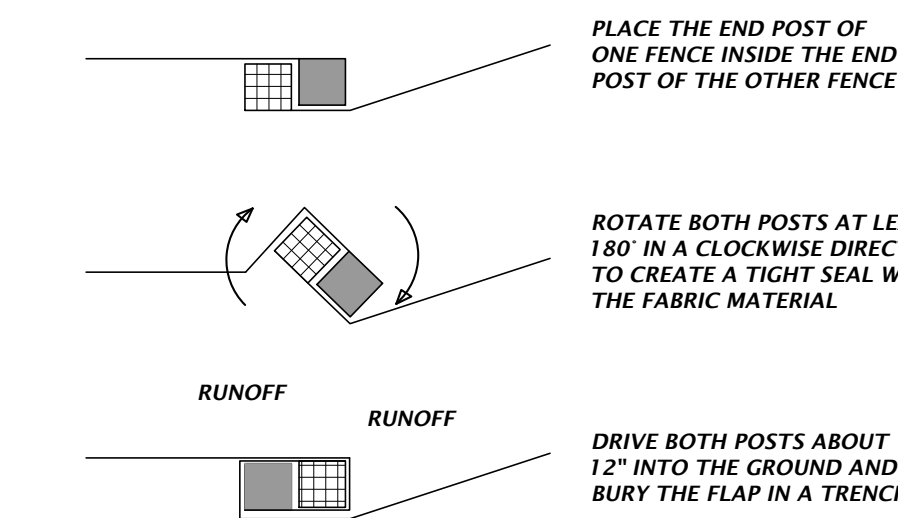

**TYPE III SILT FENCE DETAIL**

NTS



**OUTFALL PROTECTION DETAIL**

NTS

Title: gwgw For Date: Oct 23, 2023 4:34pm Filename: N:\2023\11-0271\Department\04\_Engineering\02\_DWG\Production\Flm\A\21-0571\_D1.dwg

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 Alachua, Florida 32615  
 (352) 351-1976  
 www.chw-inc.com  
 est. 1988 FLORIDA  
 CA-5075

**CHW**  
 Professional Consultants

SCALE: N/A  
 VERIFY SCALE  
 BAR IS ONE INCH ON  
 0 EQUALS ONE HUNDRED FEET  
 IF NOT ONE INCH ON  
 SCALES ACCORDINGLY.

CONSTRUCTION REVISIONS:

SUBMITTALS:  
 6/5/23 - SUBMITTAL TO ALACHUA COUNTY, CRU, FOOT, AND SWMWD  
 7/31/23 - SUBMITTAL TO ALACHUA COUNTY, CRU, FOOT, AND SWMWD  
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 10/23/23 - BID SET

CLIENT: FLETCHER DEVELOPMENT  
 PROJECT: FLETCHER CENTER EAST  
 SHEET TITLE: STORMWATER POLLUTION PREVENTION DETAILS



TECHNICIAN: G. WADZINSKI  
 DESIGNER: G. LEDFORD, E.I.  
 QUALITY CONTROL: D. YOUNG, P.E.  
 PROJECT NUMBER: 21-0571

DANIEL H. YOUNG  
 Daniel H. Young, P.E.  
 State of Florida, Professional Engineer, License No. 70780

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FL PE No. 70780

SHEET NO. **C0.23**

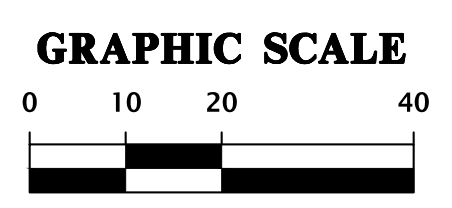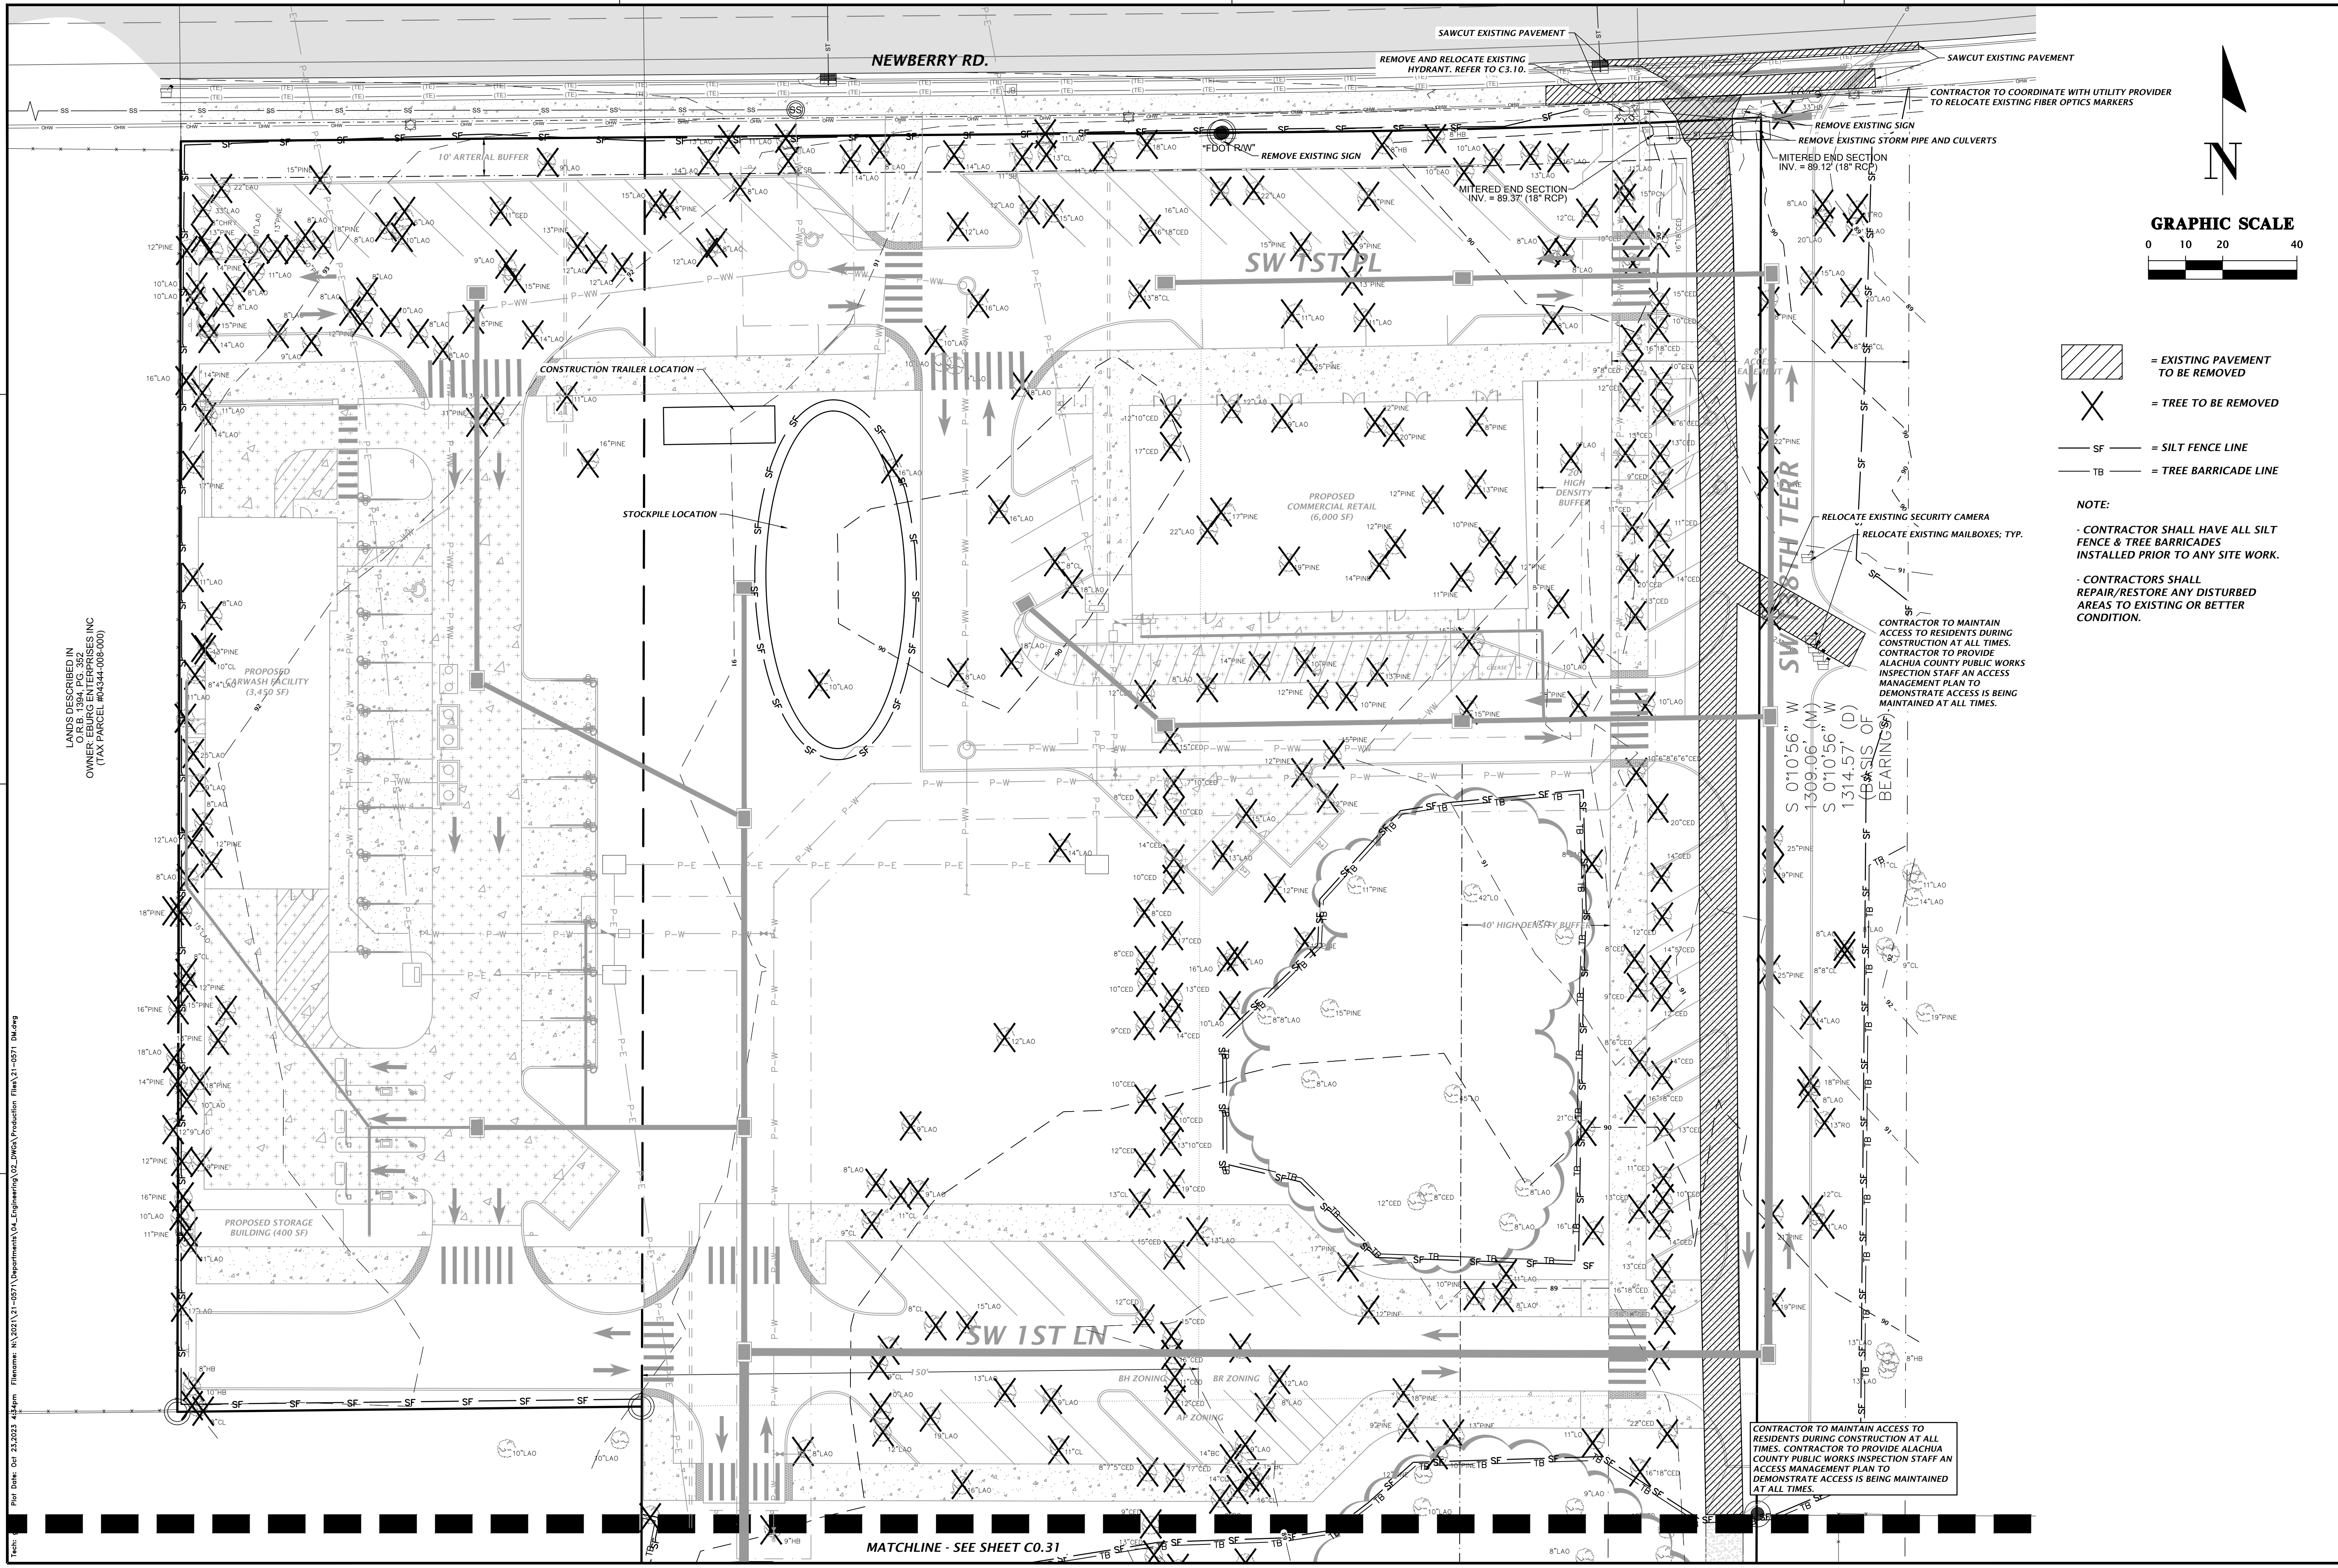

- = EXISTING PAVEMENT TO BE REMOVED
- = TREE TO BE REMOVED
- = SILT FENCE LINE
- = TREE BARRICADE LINE

**NOTE:**

- CONTRACTOR SHALL HAVE ALL SILT FENCE & TREE BARRICADES INSTALLED PRIOR TO ANY SITE WORK.
- CONTRACTORS SHALL REPAIR/RESTORE ANY DISTURBED AREAS TO EXISTING OR BETTER CONDITION.

LANDS DESCRIBED IN  
 C. EDWARD, E.I.  
 OWNER: EDWARDS ENTERPRISES INC  
 (TAX PARCEL #04344-008-000)

File Name: N:\2024\21-0571\Drawings\02\_DWG\Production\Fla\21-0571\_DWG.dwg  
 Plot Date: Oct 23, 2023 4:38pm

CONTRACTOR TO MAINTAIN ACCESS TO RESIDENTS DURING CONSTRUCTION AT ALL TIMES. CONTRACTOR TO PROVIDE ALACHUA COUNTY PUBLIC WORKS INSPECTION STAFF AN ACCESS MANAGEMENT PLAN TO DEMONSTRATE ACCESS IS BEING MAINTAINED AT ALL TIMES.

1801 Research Drive  
 Alachua, Florida 32615  
 (352) 351-1976  
 www.chw-inc.com  
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**CHW**  
 Professional Consultants

SCALE: 1"=20'  
 VERIFY SCALE  
 BAR IS ONE INCH ON  
 0 10 20 30 40  
 IF NOT ONE INCH ON  
 SCALES ACCORDINGLY.

CONSTRUCTION REVISIONS



TECHNICIAN:	G. WADZINSKI	CLIENT:	FLETCHER DEVELOPMENT
DESIGNER:	C. EDWARD, E.I.	PROJECT:	FLETCHER CENTER EAST
QUALITY CONTROL:	D. YOUNG, P.E.	SHEET TITLE:	DEMOLITION AND TREE PROTECTION PLAN
PROJECT NUMBER:	21-0571		

6/5/23 - SUBMITTAL TO ALACHUA COUNTY, CRU, FOOT, AND SRWMD  
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Daniel H. Young, P.E.  
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- = SILT FENCE LINE
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**NOTE:**



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Title: gwpw Plot Date: Oct 23, 2023 4:38pm Filename: N:\2023\11-0071\Department\GA\_Engineering\02\_DWG\Production\Fla\31-0571\_DM.dwg

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CLIENT: FLETCHER DEVELOPMENT	PROJECT: FLETCHER CENTER EAST
TECHNICIAN: G. WADZANSKI DESIGNER: G. LEDFORD, E.I. QUALITY CONTROL: D. YOUNG, P.E.	SHEET TITLE: DEMOLITION AND TREE PROTECTION PLAN PROJECT NUMBER: 21-0571
Daniel H. Young, P.E. State of Florida, Professional Engineer, License No. 78780 This item has been digitally signed and sealed by Daniel H. Young, P.E., on the date indicated here: 10/26/2023 Printed copies of this document are not considered signed and sealed and the signature must be verified on any electronic copies.	
FL PE No. 70780 <b>C0.31</b>	

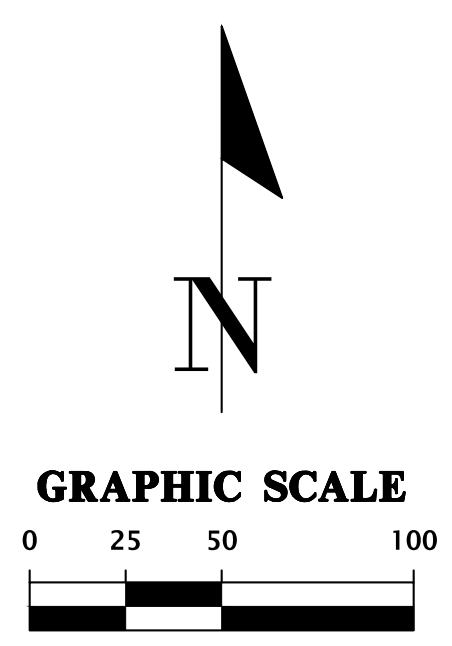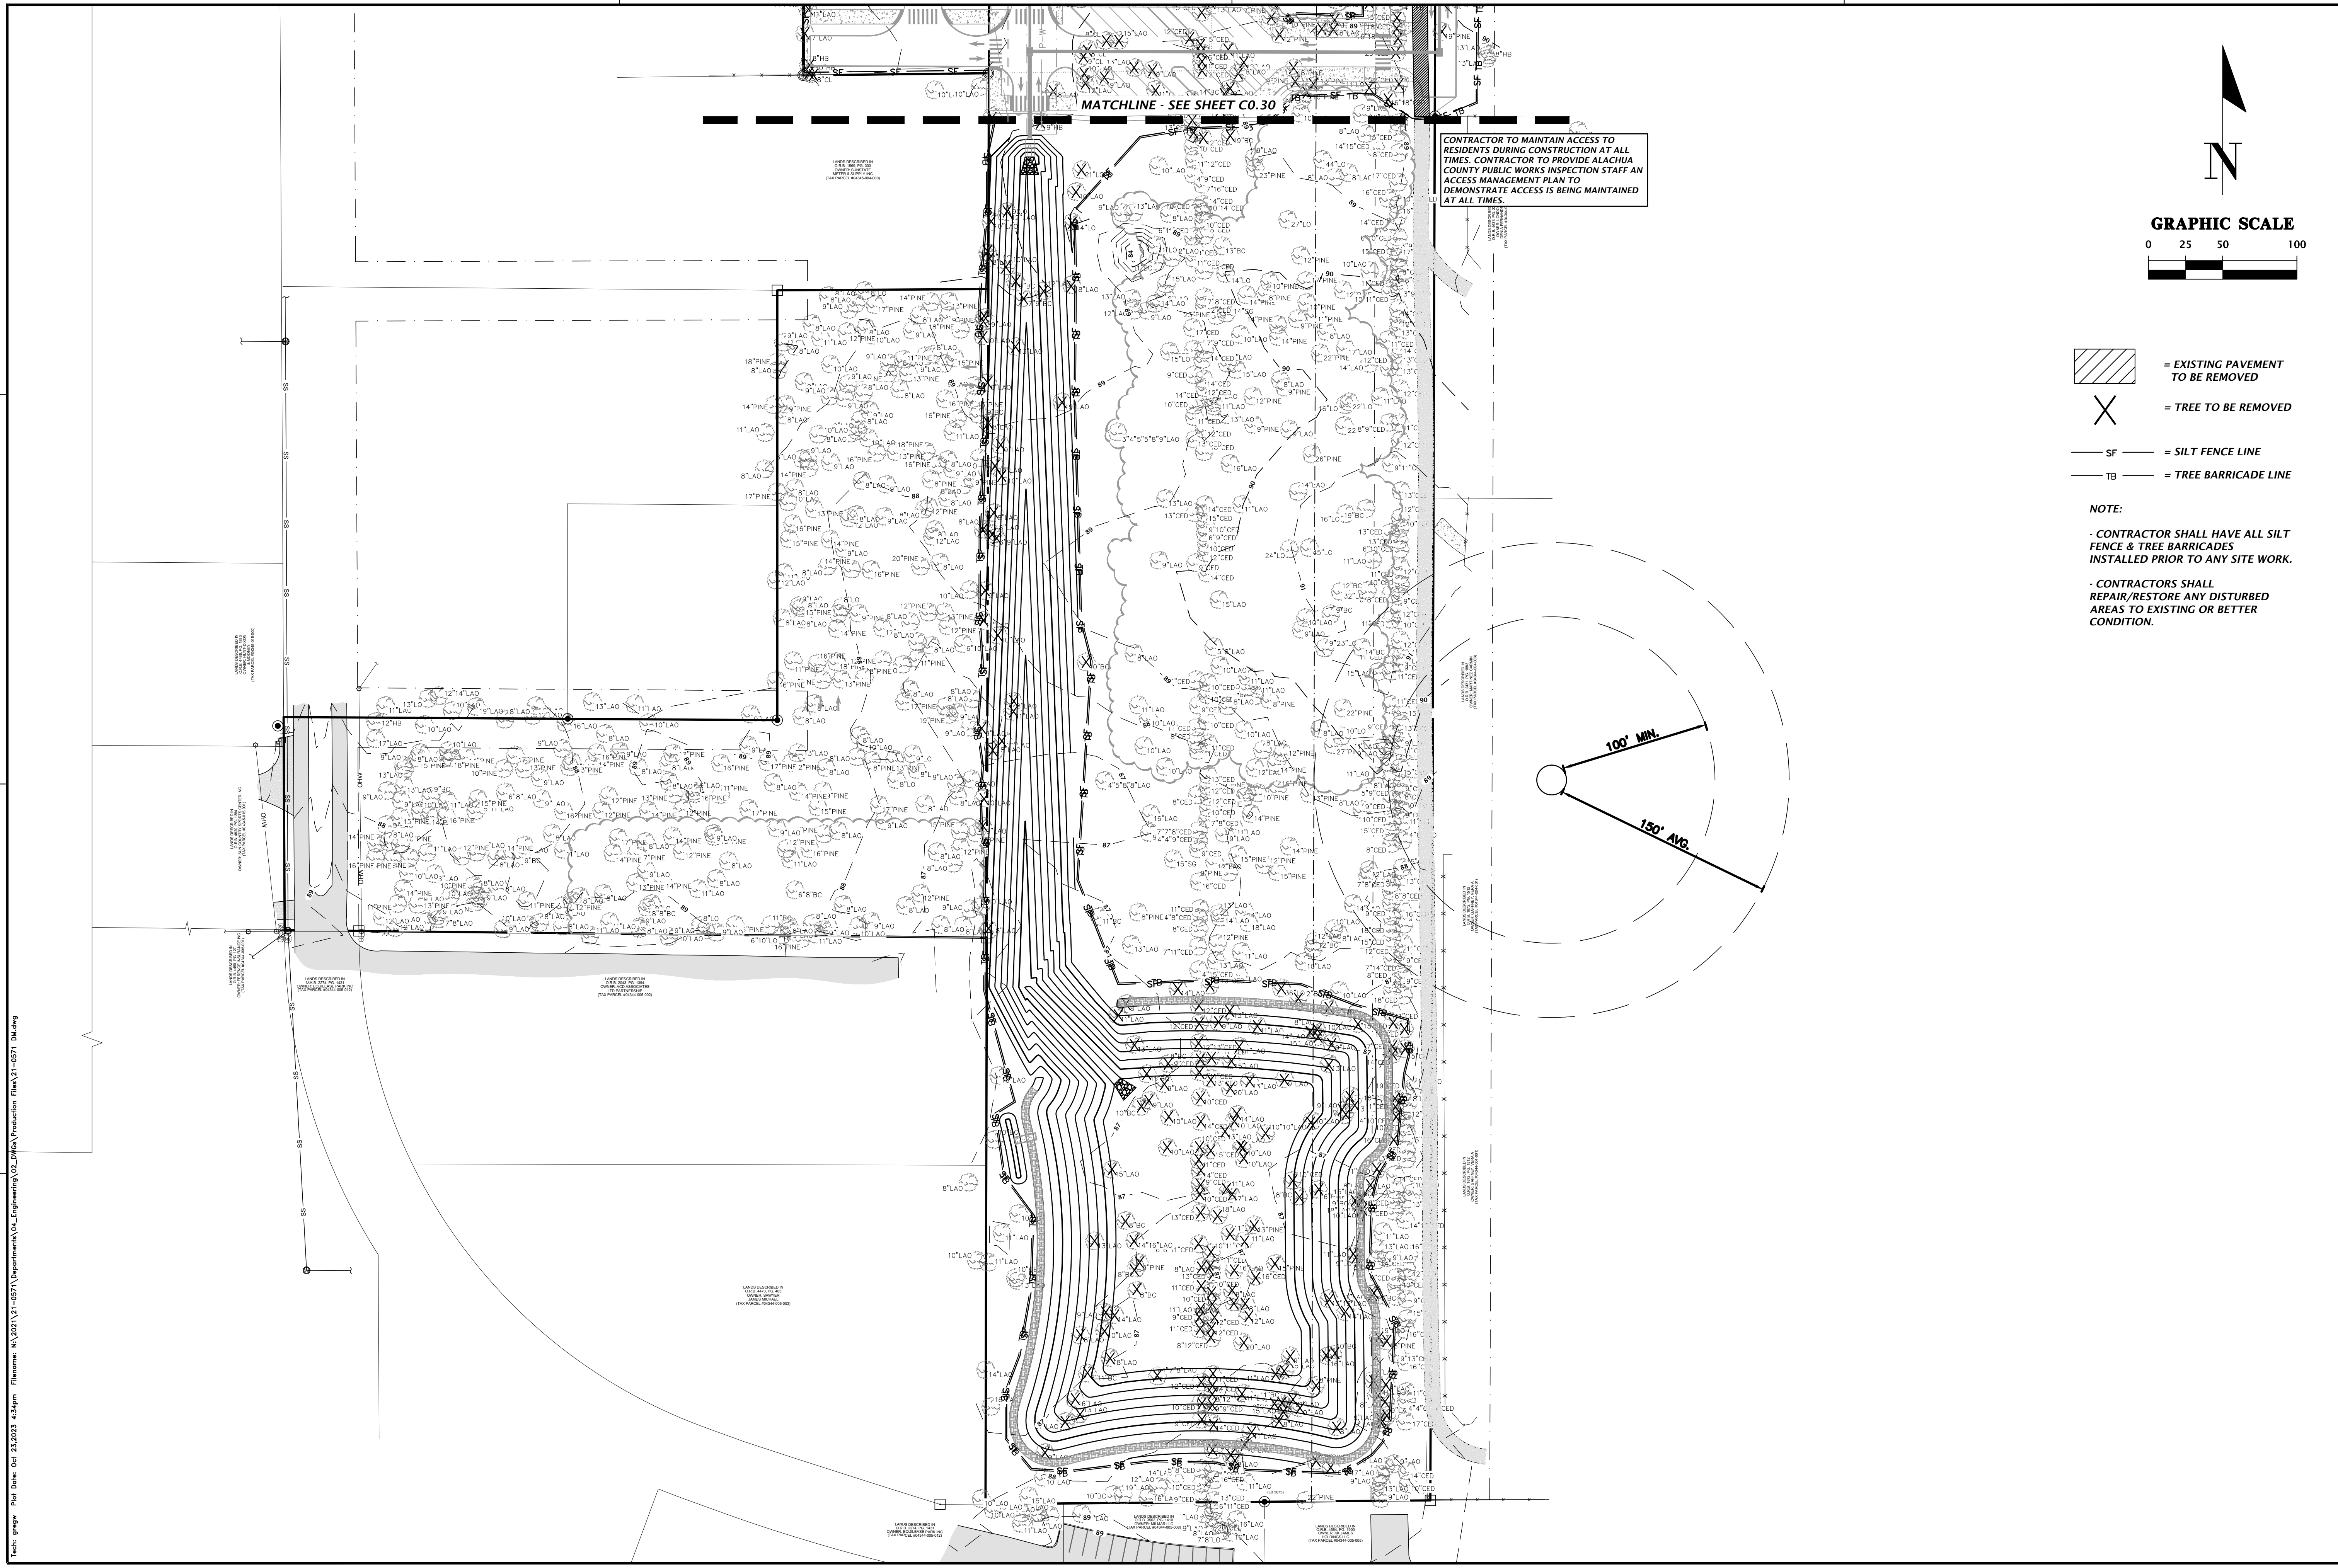



LEGEND:

-  EXISTING TREE CANOPY ELIGIBLE FOR RETENTION CREDIT
-  EXISTING TREE CANOPY TO BE RETAINED

### TREE CANOPY PLAN NOTES

1. ULDC § 406.12(a)2 REQUIRES THAT DEVELOPMENT PLANS AND SUBDIVISION PLATS SHALL BE DESIGNED SUCH THAT A MINIMUM OF 20% OF THE TREE CANOPY SHOWN ON THE MOST RECENT AERIALS OF THE PROPERTY AVAILABLE AT THE TIME OF APPLICATION IS RETAINED.

TREE CANOPY (FULL SITE)			
EXISTING (ACRES)	MIN REQUIRED (ACRES)	RETAINED (ACRES)	RETAINED % OF TOTAL
12.33	2.47	2.51	20.4%

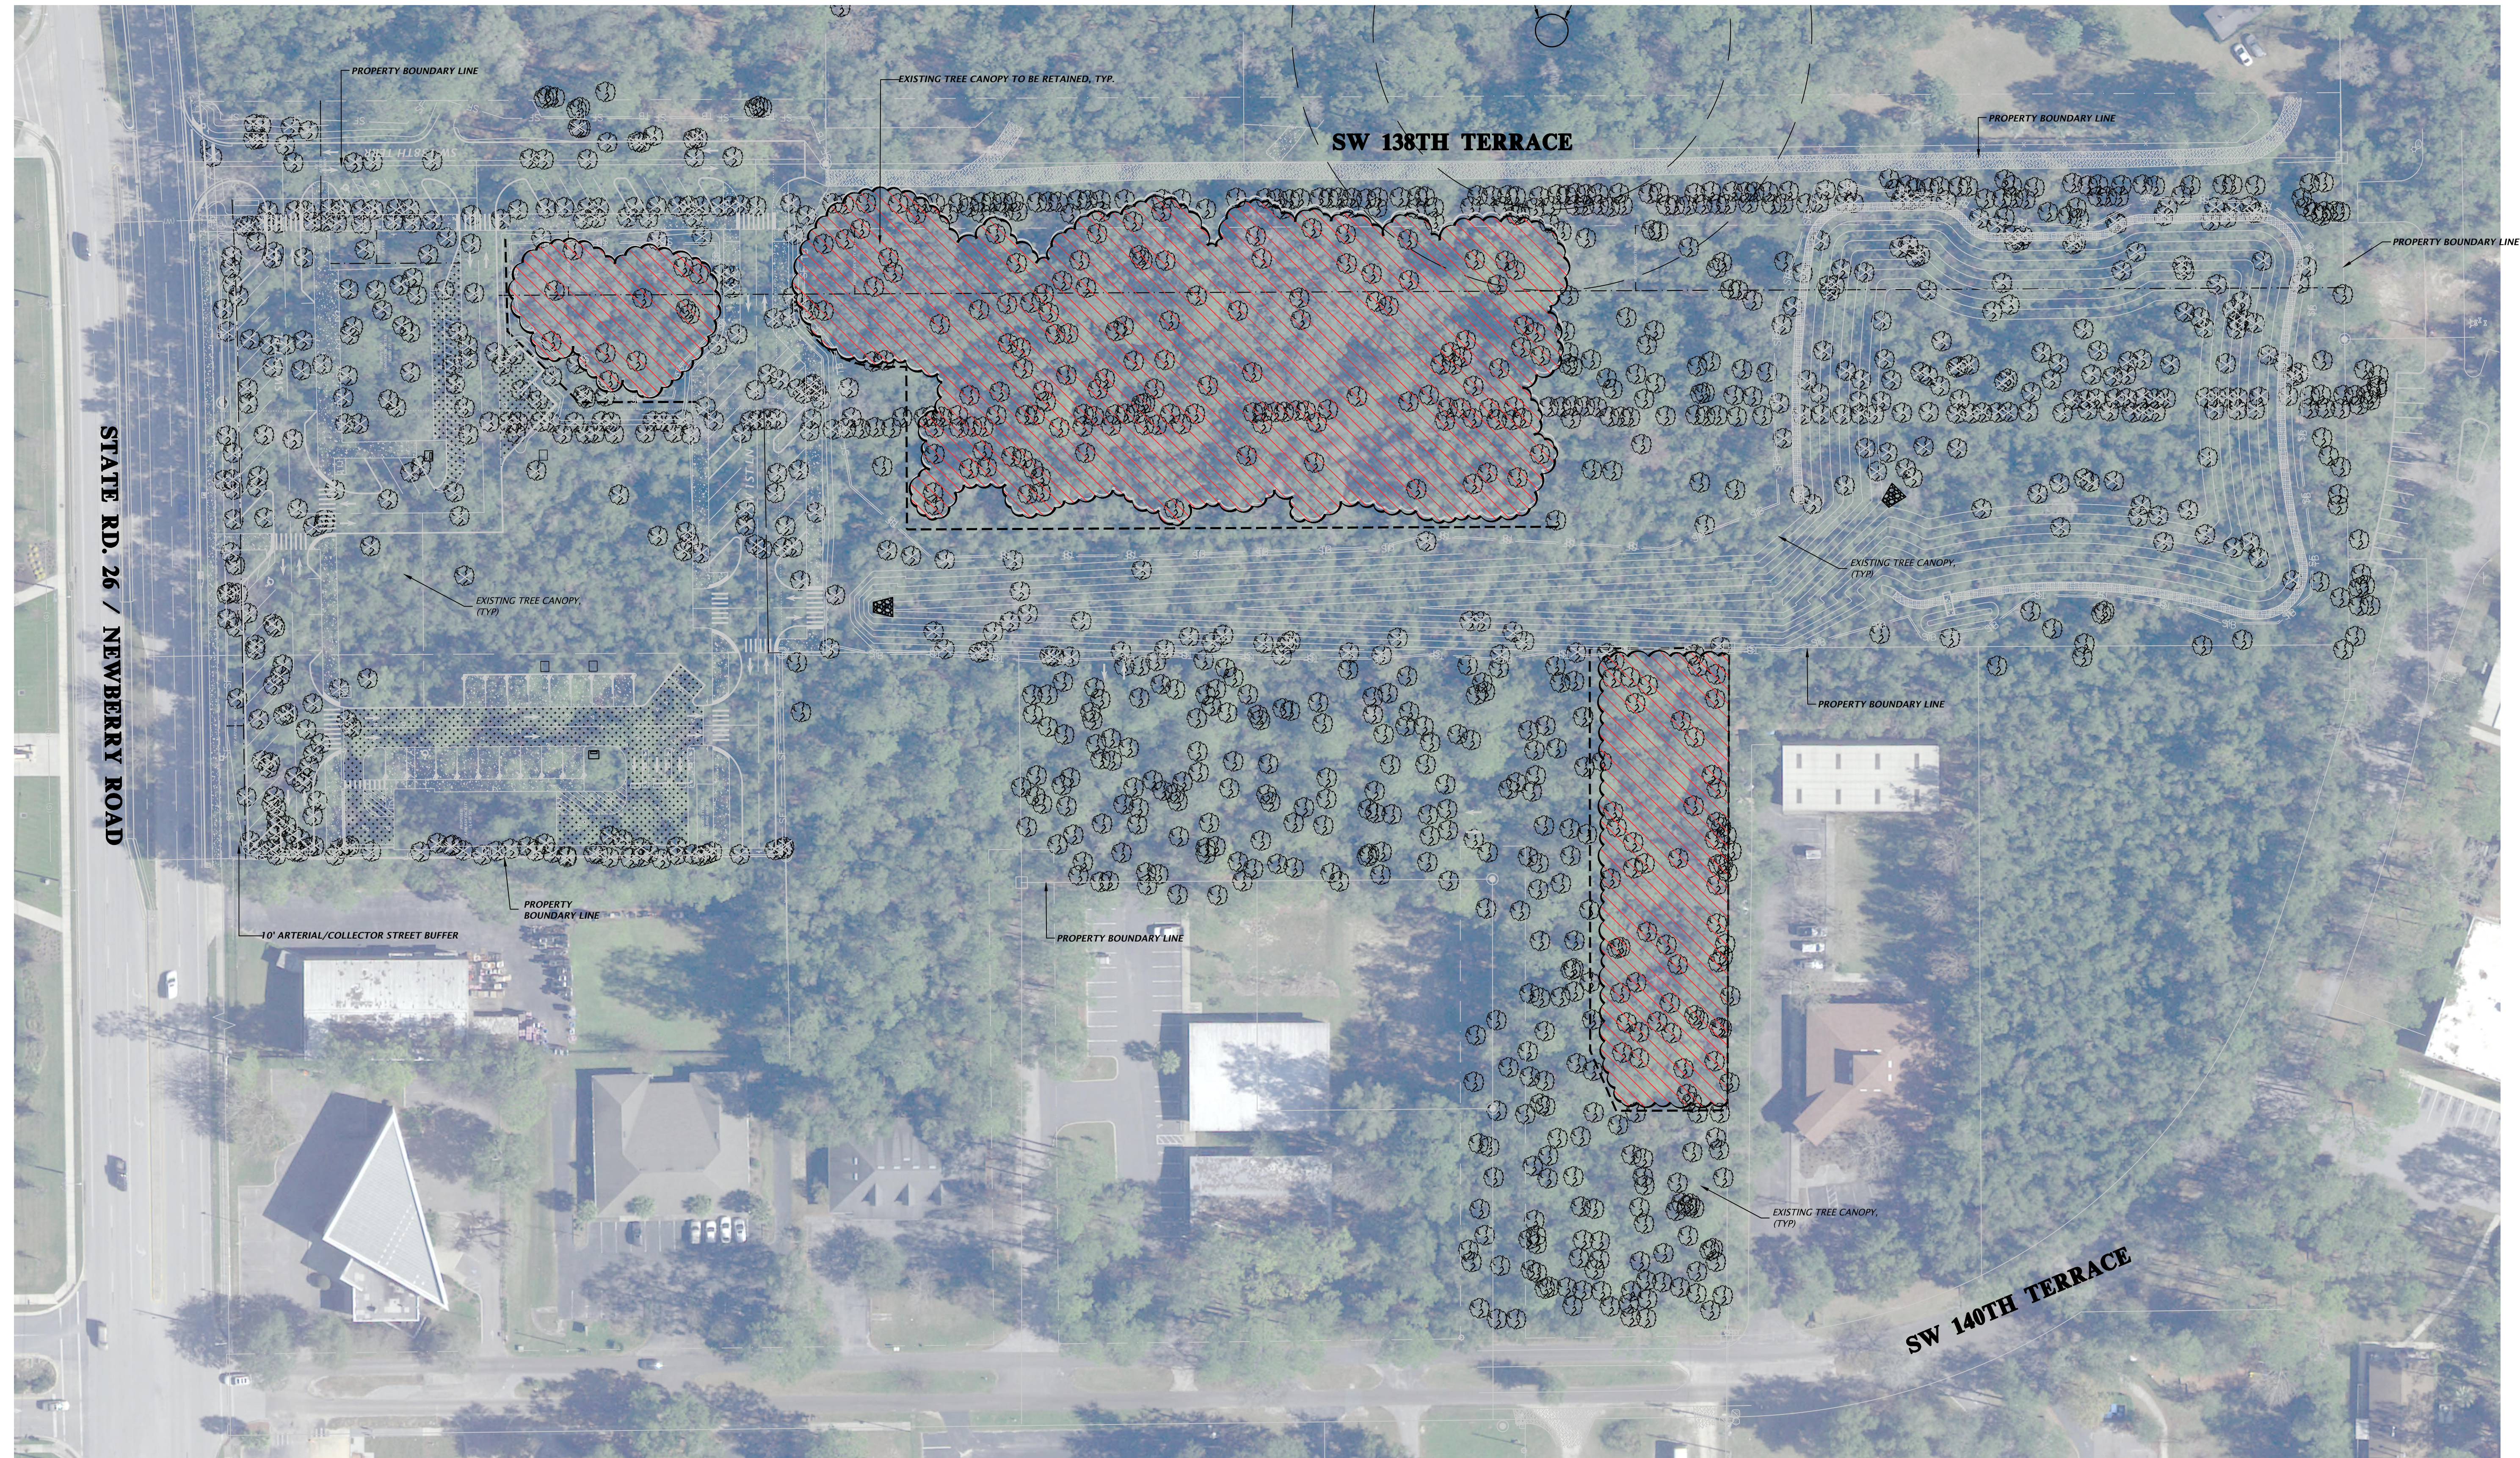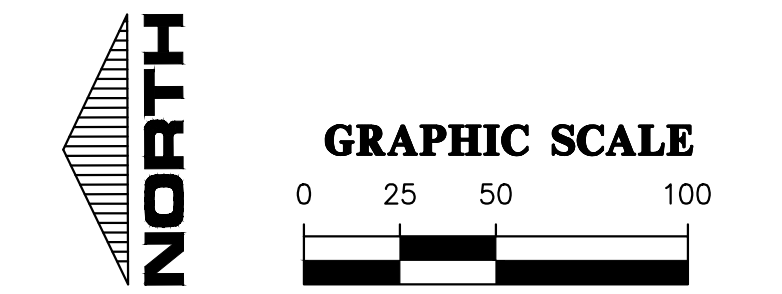

**CHWA** Professional Consultants

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(352) 351-1976  
www.chwa-inc.com  
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CA-5075

1"=50'  
VERIFY SCALE  
BAR IS ONE INCH ON  
GRAPHICAL DIMENSIONS  
IF NOT ONE INCH ON  
SCALE ACCORDINGLY

CONSTRUCTION AND REVISIONS

SUBMITTALS  
6/5/23 - SUBMITTAL TO ALACHUA COUNTY, CRU, FOOT, AND SRWMD  
7/31/23 - SUBMITTAL TO ALACHUA COUNTY, CRU, FOOT, AND SRWMD  
10/10/23 - SUBMITTAL TO CRU & FOOT  
10/23/23 - BID SET



CLIENT: FLETCHER DEVELOPMENT  
PROJECT: FLETCHER CENTER EAST  
SHEET TITLE: TREE CANOPY RETENTION PLAN

TECHNICIAN: G. WADZINSKI  
DESIGNER: G. LEDFORD, E.I.  
QUALITY CONTROL: D. YOUNG, P.E.  
PROJECT NUMBER: 21-0571


DATE: Daniel H. Young, P.E.  
State of Florida, Professional Engineer, License No. 78780  
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
FL PE No. 70780  
SHEET NO. C0.40



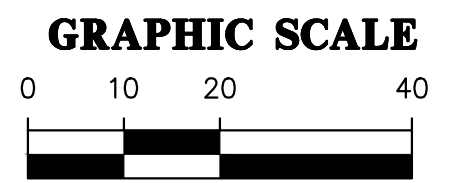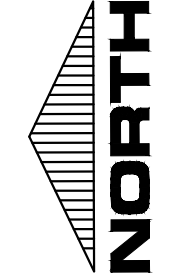


**LEGEND:**

 EXISTING TREE CANOPY ELIGIBLE FOR RETENTION CREDIT


 EXISTING TREE CANOPY TO BE RETAINED

**ENLARGEMENT A**

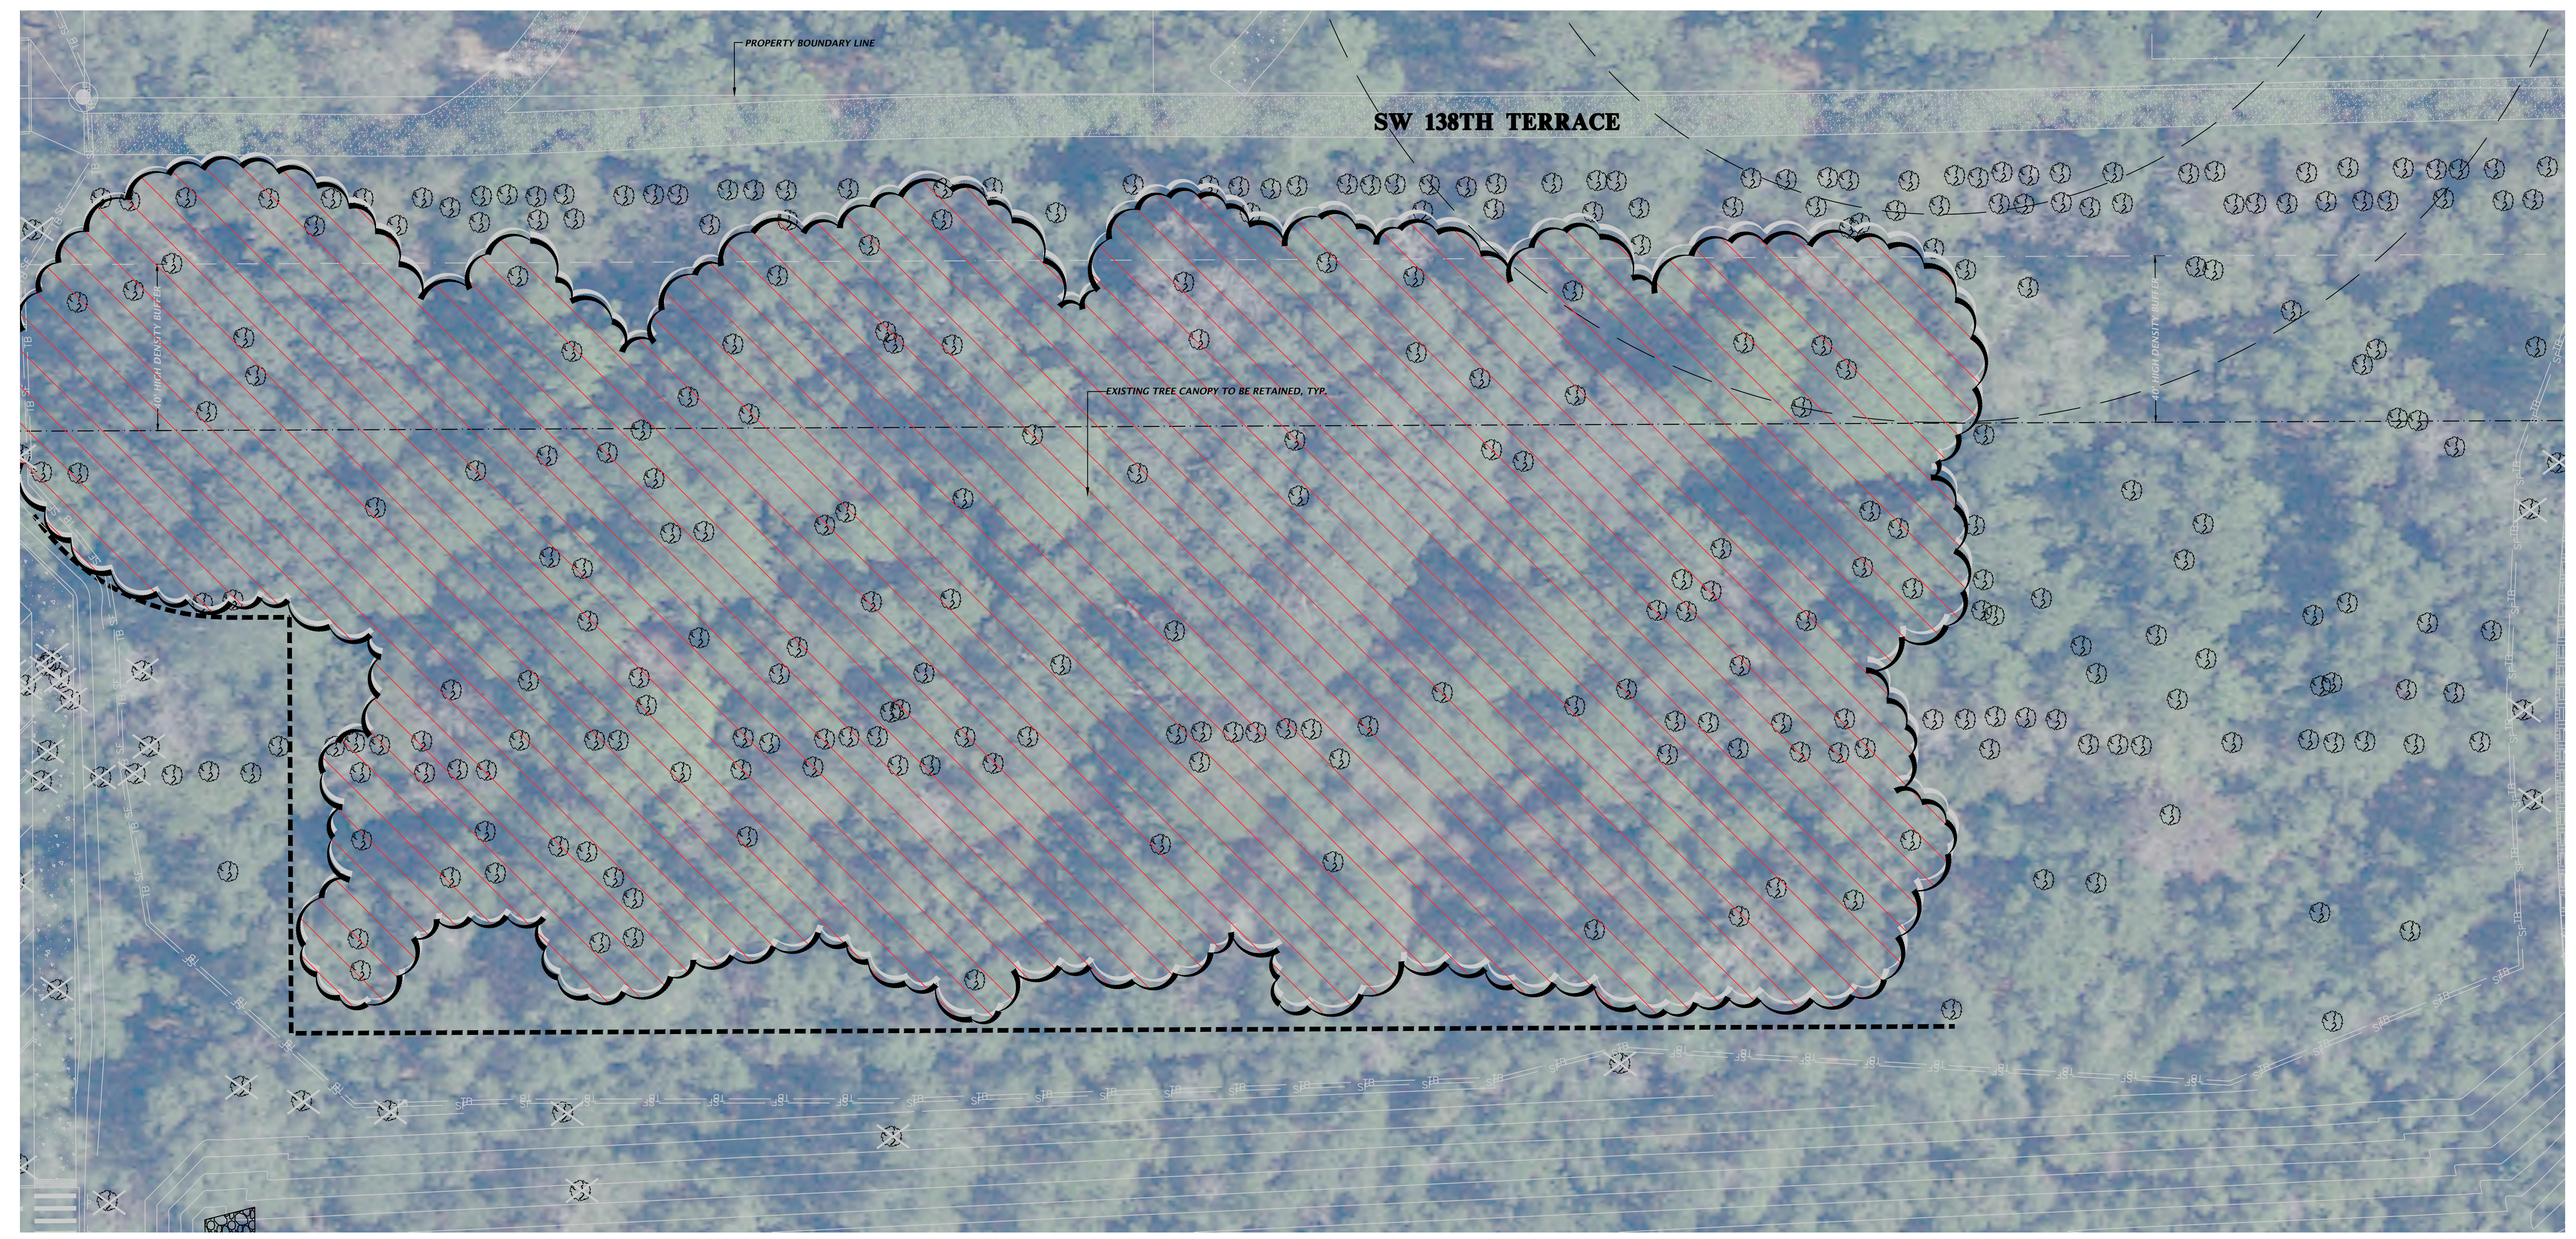

Text: gmp For Date: Oct 23, 2023 4:58pm Filename: N:\2023\11-0571\Department\GA\_Engineering\GA\_DWG\Production\_Plan\11-0571\_Plan.dwg

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SCALE: 1" = 20'  
VERIFY SCALE  
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ORIGINAL DRAWING  
IF NOT ONE INCH ON  
SCALES ACCORDINGLY.

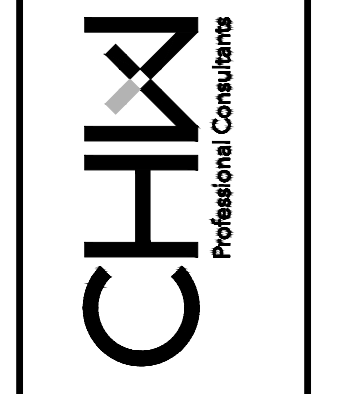CONSTRUCTION DIVISIONS

SUBMITTALS:  
6/5/23 - SUBMITTAL TO ALACHUA COUNTY, CRU, FOOT, AND SRWMD  
7/31/23 - SUBMITTAL TO ALACHUA COUNTY, CRU, FOOT, AND SRWMD  
10/10/23 - SUBMITTAL TO ALACHUA COUNTY  
10/23/23 - BID SET


CLIENT:	FLETCHER DEVELOPMENT
PROJECT:	FLETCHER CENTER EAST
SHEET TITLE:	DETAILED TREE CANOPY RETENTION PLAN
PROJECT NUMBER:	21-0571

TECHNICIAN: G. WADZINSKI  
DESIGNER: G. LEDFORD, E.I.  
QUALITY CONTROL: D. YOUNG, P.E.  
PROJECT NUMBER: 21-0571




DANIEL H. YOUNG  
Daniel H. Young, P.E.  
State of Florida, Professional Engineer, License No. 70780  
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**ENLARGEMENT B**



**ENLARGEMENT C**

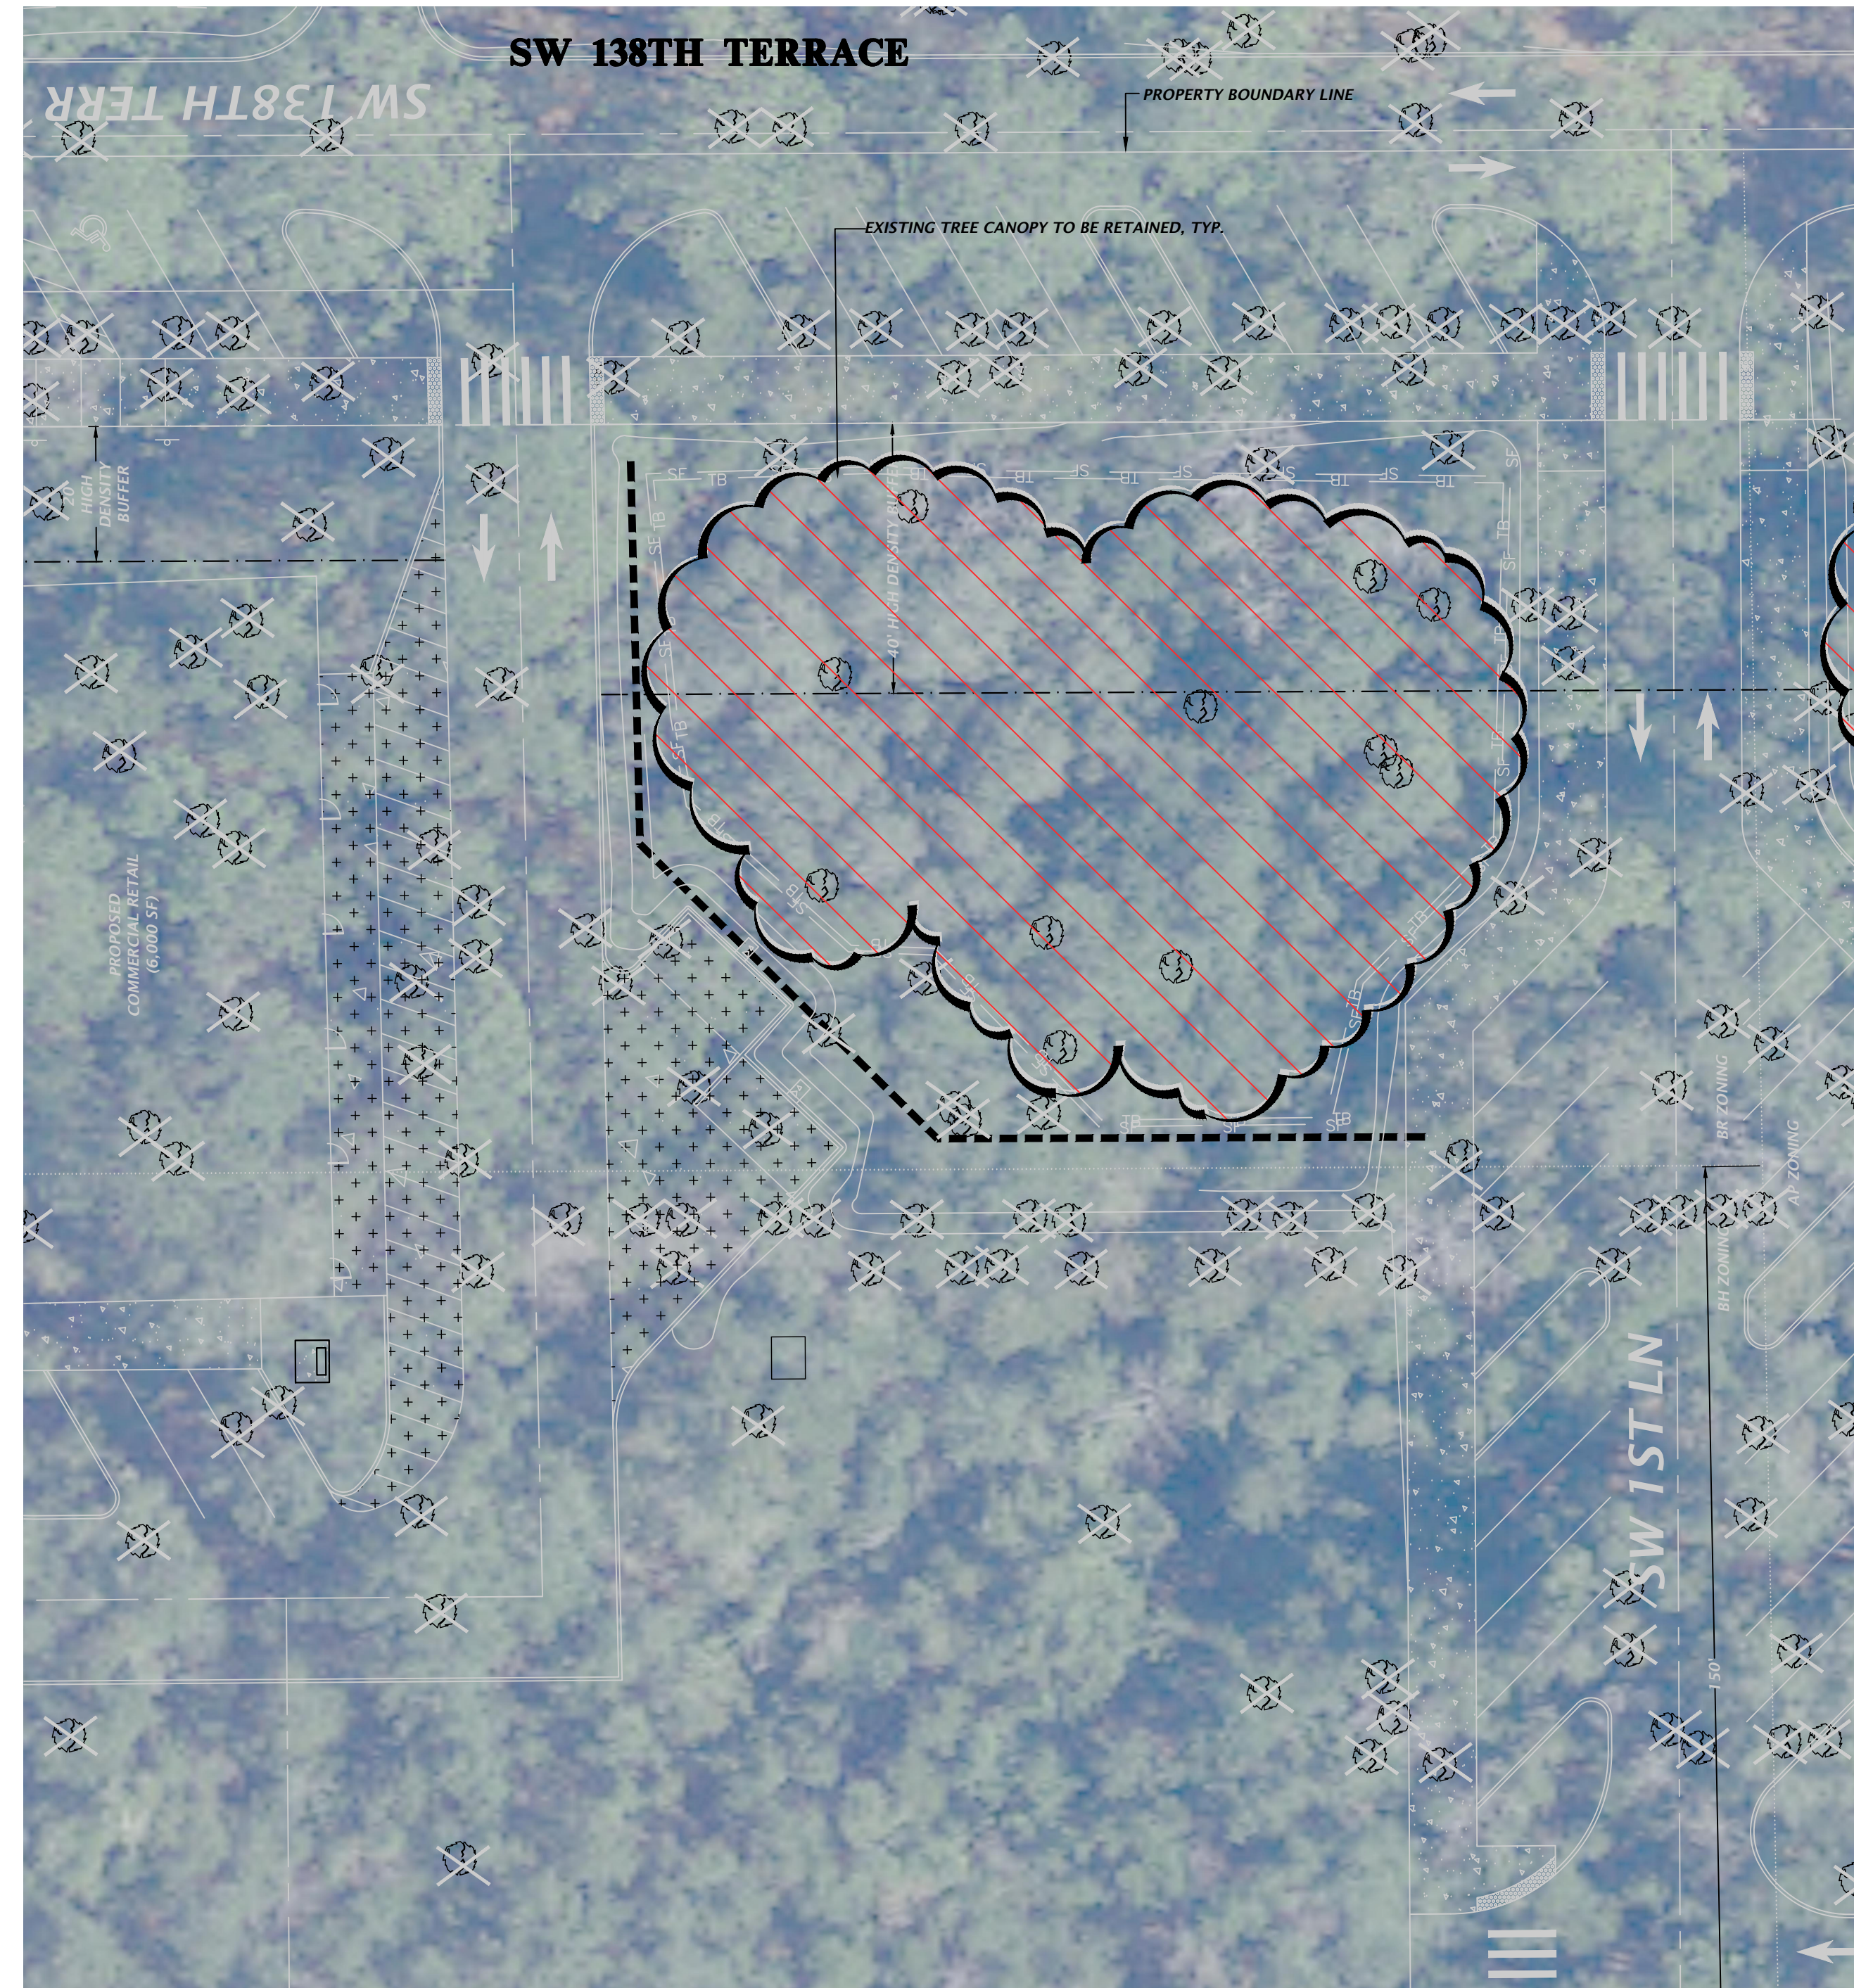


- LEGEND:**
- EXISTING TREE CANOPY ELIGIBLE FOR RETENTION CREDIT
  - EXISTING TREE CANOPY TO BE RETAINED

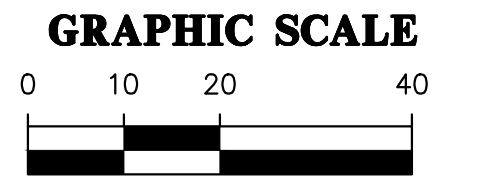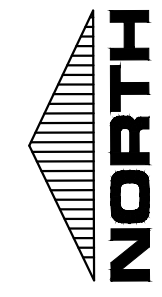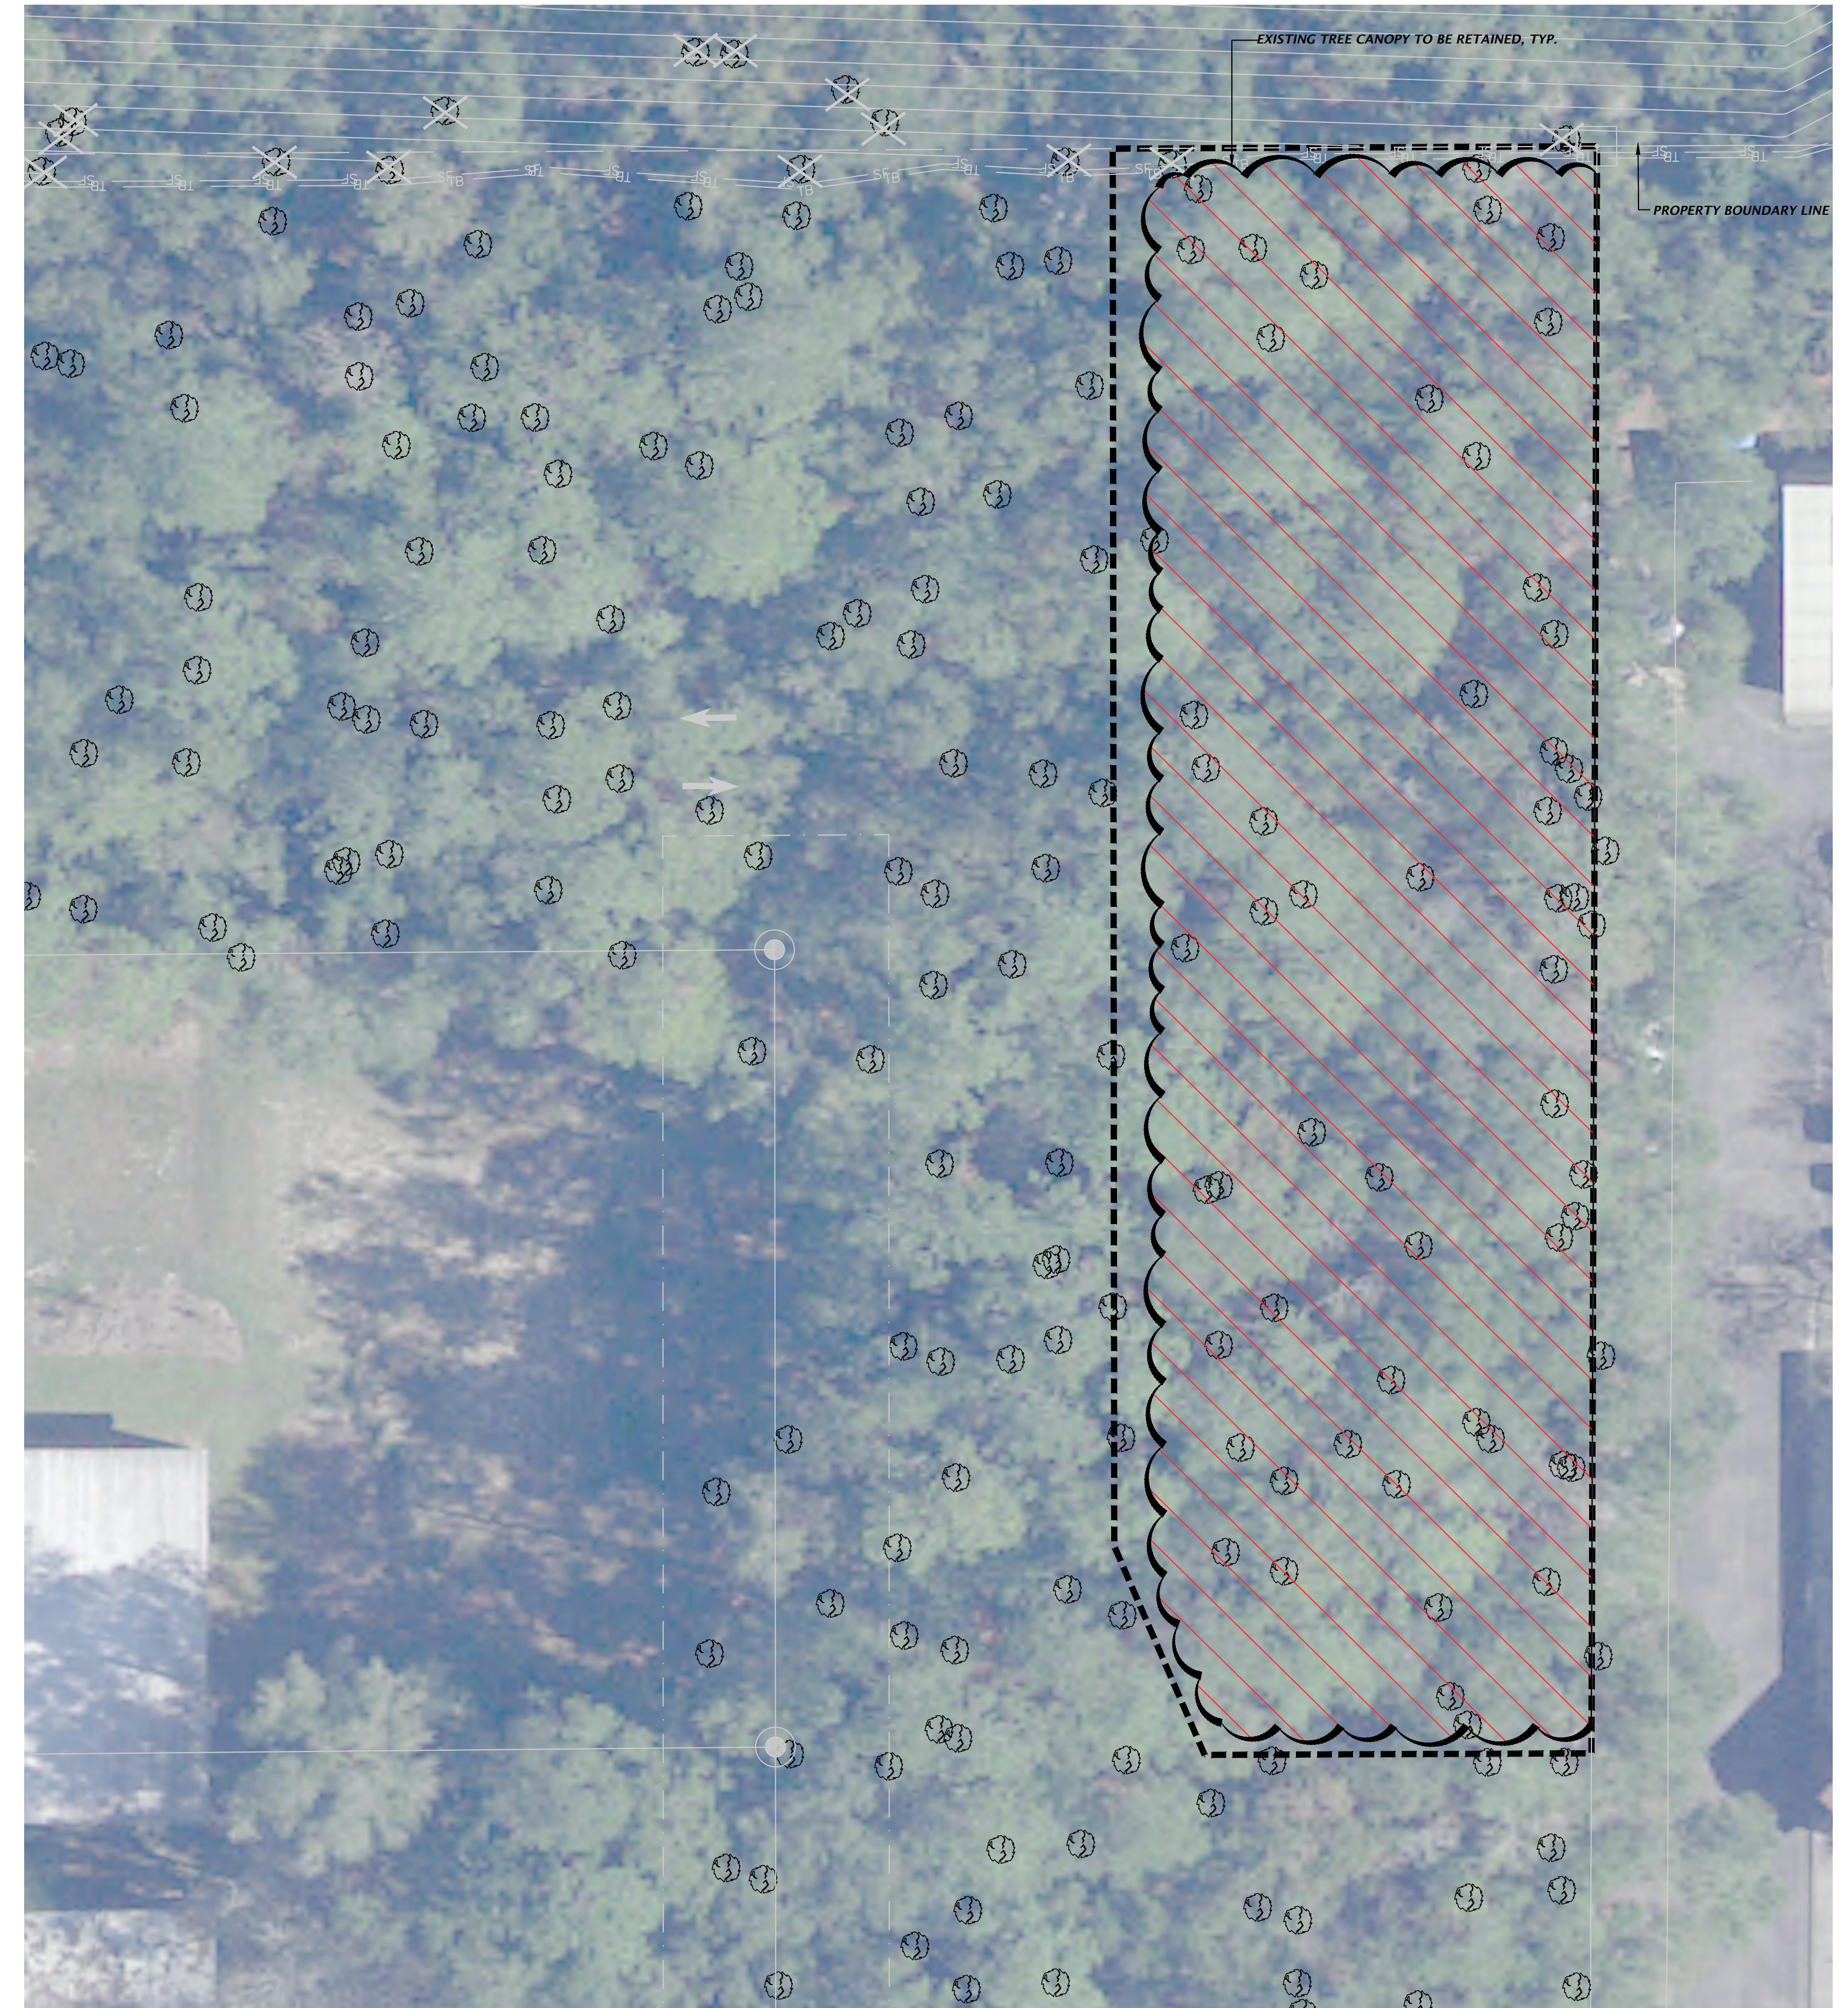Title: pppp For Date: Oct 23, 2023 4:55pm Filename: N:\2023\11-0571\Department\CA\_Engineering\02\_DWG\Production\_Plan\21-0571\_PPP.dwg

11801 Research Drive Alachua, Florida 32615 (352) 351-1976 www.chia-inc.com est. 1988 FLORIDA CA-5075	
SCALE: 1" = 20' VERIFY SCALE BAR IS ONE INCH ON ORIGINAL DRAWING IF NOT ONE INCH ON SCALES ACCORDINGLY.	
SUBMITTALS: 6/5/23 - SUBMITTAL TO ALACHUA COUNTY, CRU, FOOT, AND SKWMD 7/31/23 - SUBMITTAL TO ALACHUA COUNTY, CRU, FOOT, AND SKWMD 10/10/23 - SUBMITTAL TO CRU & FOOT 10/23/23 - BID SET	
CLIENT: FLETCHER DEVELOPMENT	PROJECT: FLETCHER CENTER EAST
TECHNICAL: G. WADZINSKI DESIGNER: C. LEDFORD, E.I. QUALITY CONTROL: D. YOUNG, P.E.	SHEET TITLE: DETAILED TREE CANOPY RETENTION PLAN PROJECT NUMBER: 21-0571
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FL PE No. 70780 SHEET NO.: C0.42	




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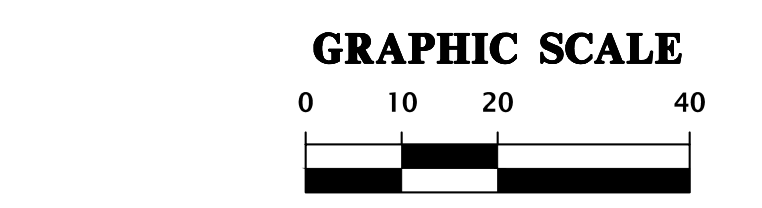
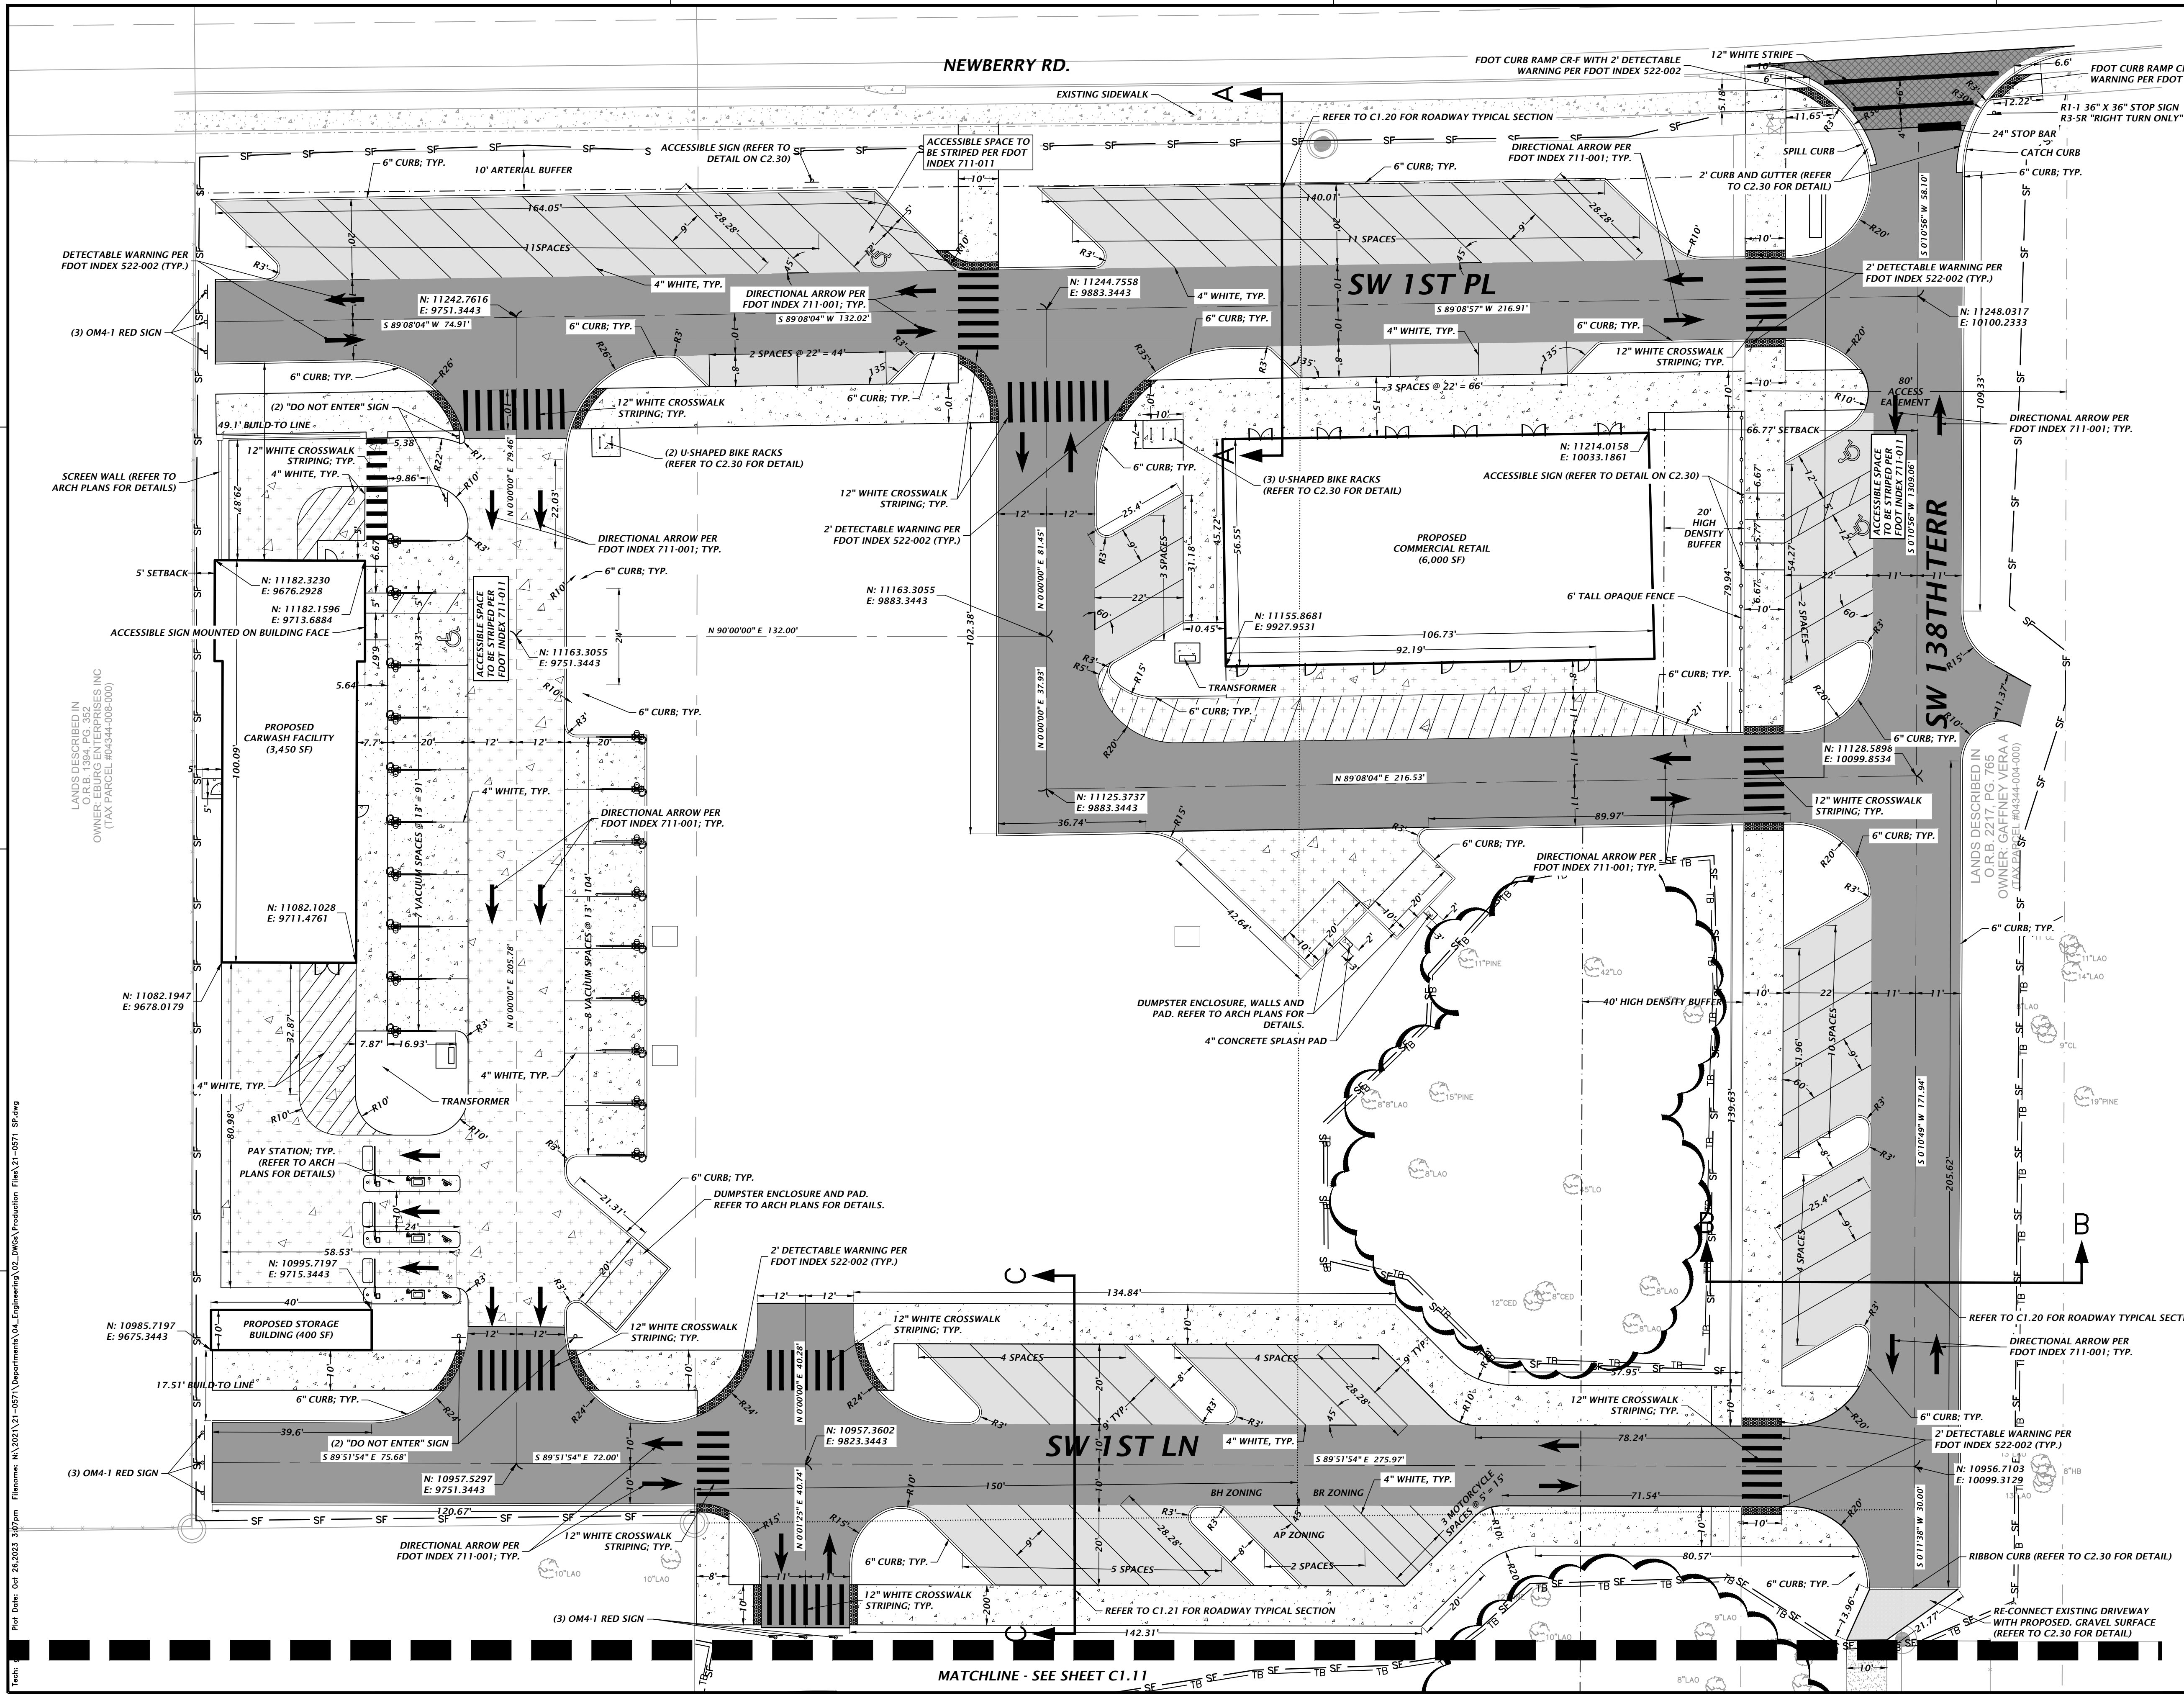
PHASE 1: CONSTRUCTION OF THE ≈6,000 SF RETAIL PORTION OF THE NORTHERN BLOCK. COMPLETE CONSTRUCTION OF EASTERN BLOCK. CONSTRUCTION OF MASTER STORMWATER POND AND SWALE.

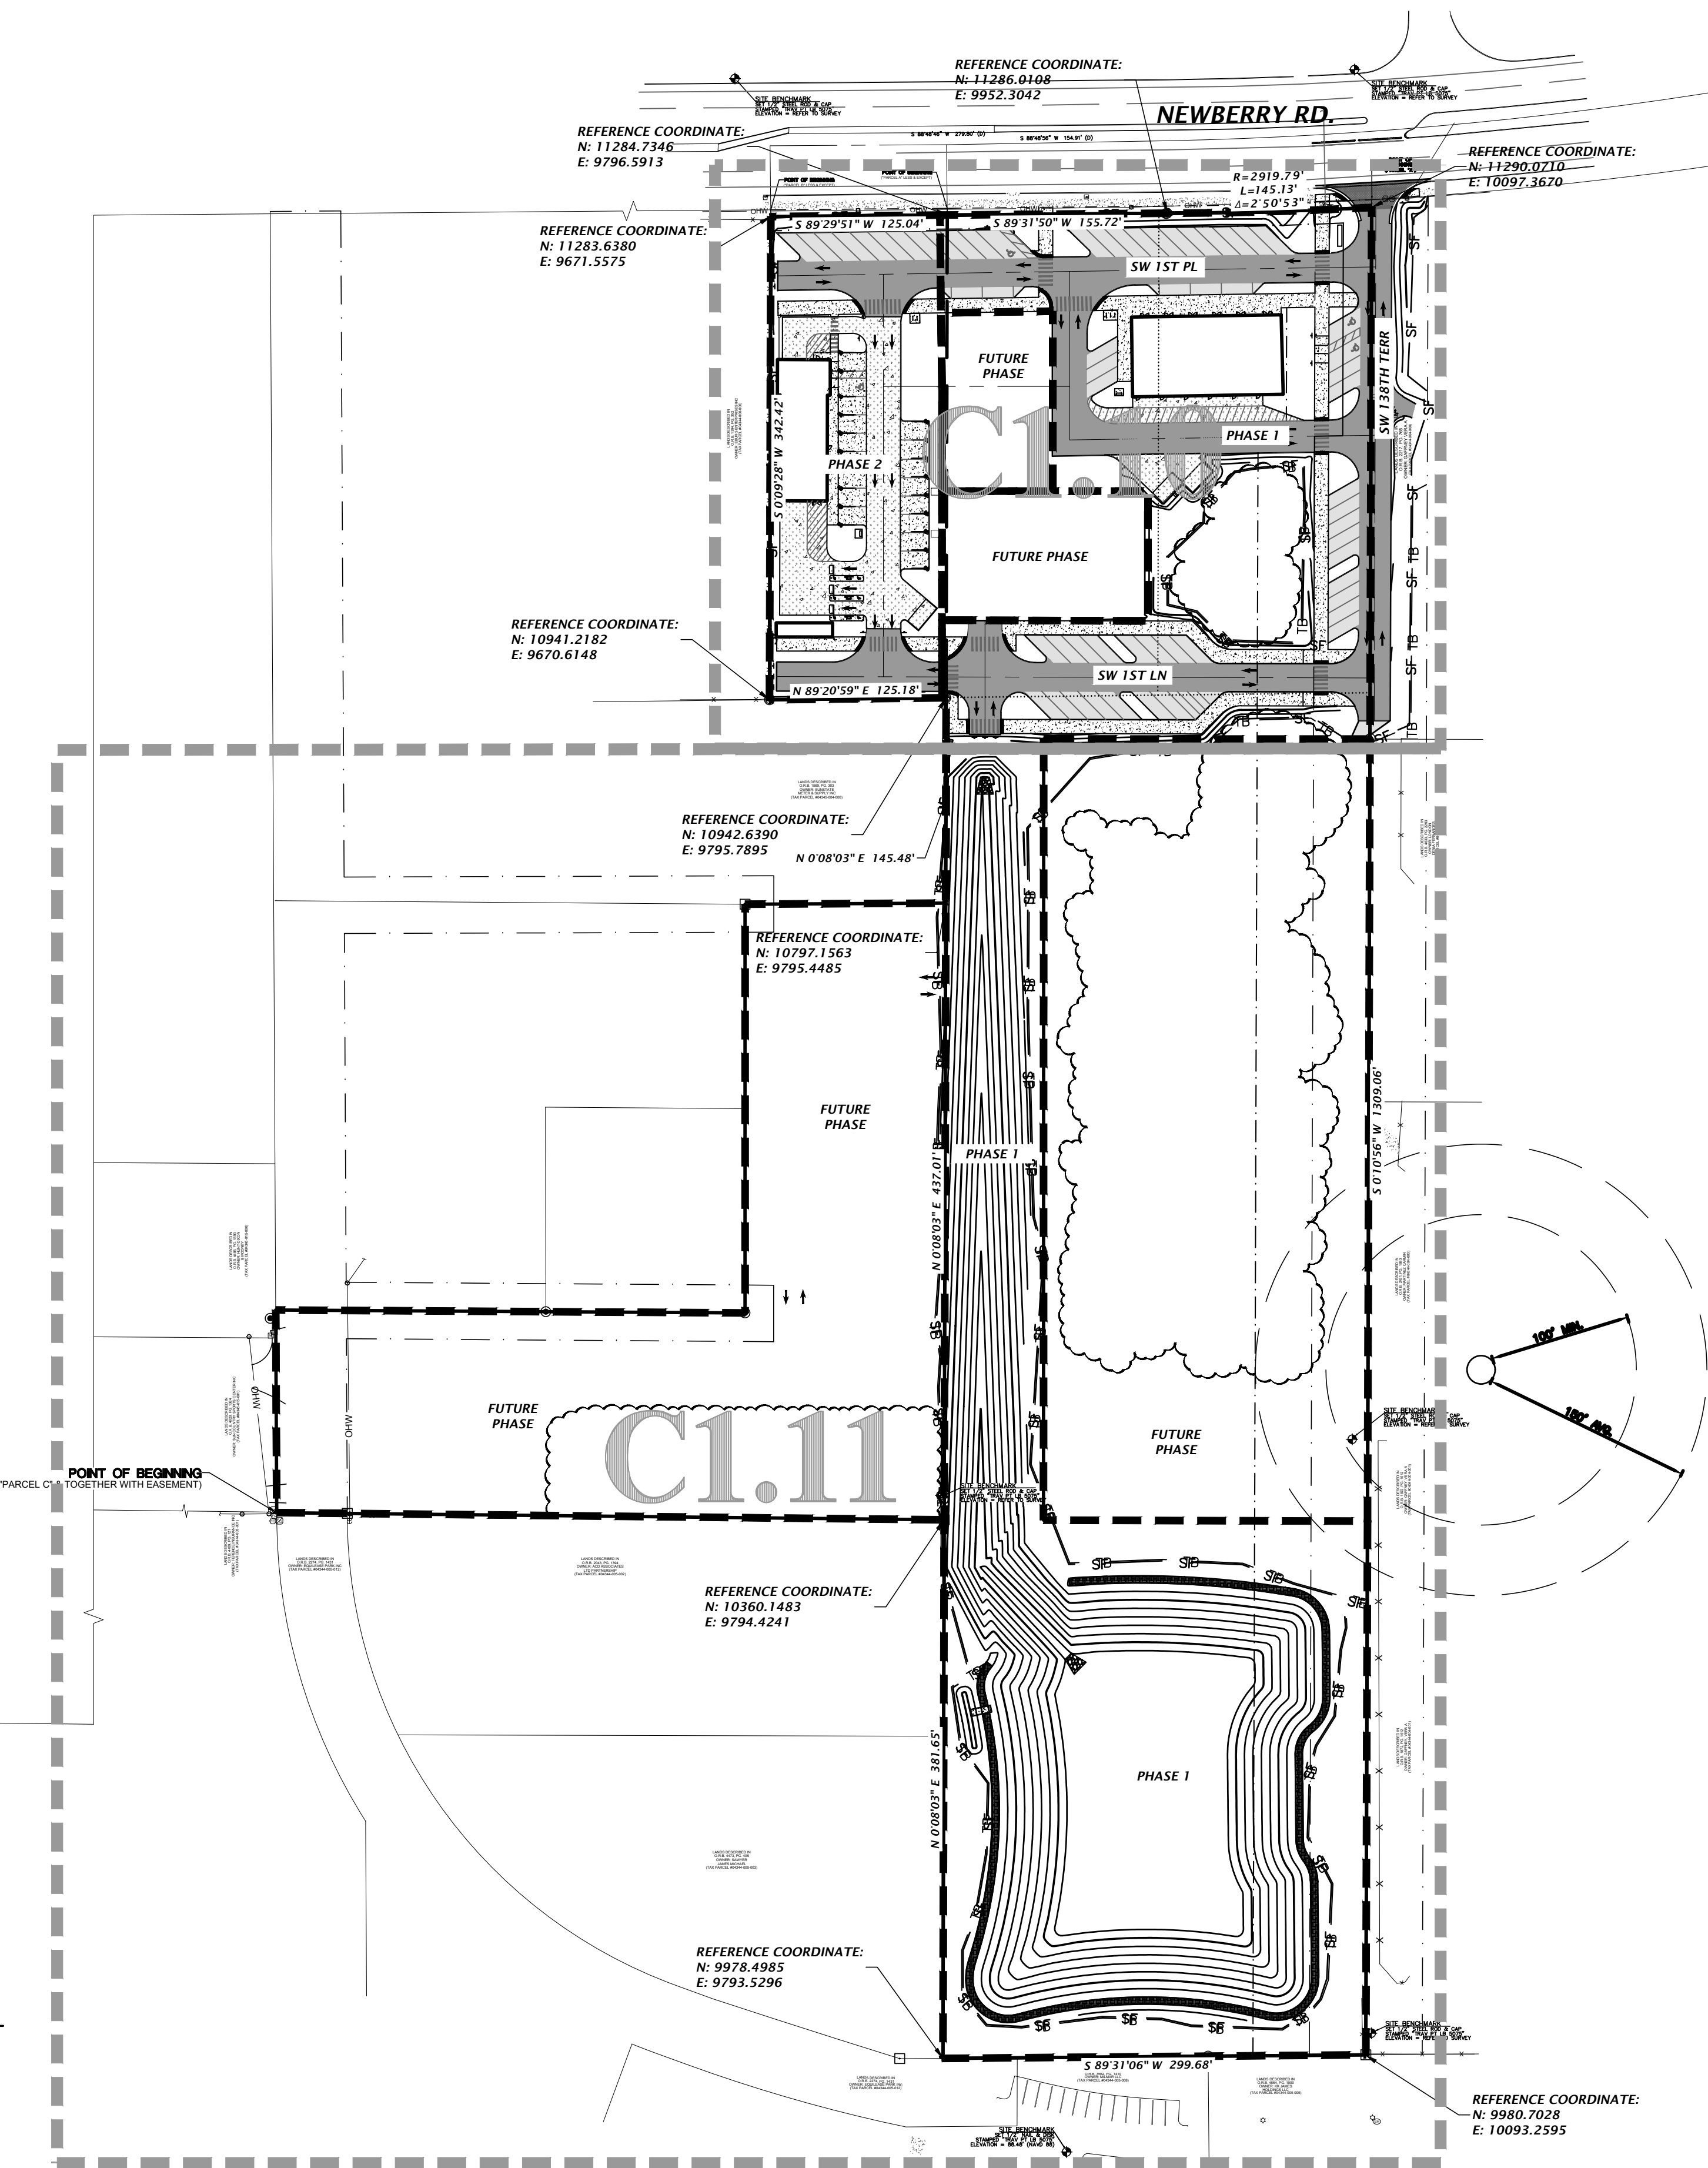PHASE 2: CONSTRUCTION OF THE ≈3,450 SF CARWASH FACILITY AND ≈400 SF STORAGE BUILDING, ALONG WITH COMPLETION OF THE NORTHERN BLOCK.

FUTURE PHASES: INFILL BETWEEN ROADWAYS.



<p>11801 Research Drive Alachua, Florida 32615 (352) 351-1976 www.chw-inc.com est. 1988 FLORIDA CA-5075</p>	
<p><b>CHW</b> Professional Consultants</p>	
<p>SCALE: 1"=80'</p> <p>VERIFY SCALE BAR IS ONE INCH ON 0" ORIGINAL DRAWING IF NOT ONE INCH ON SCALES ACCORDINGLY.</p>	<p>CONSTRUCTION AND REVISIONS:</p>
<p>TECHNICIAN: G. WADZINSKI</p> <p>DESIGNER: G. LEDWOLD, E.I.</p> <p>QUALITY CONTROL: D. YOUNG, P.E.</p> <p>PROJECT NUMBER: 21-0571</p>	<p>CLIENT: FLETCHER DEVELOPMENT</p> <p>PROJECT: FLETCHER CENTER EAST</p> <p>SHEET TITLE: MASTER SITE PLAN</p>
<p>DATE: 10/23/23</p> <p>PROJECT: 21-0571</p> <p>PROJECT NUMBER: 21-0571</p>	<p>6/5/23 - SUBMITTAL TO ALACHUA COUNTY, CRU, FOOT, AND SRMWD</p> <p>7/31/23 - SUBMITTAL TO ALACHUA COUNTY, CRU, FOOT, AND SRMWD</p> <p>10/10/23 - SUBMITTAL TO CRU &amp; FOOT</p> <p>10/23/23 - BID SET</p>
<p>TECHNICAL REVIEW: DANIEL H. YOUNG, P.E. State of Florida, Professional Engineer, License No. 70780</p> <p>This item has been digitally signed and sealed by Daniel H. Young, P.E., on the date indicated here: 10/26/2023</p> <p>Printed copies of this document are not considered signed and sealed and the signature must be verified on any electronic copies.</p>	
<p>FL PE No. 70780</p> <p>SHEET NO. <b>C1.00</b></p>	

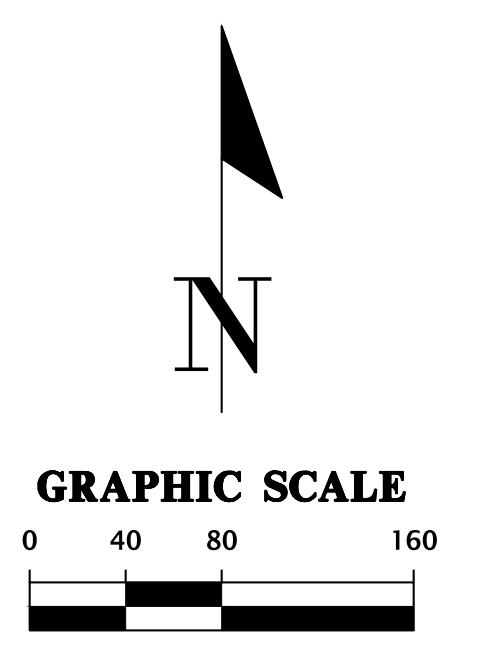

- = CONCRETE SIDEWALK (REFER TO C2.30 FOR DETAIL)
- = HEAVY DUTY CONCRETE PAVEMENT (REFER TO C2.30 FOR DETAIL)
- = STANDARD DUTY ASPHALT PAVEMENT (REFER TO C2.30 FOR DETAIL)
- = HEAVY DUTY ASPHALT PAVEMENT (REFER TO C2.30 FOR DETAIL)
- = FDOT ROW ASPHALT PAVEMENT (REFER TO C2.30 FOR DETAIL)

**NOTES:**  
 1) SEE SURVEY FOR BENCHMARK ELEVATIONS, LOCATIONS, AND DESCRIPTIONS.  
 2) CONTRACTOR SHALL REPAIR/RESTORE ANY DISTURBED AREAS TO EXISTING CONDITIONS OR BETTER.

FOR COORDINATION REFERENCE, REFER TO C1.00.

CONTRACTOR TO MAINTAIN ACCESS TO RESIDENTS DURING CONSTRUCTION AT ALL TIMES.  
 CONTRACTOR TO PROVIDE ALACHUA COUNTY PUBLIC WORKS INSPECTION STAFF AN ACCESS MANAGEMENT PLAN TO DEMONSTRATE ACCESS IS BEING MAINTAINED AT ALL TIMES.

File Name: N:\2024\21-0571\Department\04\_Engineering\02\_DWG\Production\Fla\21-0571\_Sp.dwg  
 Plot Date: Oct 24, 2023 3:07pm

LANDS DESCRIBED IN C1.00 ARE THE PROPERTY OF  
 OWNER: EUBORG ENTERPRISES INC  
 (TAX PARCEL #04344-008-000)

LANDS DESCRIBED IN C1.00 ARE THE PROPERTY OF  
 OWNER: GALEY, VERGA A  
 (TAX PARCEL #04344-004-000)

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 0" LONG. DIMENSIONS  
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SUBMITTALS:  
 6/5/23 - SUBMITTAL TO ALACHUA COUNTY, CRU, FDOT, AND SKWMD  
 7/31/23 - SUBMITTAL TO ALACHUA COUNTY, CRU, FDOT, AND SKWMD  
 10/10/23 - SUBMITTAL TO ALACHUA COUNTY  
 10/23/23 - BID SET

CLIENT:  
 FLETCHER DEVELOPMENT

PROJECT:  
 FLETCHER CENTER EAST  
 SHEET TITLE:  
 DETAILED HORIZONTAL CONTROL  
 AND SITE PLAN

DESIGNER:  
 G. LEDFORD, E.I.  
 QUALITY CONTROL:  
 D. YOUNG, P.E.

PROJECT NUMBER:  
 21-0571

ENGINEER:  
 DANIEL H. YOUNG, P.E.  
 State of Florida, Professional  
 Engineer, License No. 78780


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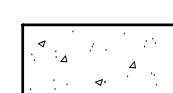
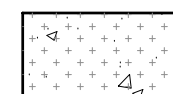


SHEET NO.:

C1.10





CONTRACTOR TO MAINTAIN ACCESS TO RESIDENTS DURING CONSTRUCTION AT ALL TIMES. CONTRACTOR TO PROVIDE ALACHUA COUNTY PUBLIC WORKS INSPECTION STAFF AN ACCESS MANAGEMENT PLAN TO DEMONSTRATE ACCESS IS BEING MAINTAINED AT ALL TIMES.

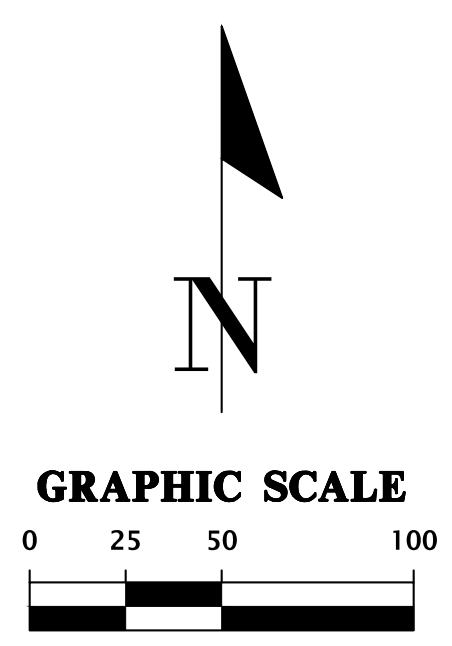


-  -CONCRETE SIDEWALK (REFER TO C2.30 FOR DETAIL)
-  -HEAVY DUTY CONCRETE PAVEMENT (REFER TO C2.30 FOR DETAIL)
-  -STANDARD DUTY ASPHALT PAVEMENT (REFER TO C2.30 FOR DETAIL)
-  -HEAVY DUTY ASPHALT PAVEMENT (REFER TO C2.30 FOR DETAIL)

NOTES:  
 1) SEE SURVEY FOR BENCHMARK ELEVATIONS, LOCATIONS, AND DESCRIPTIONS.  
 2) CONTRACTOR SHALL REPAIR/RESTORE ANY DISTURBED AREAS TO EXISTING CONDITIONS OR BETTER.

FOR COORDINATION REFERENCE, REFER TO C1.00.

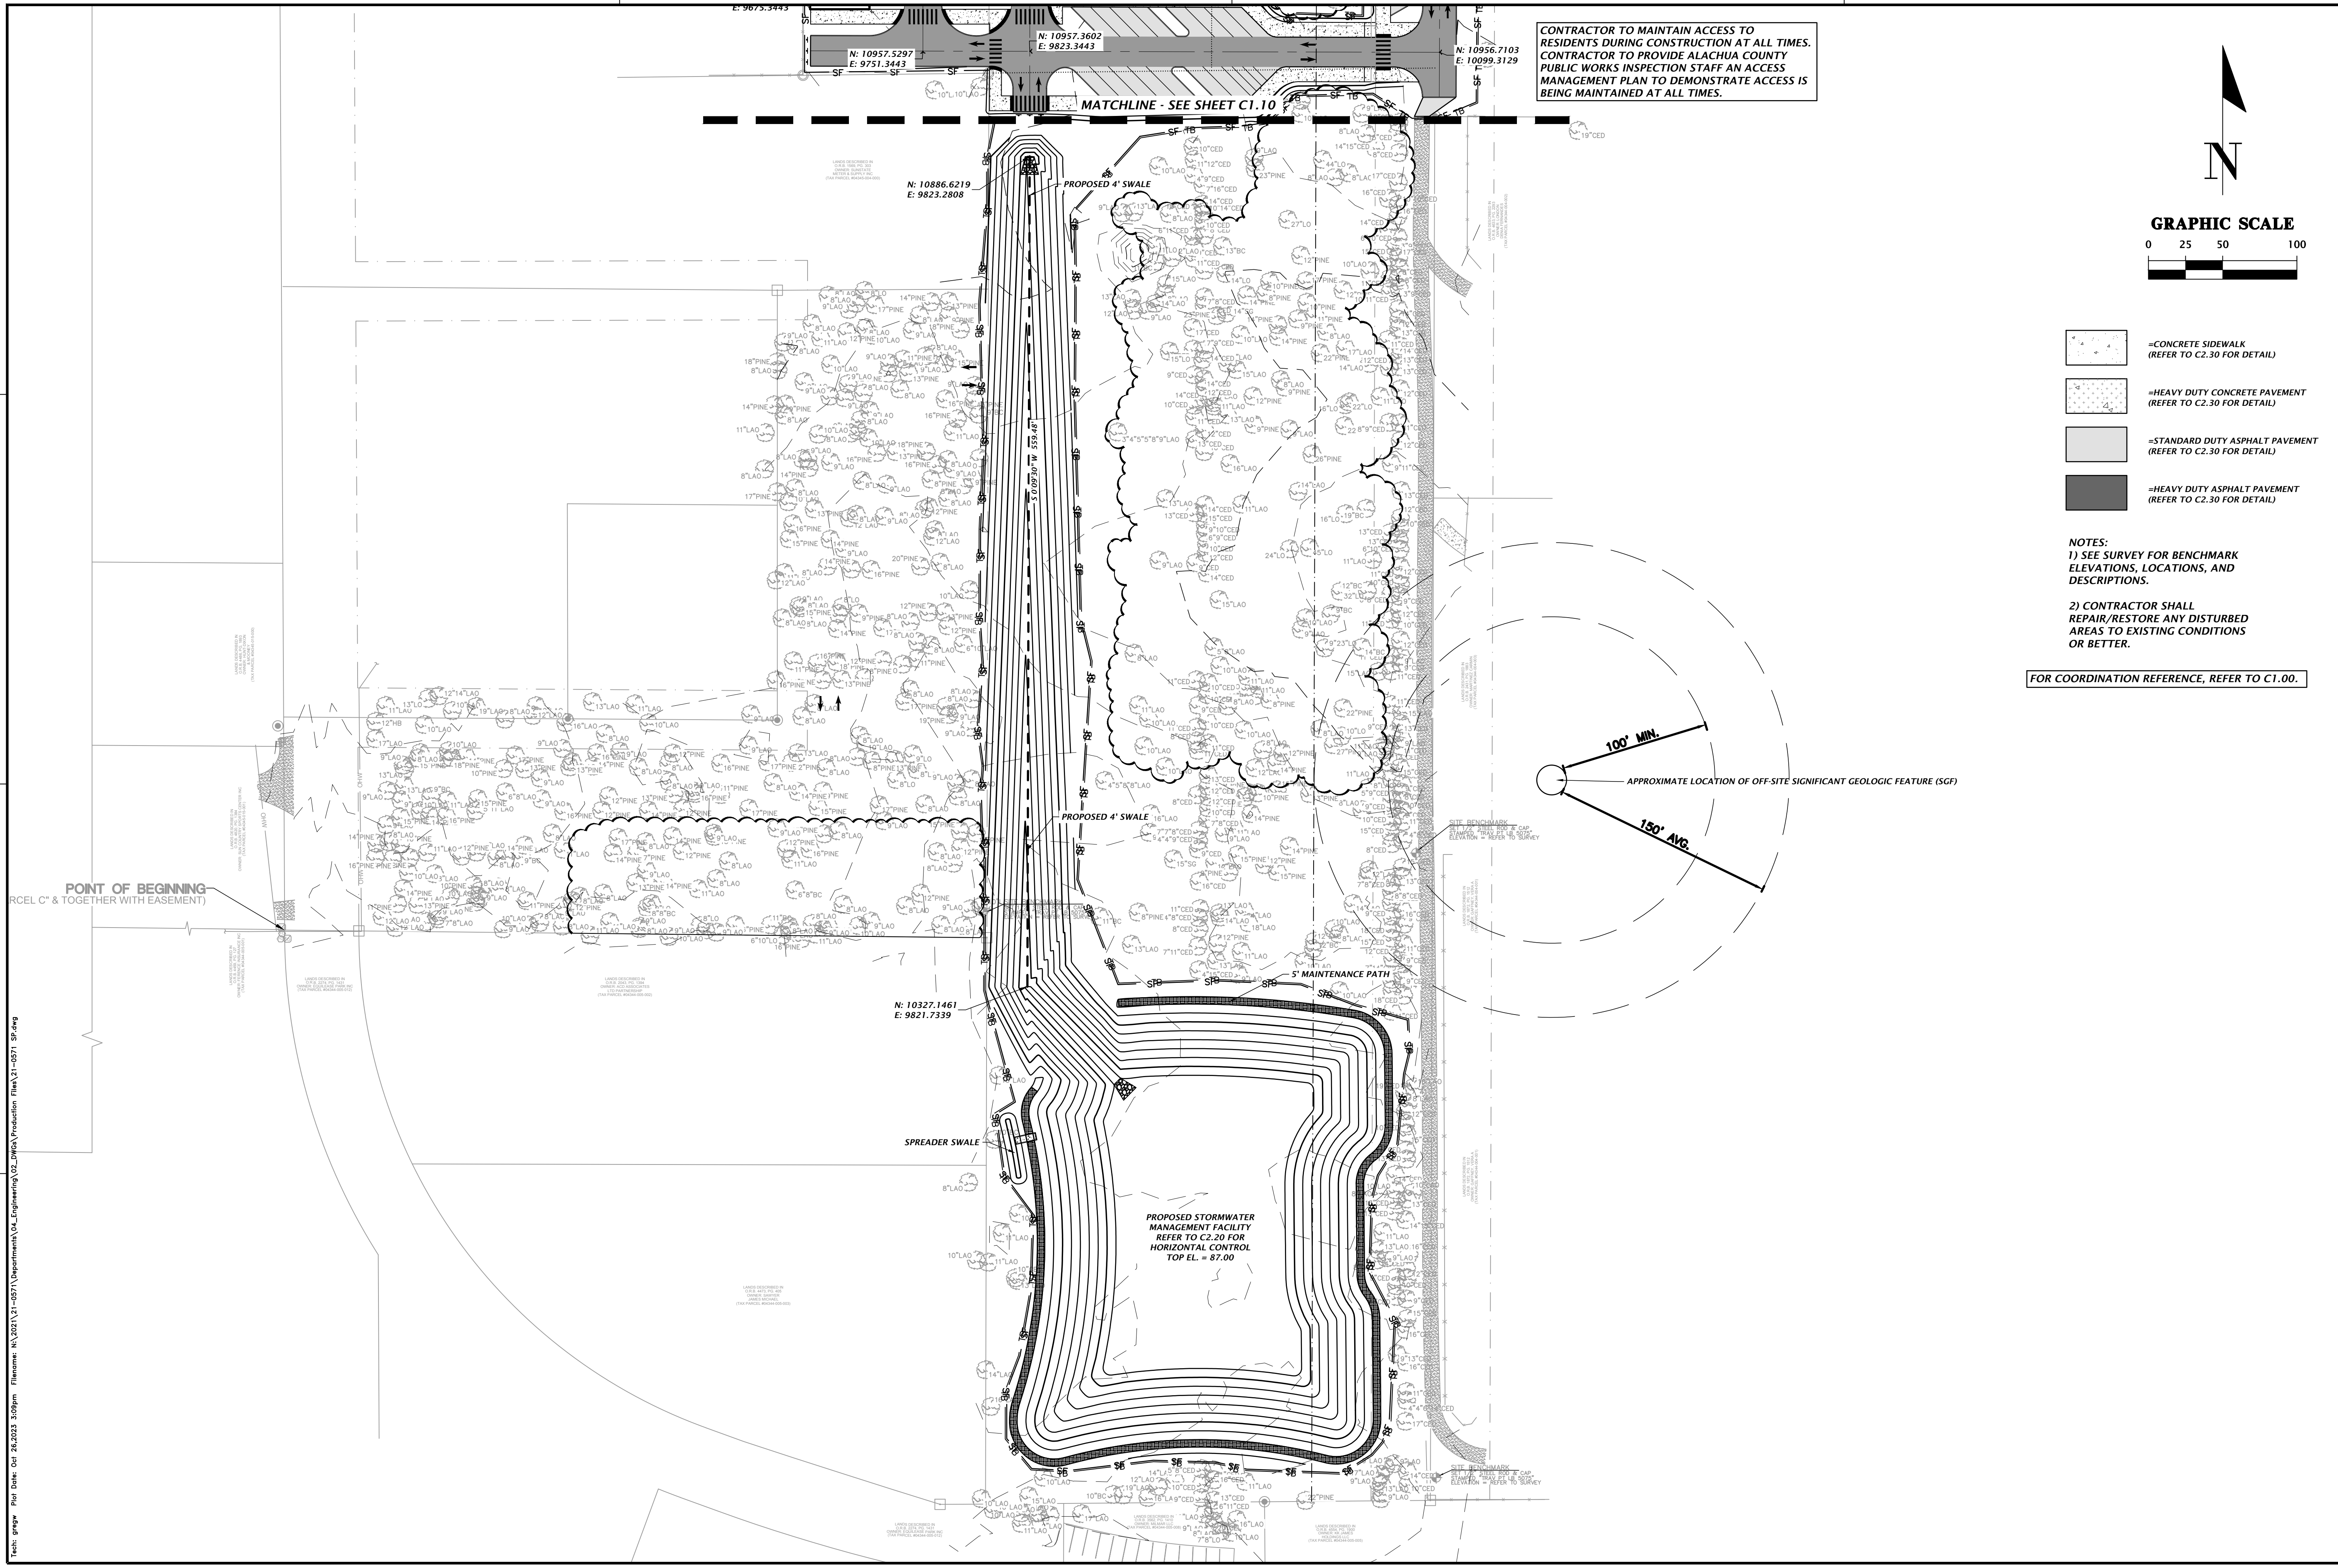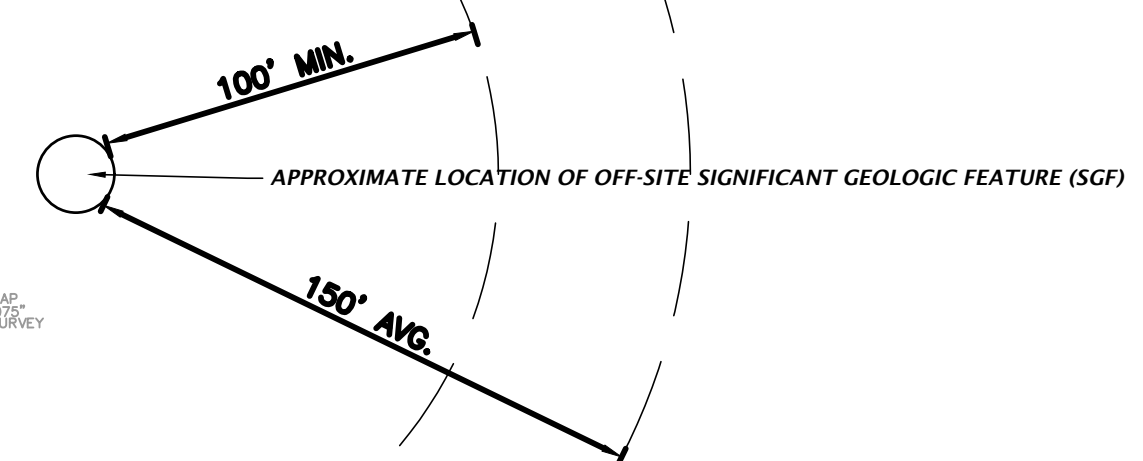

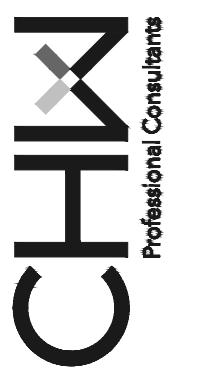	
11801 Research Drive Alachua, Florida 32615 (352) 351-1976 www.chwa-inc.com est. 1988 FLORIDA CA-5075	
SCALE: 1"=50' VERIFY SCALE BAR IS ONE INCH ON ORIGINAL DRAWING. IF NOT ONE INCH ON SCALES ACCORDINGLY.	SUBMITTALS: 6/5/23 - SUBMITTAL TO ALACHUA COUNTY, CRU, FOOT, AND SKWWD 7/31/23 - SUBMITTAL TO ALACHUA COUNTY, CRU, FOOT, AND SKWWD 10/10/23 - SUBMITTAL TO ALACHUA COUNTY 10/23/23 - BID SET
CLIENT: FLETCHER DEVELOPMENT	PROJECT: FLETCHER CENTER EAST SHEET TITLE: DETAILED HORIZONTAL CONTROL AND SITE PLAN
TECHNICIAN: G. WADZANSKI DESIGNER: G. LEDFORD, E.I. QUALITY CONTROL: D. YOUNG, P.E.	PROJECT NUMBER: 21-0571
Daniel H. Young, P.E. State of Florida, Professional Engineer, License No. 70780 This item has been digitally signed and sealed by Daniel H. Young, P.E., on the date indicated here: 10/26/2023 Printed copies of this document are not considered signed and sealed and the signature must be verified on any electronic copies.	
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1

2

3


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A

B


C

D

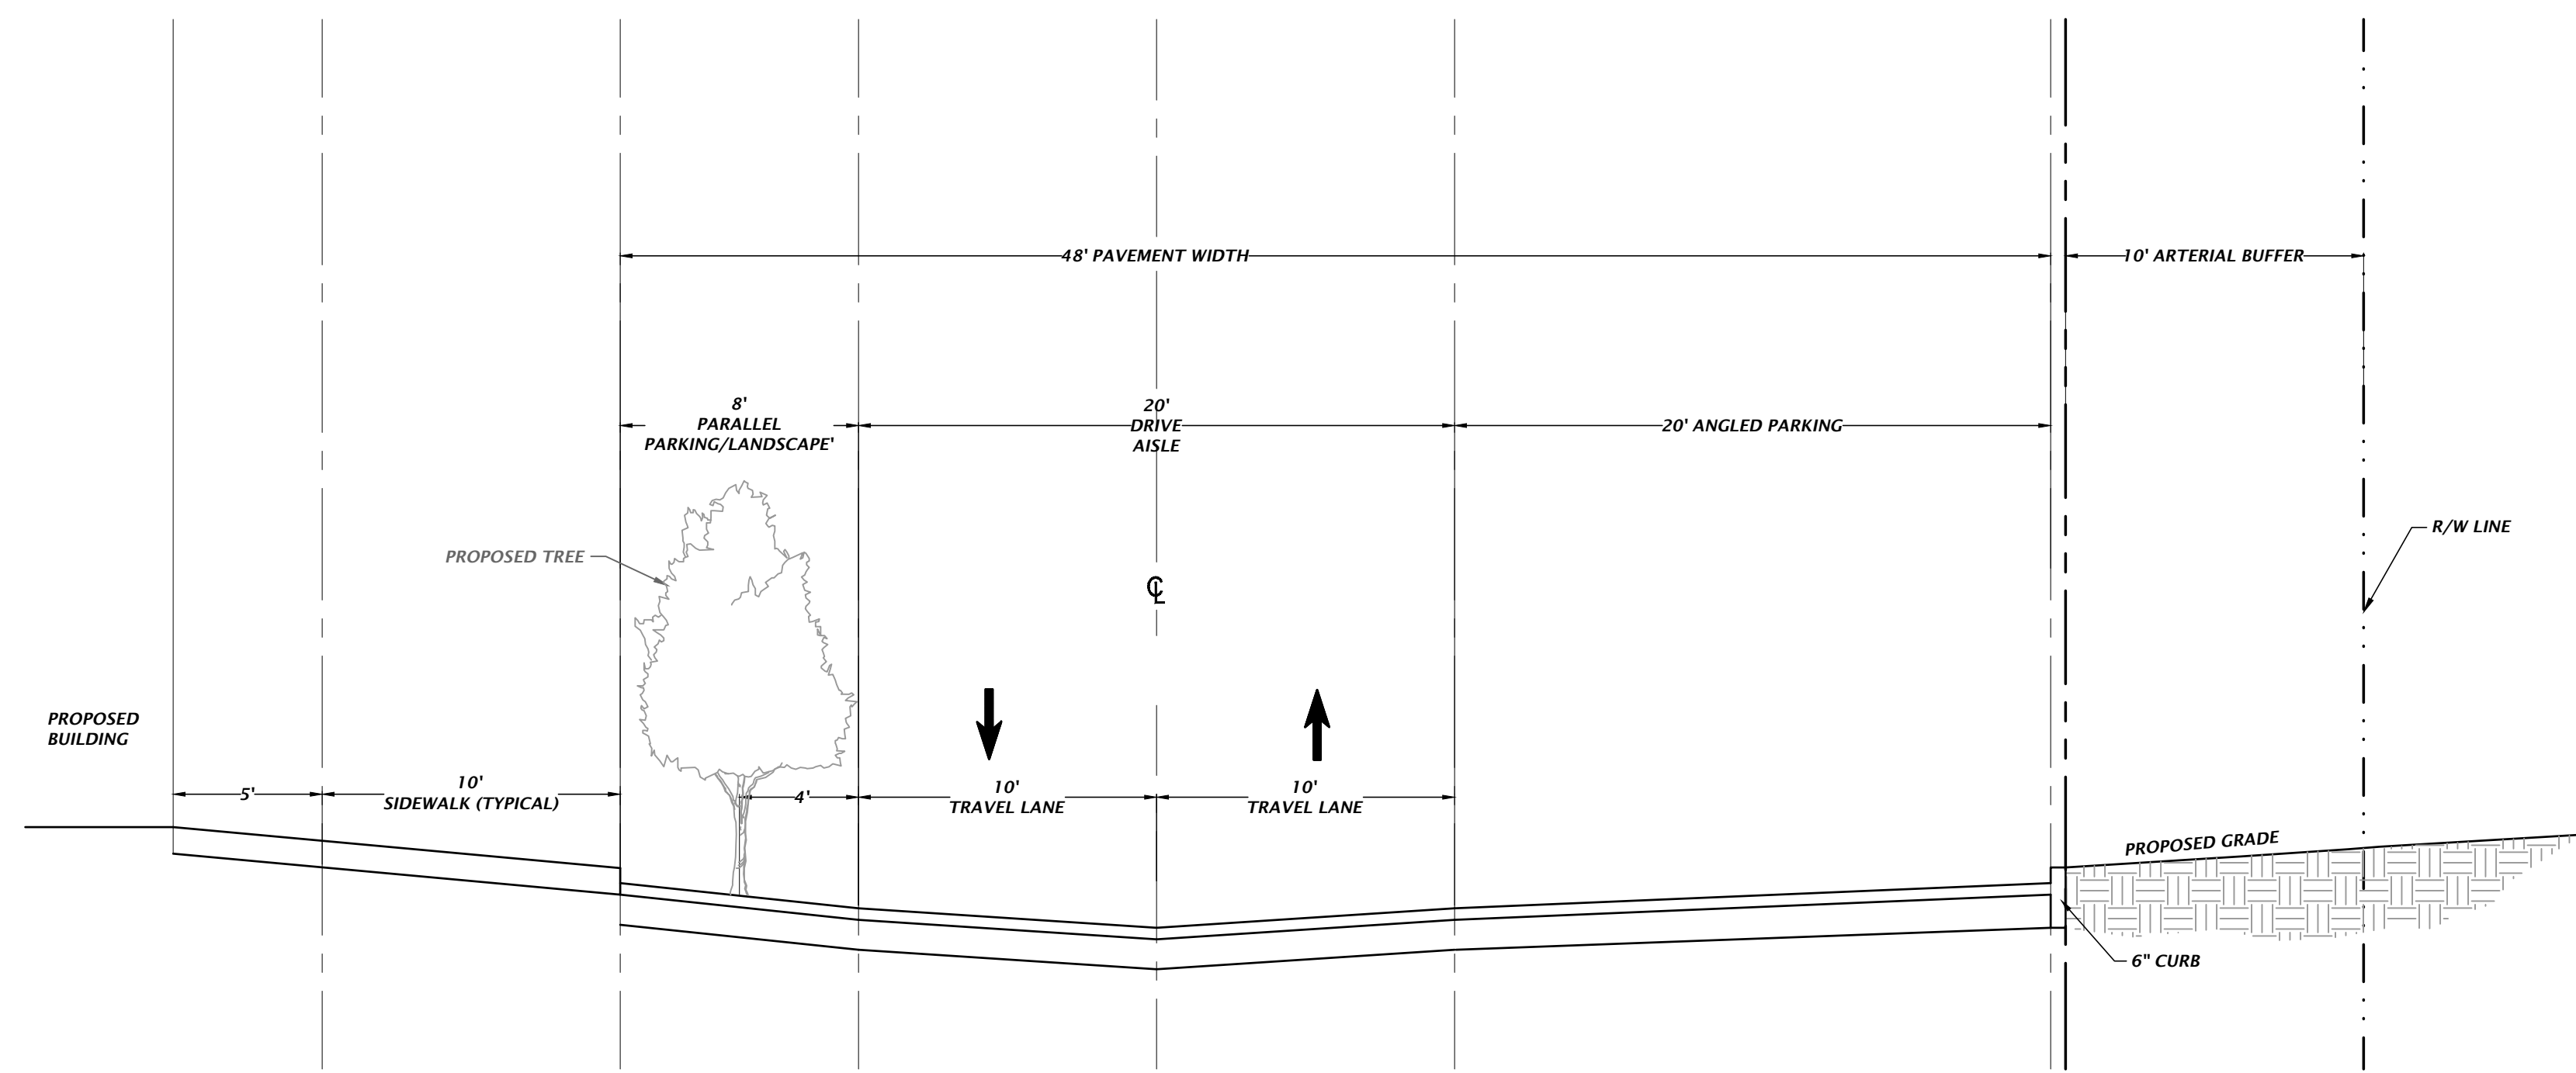

**TYPICAL ROADWAY  
CROSS SECTION A-A  
(NORTH ROAD)**

POSTED SPEED = 20 MPH  
NTS

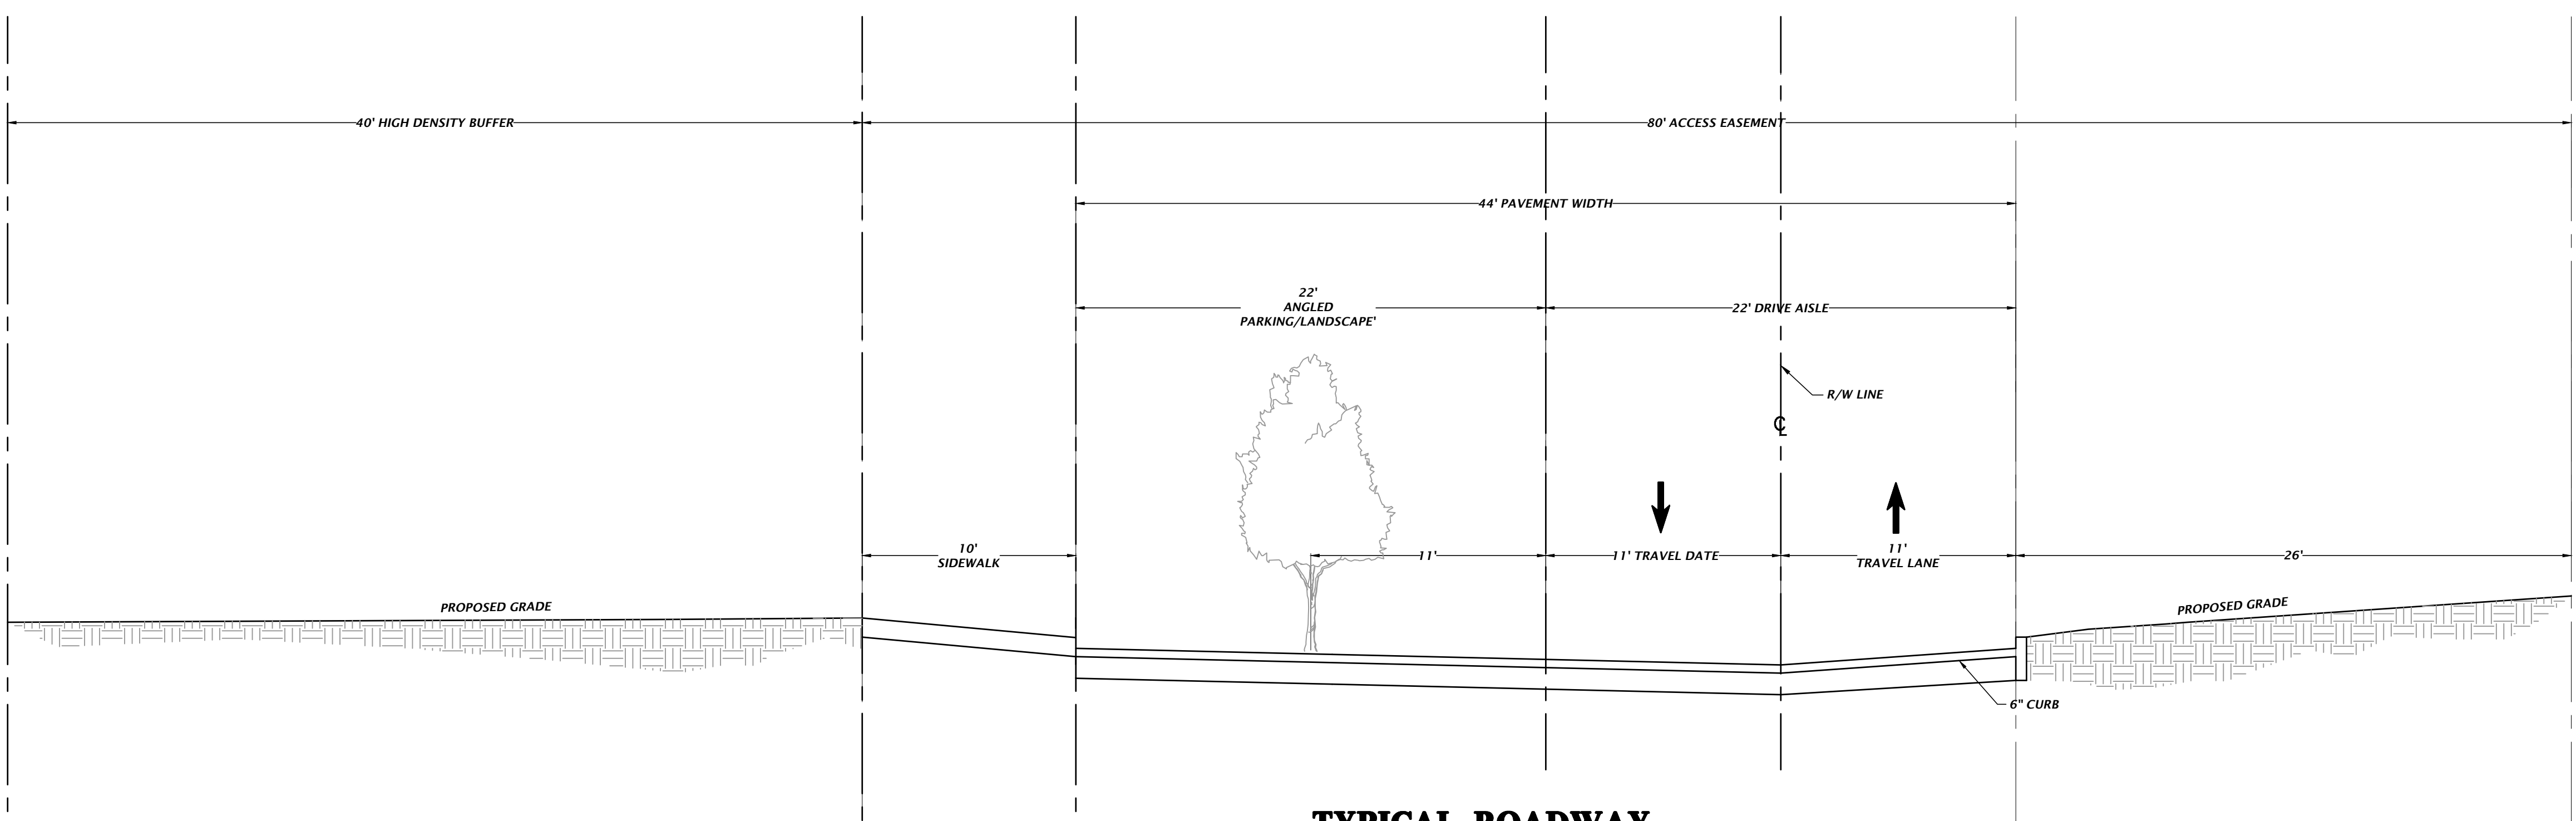


**TYPICAL ROADWAY  
CROSS SECTION B-B  
(EAST ROAD)**

POSTED SPEED = 20 MPH  
NTS

Text: greg For Date: Oct 23, 2023 4:58pm Filename: N:\2023\11-0571\Department\GA\_Engineering\GA\_DWG\Production\_Plan\21-0571\_SP.dwg

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<p>SCALE: 1"=20'</p> <p>VERIFY SCALE BAR IS ONE INCH ON DRAWING IF NOT ONE INCH ON SCALE, ACCORDINGLY.</p>	<p>CONSTRUCTION DIVISIONS</p>
<p>6/5/23 - SUBMITTAL TO ALACHUA COUNTY, CRU, FOOT, AND SRMWD 7/31/23 - SUBMITTAL TO ALACHUA COUNTY, CRU, FOOT, AND SRMWD 10/10/23 - SUBMITTAL TO CRU &amp; FOOT 10/23/23 - BID SET</p>	
<p>CLIENT: FLETCHER DEVELOPMENT</p>	<p>PROJECT: FLETCHER CENTER EAST</p>
<p>TECHNICIAN: G. WADZINSKI</p>	<p>DESIGNER: G. LEDWOLD, E.I.</p>
<p>QUALITY CONTROL: D. YOUNG, P.E.</p>	<p>PROJECT NUMBER: 21-0571</p>
<p>SHEET TITLE: ROADWAY TYPICAL SECTIONS</p>	
<p>Daniel H. Young, P.E. State of Florida, Professional Engineer, License No. 70780</p> <p>This item has been digitally signed and sealed by Daniel H. Young, P.E., on the date indicated here: 10/26/2023</p> <p>Printed copies of this document are not considered signed and sealed and the signature must be verified on any electronic copies.</p>	
<p>FL PE No. 70780</p> <p>SHEET NO. <b>C1.20</b></p>	




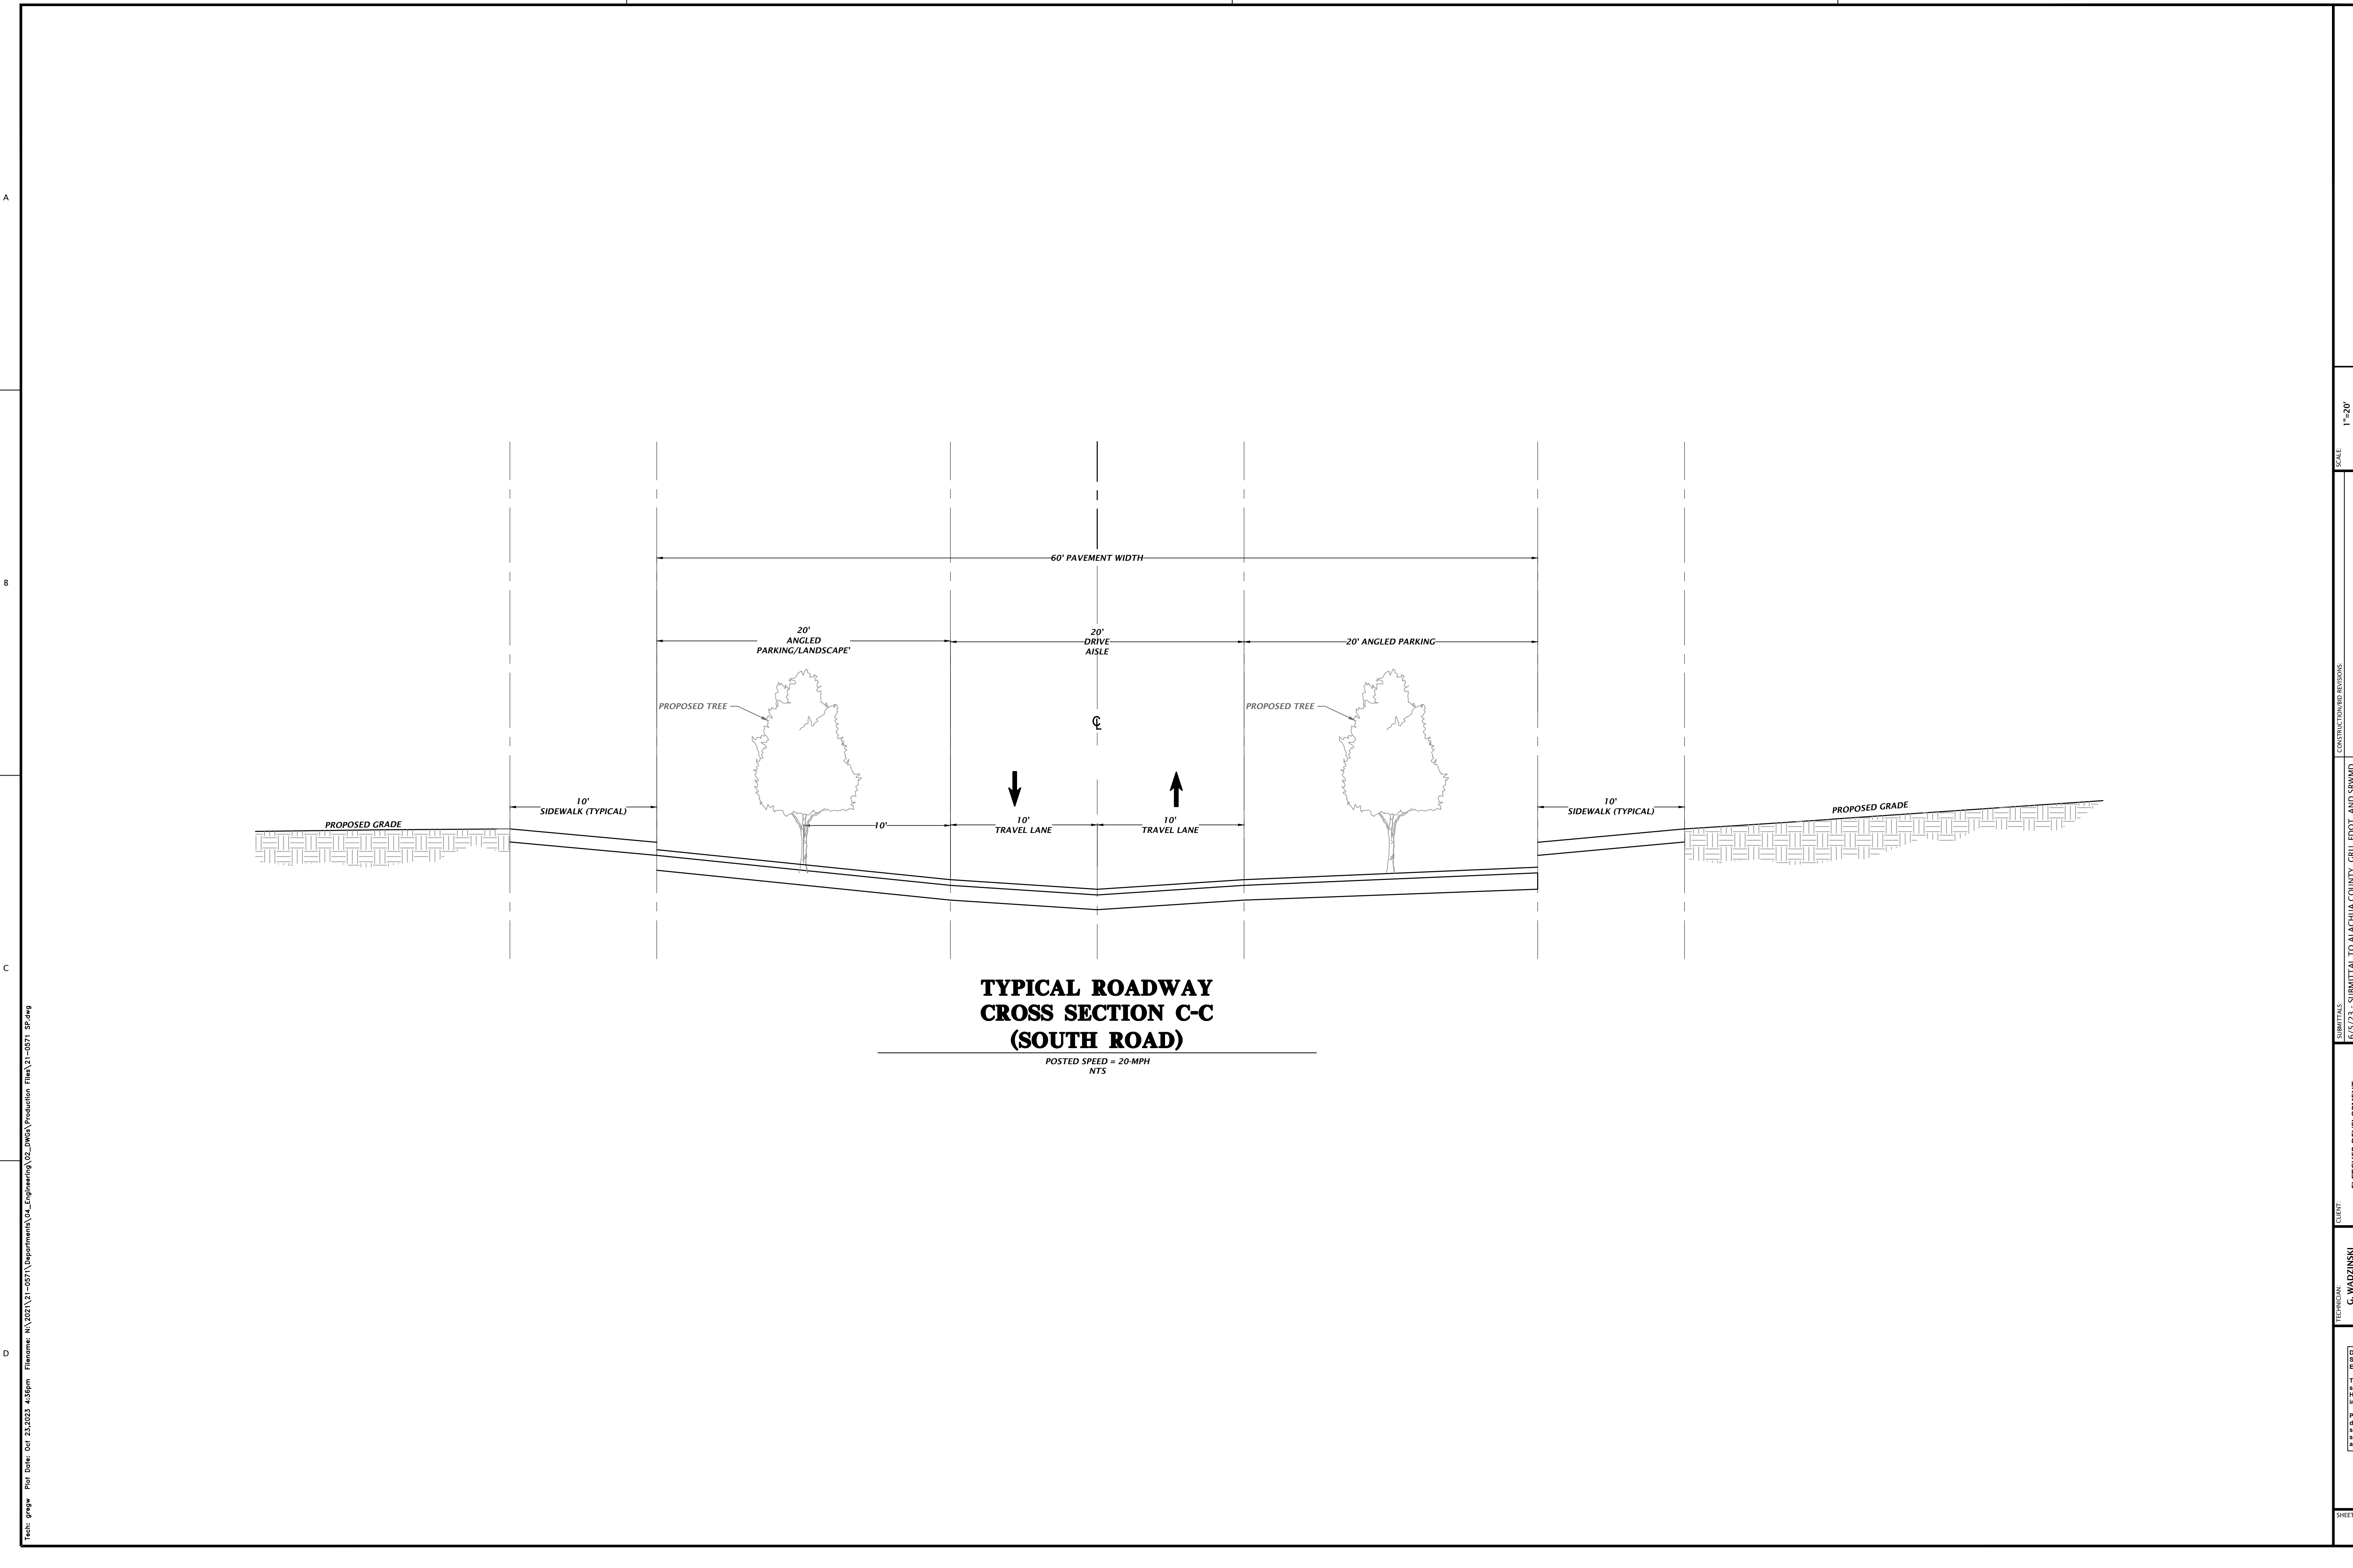


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<b>CHWA</b> Professional Consultants		11801 Research Drive Alachua, Florida 32615 (352) 351-1976 www.chw-inc.com est. 1988 <b>FLORIDA</b> CA-5075
SCALE: 1"=20' VERIFY SCALE 1"=20' IS ONE INCH ON DRAWING 0"=1" IS ONE INCH ON PRINT IF NOT ONE INCH ON PRINT, SCALES ACCORDINGLY.	SUBMITTALS: 6/5/23 - SUBMITTAL TO ALACHUA COUNTY, CRU, FOOT, AND SRWMD 7/31/23 - SUBMITTAL TO ALACHUA COUNTY, CRU, FOOT, AND SRWMD 10/10/23 - SUBMITTAL TO CRU & FOOT 10/23/23 - BID SET	
CLIENT: <b>G. WADZANSKI</b> DESIGNER: <b>C. LEDWOLD, E.I.</b> QUALITY CONTROL: <b>D. YOUNG, P.E.</b>	PROJECT: <b>FLETCHER DEVELOPMENT</b> <b>FLETCHER CENTER EAST</b>	SHEET TITLE: <b>ROADWAY TYPICAL SECTIONS</b> PROJECT NUMBER: <b>21-0571</b>
DESIGNER'S SEAL AND SIGNATURE: Daniel H. Young, P.E. State of Florida, Professional Engineer, License No. 70780 This item has been digitally signed and sealed by Daniel H. Young, P.E., on the date indicated here: 10/20/23 Printed copies of this document are not considered signed and sealed and the signature must be verified on any electronic copies.		
FL PE No. 70780 <b>C1.21</b>		

A  
B  
C  
D

Text: gmpg For Date: Oct 23, 2023 4:58pm Filename: N:\2023\11-0071\Department\GA\_Engineering\02\_DWG\Production\Fla\21-0571\_P04.dwg

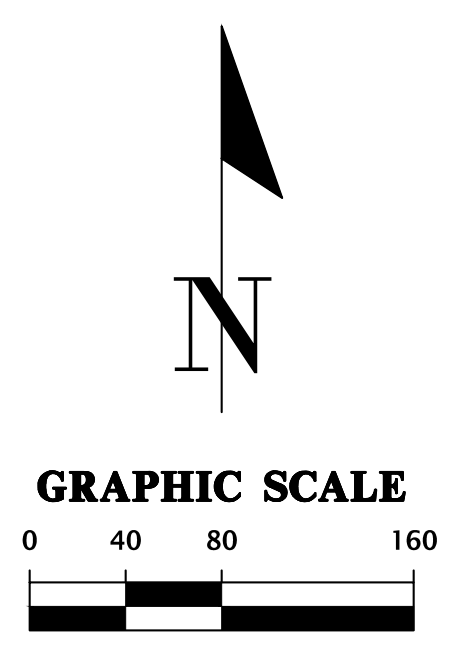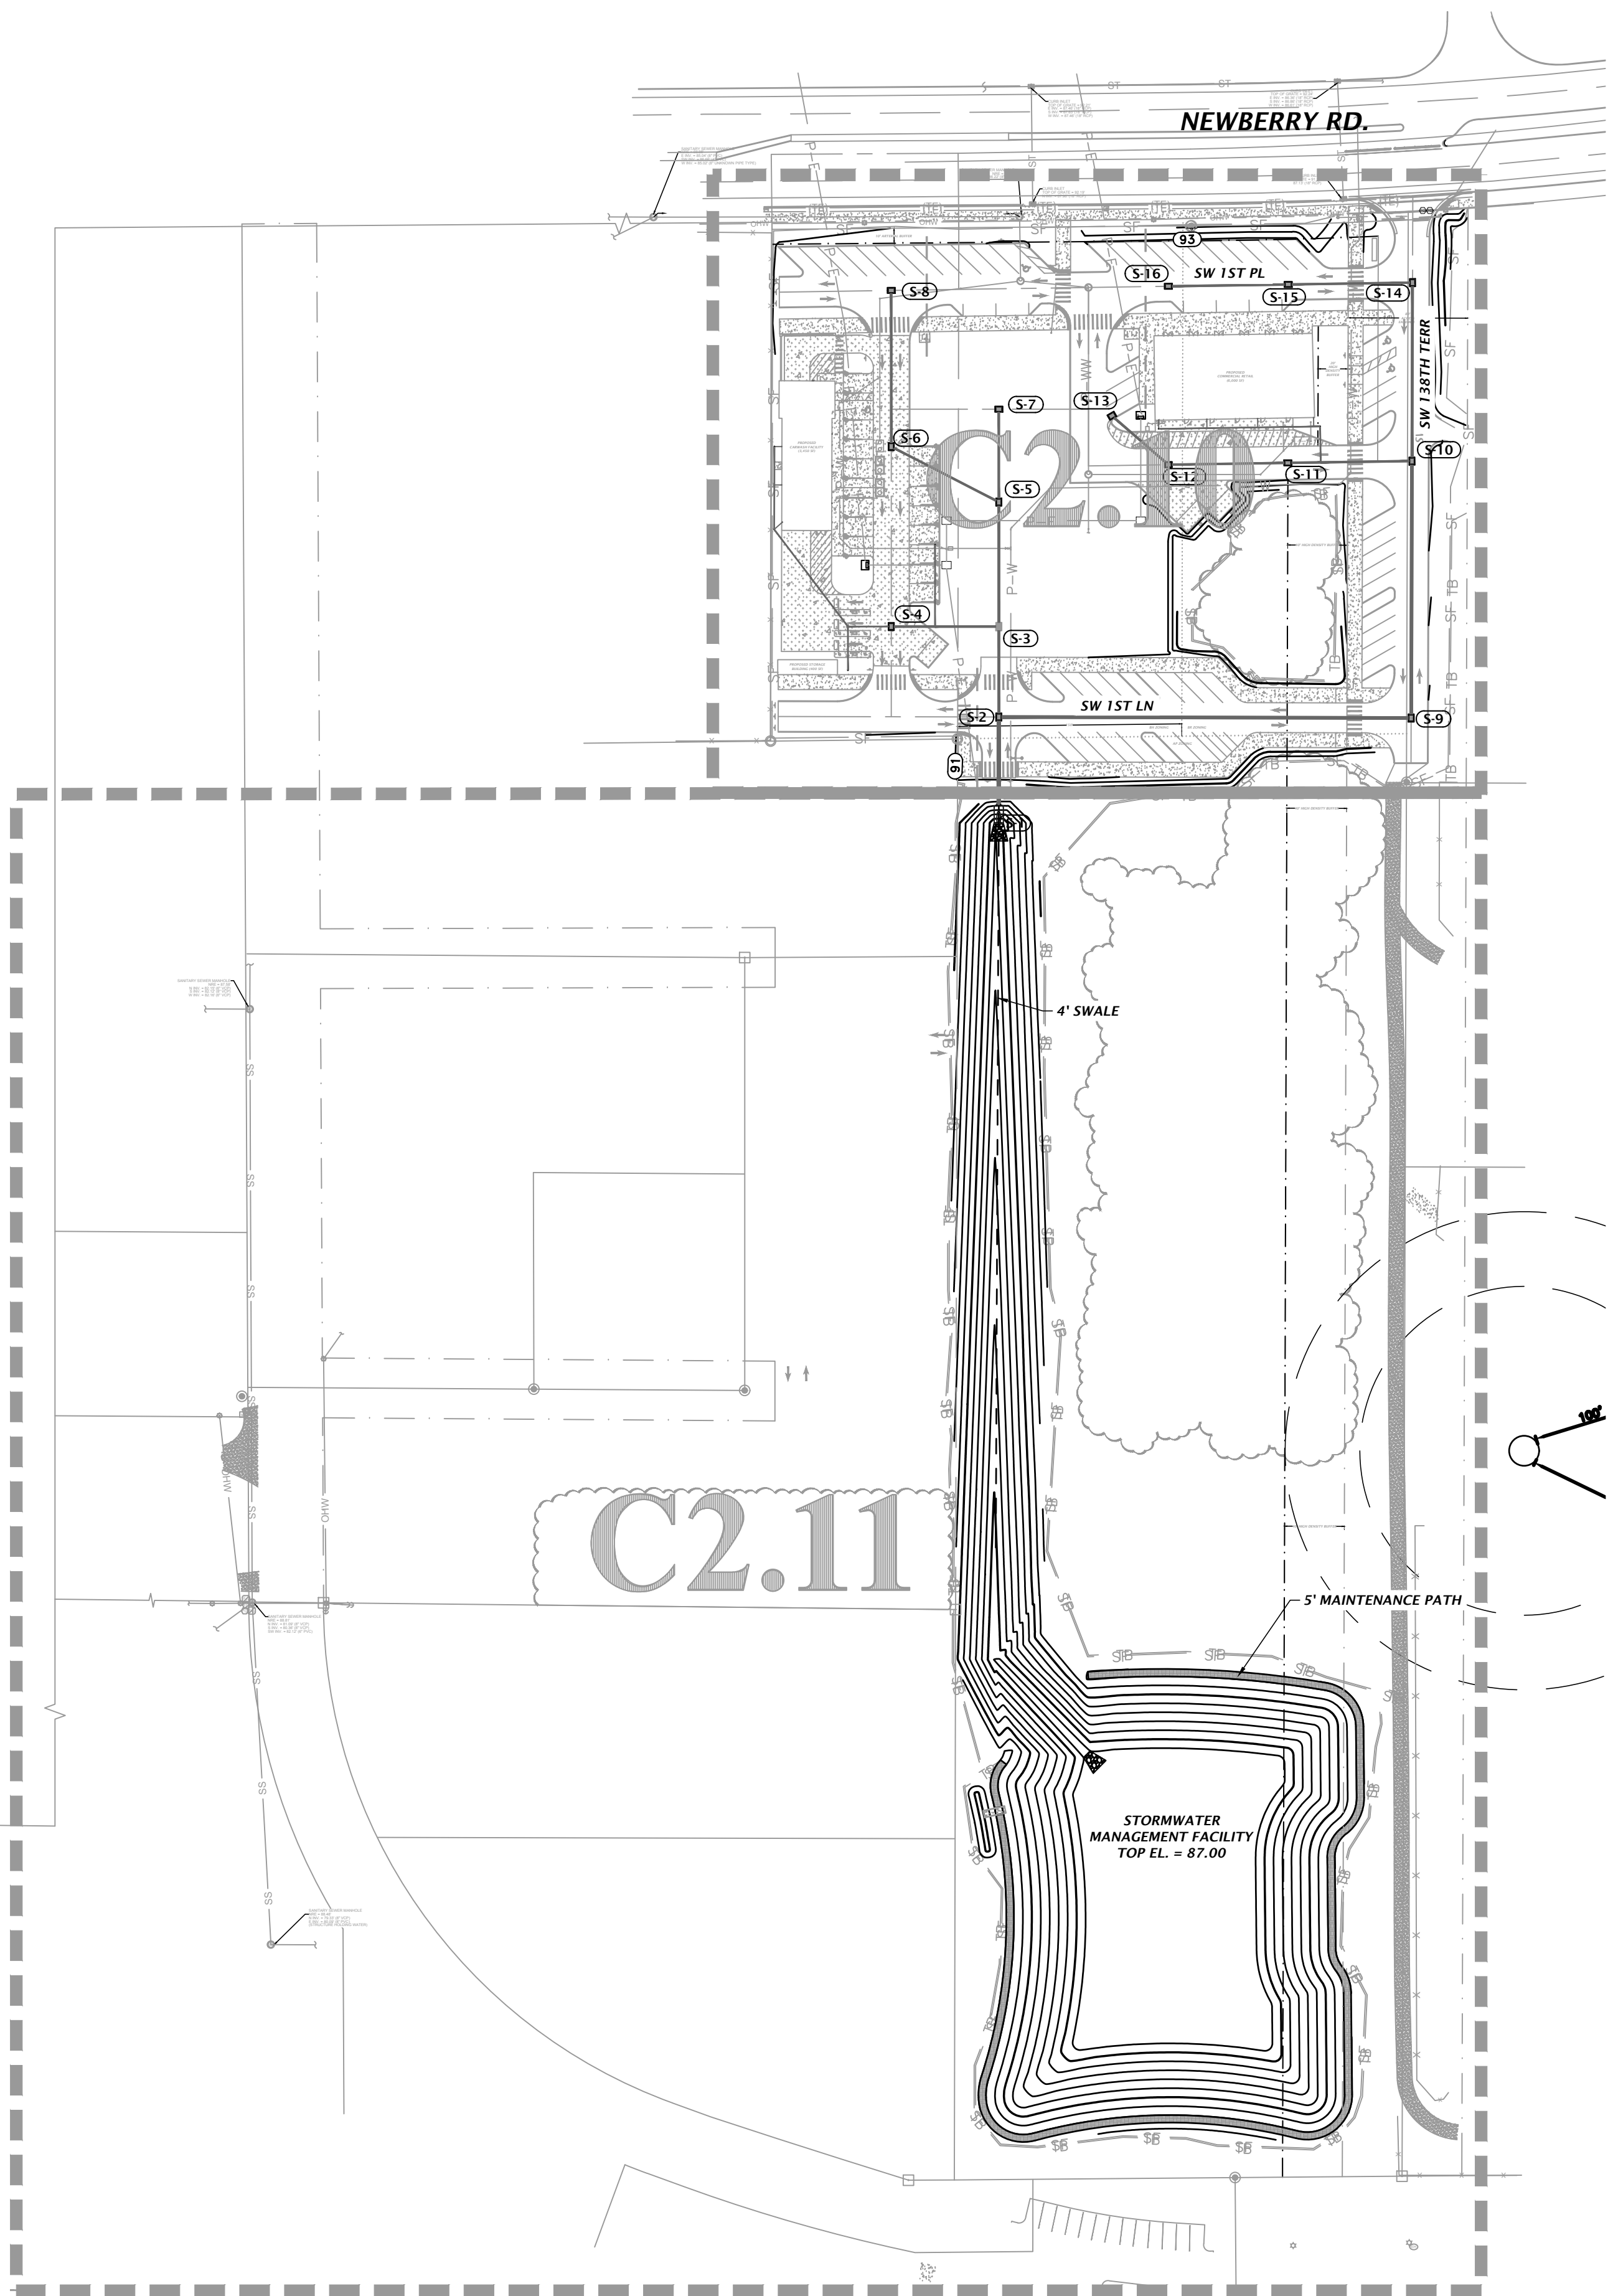

STORMWATER STRUCTURE TABLE					
STRUCTURE:	STRUCTURE TYPE	TOP	INVERT ELEV	PIPE DIA.	NORTHING & EASTING
S-1	CROSS DRAIN MES PER FDOT INDEX 430-021	N/A	84.00 N	30"	N: 10886.42 E: 9823.29
S-2	TYPE F INLET WITH TYPE J ALTA BOTTOM PER FDOT INDEX 425-053 AND 425-010	91.04	84.14 N 84.14 S 84.14 E	18" 30" 24"	N: 10957.36 E: 9823.34
S-3	TYPE F INLET PER FDOT INDEX 425-053 AND 425-010	91.93	85.82 N 85.82 S 85.82 W	18" 18" 15"	N: 11017.87 E: 9823.34
S-4	TYPE F INLET PER FDOT INDEX 425-053 AND 425-010	91.67	88.00 E 88.00 W	15" 8"	N: 11017.87 E: 9751.34
S-5	TYPE F INLET PER FDOT INDEX 425-053 AND 425-010	92.23	86.23 N 86.24 S 86.24 NW	15" 18" 15"	N: 11101.14 E: 9823.34
S-6	TYPE F INLET PER FDOT INDEX 425-053 AND 425-010	91.80	86.64 SE 86.64 N	15" 15"	N: 11138.31 E: 9751.34
S-7	TYPE F INLET PER FDOT INDEX 425-053 AND 425-010	92.80	86.55 S	15"	N: 11163.31 E: 9823.34
S-8	TYPE F INLET PER FDOT INDEX 425-053 AND 425-010	91.13	87.00 S	15"	N: 11242.76 E: 9751.34
S-9	TYPE F INLET WITH TYPE J ALTA BOTTOM PER FDOT INDEX 425-053 AND 425-010	89.15	84.69 N 84.69 W	24" 24"	N: 10956.71 E: 10099.31
S-10	TYPE F INLET WITH TYPE J ALTA BOTTOM PER FDOT INDEX 425-053 AND 425-010	91.67	86.58 N 86.58 S 86.58 W	18" 24" 15"	N: 11128.59 E: 10099.85
S-11	TYPE F INLET PER FDOT INDEX 425-053 AND 425-010	92.39	87.00 W 87.00 E	15" 15"	N: 11127.39 E: 10016.79
S-12	TYPE F INLET PER FDOT INDEX 425-053 AND 425-010	92.39	87.40 E 87.40 NW	15" 15"	N: 11126.18 E: 9936.72
S-13	TYPE F INLET PER FDOT INDEX 425-053 AND 425-010	91.83	87.65 SE	15"	N: 11158.94 E: 9899.01
S-14	TYPE F INLET PER FDOT INDEX 425-053 AND 425-010	91.67	87.18 W 87.18 S	15" 18"	N: 11247.98 E: 10100.23
S-15	TYPE F INLET PER FDOT INDEX 425-053 AND 425-010	91.83	87.59 W 87.60 E	15" 15"	N: 11246.78 E: 10017.02
S-16	TYPE F INLET PER FDOT INDEX 425-053 AND 425-010	91.56	88.00 E	15"	N: 11245.56 E: 9936.82

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6/5/23 - SUBMITTAL TO ALACHUA COUNTY, CRU, FDOT, AND SRWMD  
7/31/23 - SUBMITTAL TO ALACHUA COUNTY, CRU, FDOT, AND SRWMD  
10/10/23 - SUBMITTAL TO ALACHUA COUNTY  
10/23/23 - BID SET



CLIENT: FLETCHER DEVELOPMENT  
PROJECT: FLETCHER CENTER EAST  
SHEET TITLE: MASTER PAVING, GRADING, AND DRAINAGE PLAN

TECHNICIAN: G. WADZINSKI  
DESIGNER: G. LEDWOLD, E.I.  
QUALITY CONTROL: D. YOUNG, P.E.  
PROJECT NUMBER: 21-0571

DANIEL H. YOUNG  
Daniel H. Young, P.E.  
State of Florida, Professional  
Engineer, License No. 70780  
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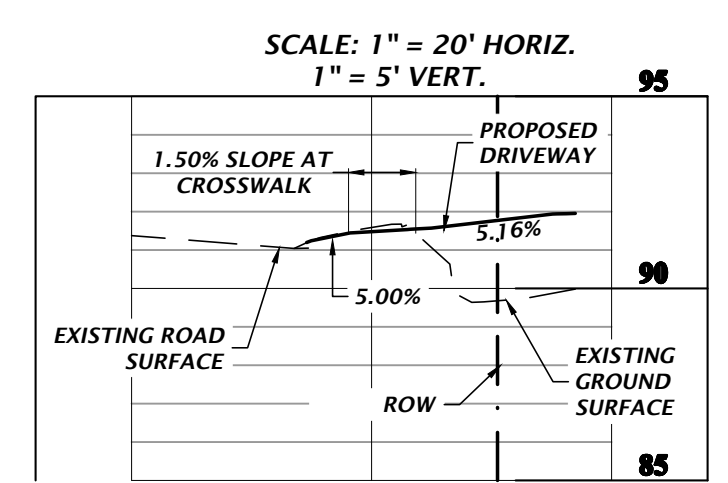
FL PE No. 70780  
SHEET NO. **C2.00**



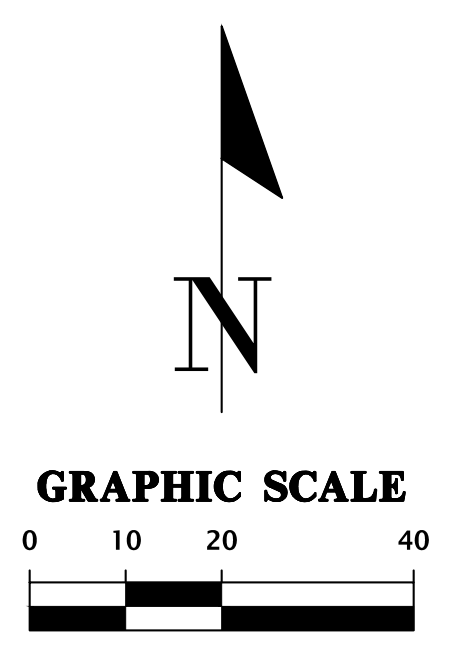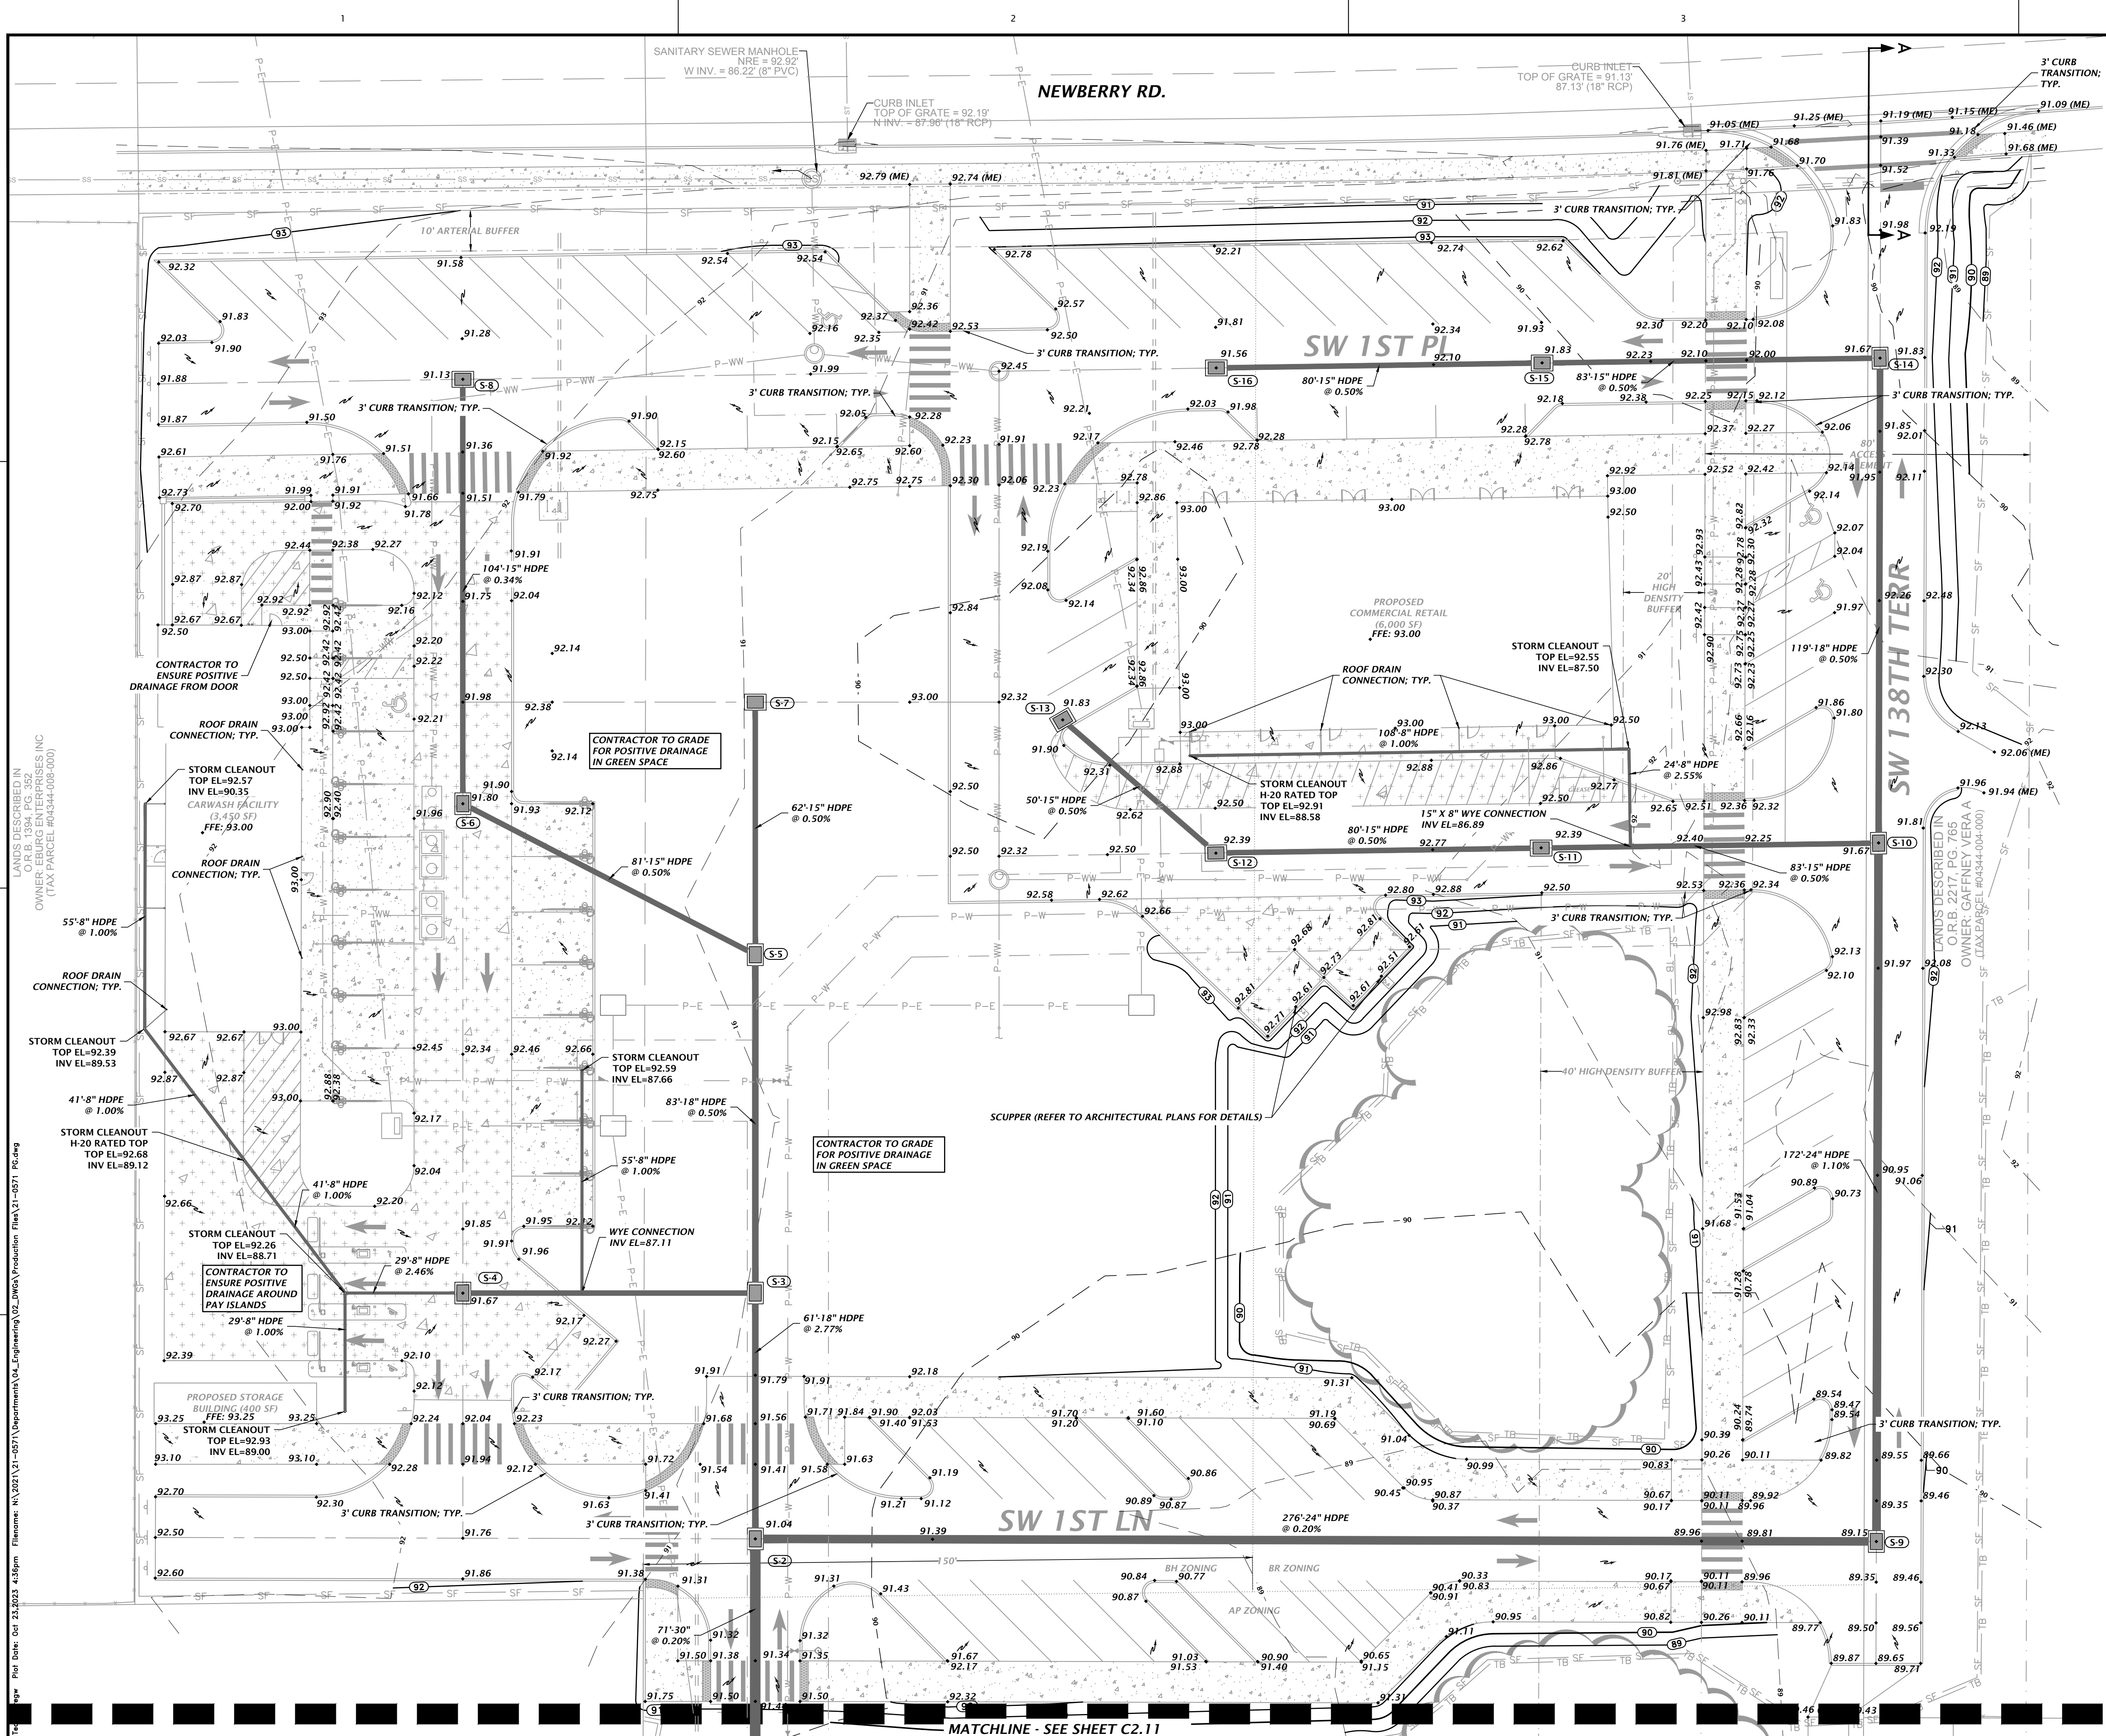

NOTE: ALL PIPE CONNECTIONS TO BE MADE WITH A WYE CONNECTION. PIPES SHOWN FOR SCHEMATIC PURPOSES ONLY.

STRUCTURE	STRUCTURE TYPE	TOP	INVERT ELEV	PIPE DIA.	NORTHING & EASTING
S-1	CROSS DRAIN MES PER FDOT INDEX 430-021	N/A	84.00 N	30"	N: 10886.42 E: 9823.29
S-2	TYPE F INLET WITH TYPE J ALT A BOTTOM PER FDOT INDEX 425-053 AND 425-010	91.04	84.14 N 84.14 S	18" 30" 24"	N: 10957.36 E: 9823.34
S-3	TYPE F INLET PER FDOT INDEX 425-053 AND 425-010	91.93	85.82 N 85.82 S	18" 15"	N: 11017.87 E: 9823.34
S-4	TYPE F INLET PER FDOT INDEX 425-053 AND 425-010	91.67	88.00 E 88.00 W	15" 8"	N: 11017.87 E: 9751.34
S-5	TYPE F INLET PER FDOT INDEX 425-053 AND 425-010	92.23	86.23 N 86.24 S	15" 18"	N: 11101.14 E: 9823.34
S-6	TYPE F INLET PER FDOT INDEX 425-053 AND 425-010	91.80	86.64 SE 86.64 N	15" 15"	N: 11138.31 E: 9751.34
S-7	TYPE F INLET PER FDOT INDEX 425-053 AND 425-010	92.80	86.55 S	15"	N: 11163.31 E: 9823.34
S-8	TYPE F INLET PER FDOT INDEX 425-053 AND 425-010	91.13	87.00 S	15"	N: 11242.76 E: 9751.34
S-9	TYPE F INLET WITH TYPE J ALT A BOTTOM PER FDOT INDEX 425-053 AND 425-010	89.15	84.69 N 84.69 W	24" 24"	N: 10956.71 E: 10099.31
S-10	TYPE F INLET WITH TYPE J ALT A BOTTOM PER FDOT INDEX 425-053 AND 425-010	91.67	86.58 N 86.58 W	18" 24" 15"	N: 11128.59 E: 10099.85
S-11	TYPE F INLET PER FDOT INDEX 425-053 AND 425-010	92.39	87.00 W 87.00 E	15" 15"	N: 11127.39 E: 10016.79
S-12	TYPE F INLET PER FDOT INDEX 425-053 AND 425-010	92.39	87.40 E 87.40 NW	15" 15"	N: 11126.18 E: 9936.72
S-13	TYPE F INLET PER FDOT INDEX 425-053 AND 425-010	91.83	87.65 SE	15"	N: 11158.94 E: 9899.01
S-14	TYPE F INLET PER FDOT INDEX 425-053 AND 425-010	91.67	87.18 W 87.18 S	15" 18"	N: 11247.98 E: 10100.23
S-15	TYPE F INLET PER FDOT INDEX 425-053 AND 425-010	91.83	87.59 W 87.60 E	15" 15"	N: 11246.78 E: 10017.02
S-16	TYPE F INLET PER FDOT INDEX 425-053 AND 425-010	91.56	88.00 E	15"	N: 11245.56 E: 9936.82



SECTION A-A  
DRIVEWAY PROFILE

LANDS DESCRIBED IN O.R.B. 2217, PG. 765  
 OWNER: GAFNEY/VERA  
 (TAX PARCEL #04344-008-000)  
 F:\2024\21-0571\Department\02\_DWG\Production\Fla\21-0571\_P2.dwg  
 Date: Oct 24, 2023 4:58pm  
 Plot Date: Oct 24, 2023 4:58pm

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CONSTRUCTION DIVISION


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7/31/23 - SUBMITTAL TO ALACHUA COUNTY, CRU, FOOT, AND SWMD  
10/10/23 - SUBMITTAL TO CRU & FDOT  
10/23/23 - BID SET

CLIENT: FLETCHER DEVELOPMENT  
PROJECT: FLETCHER CENTER EAST  
SHEET TITLE: DETAILED PAVING, GRADING, AND DRAINAGE PLAN  
SHEET NUMBER: 21-0571

TECHNICAL: G. WADZANSKI  
DESIGNER: C. LEDFORD, E.I.  
QUALITY CONTROL: D. YOUNG, P.E.  
PROJECT NUMBER: 21-0571

DANIEL H. YOUNG  
Daniel H. Young, P.E.  
State of Florida, Professional Engineer, License No. 70780  
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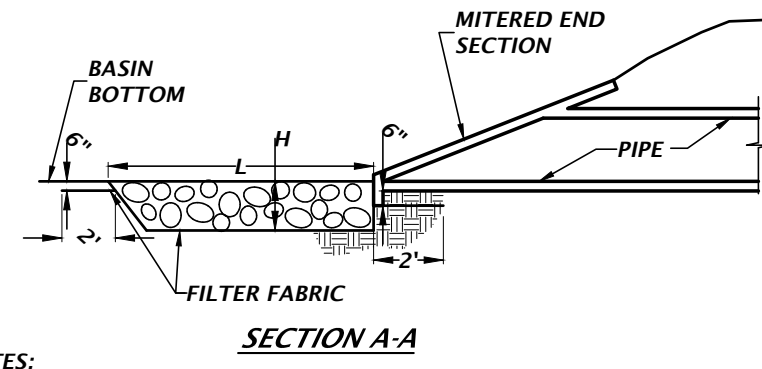
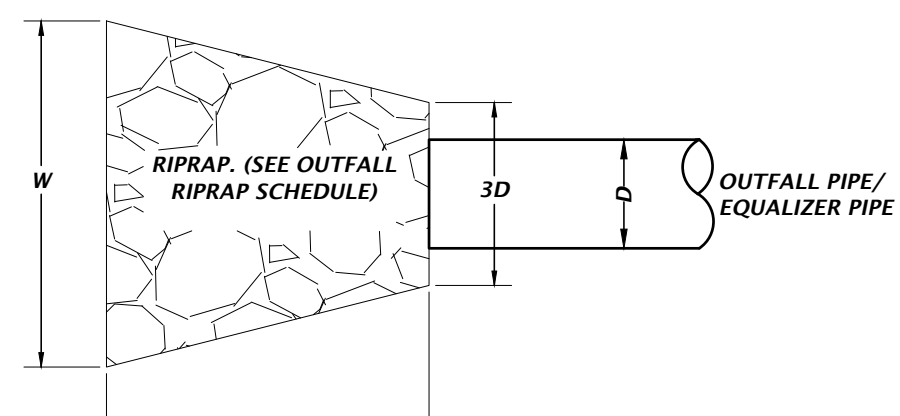
FL PE No. 70780  
SHEET NO.: **C2.10**

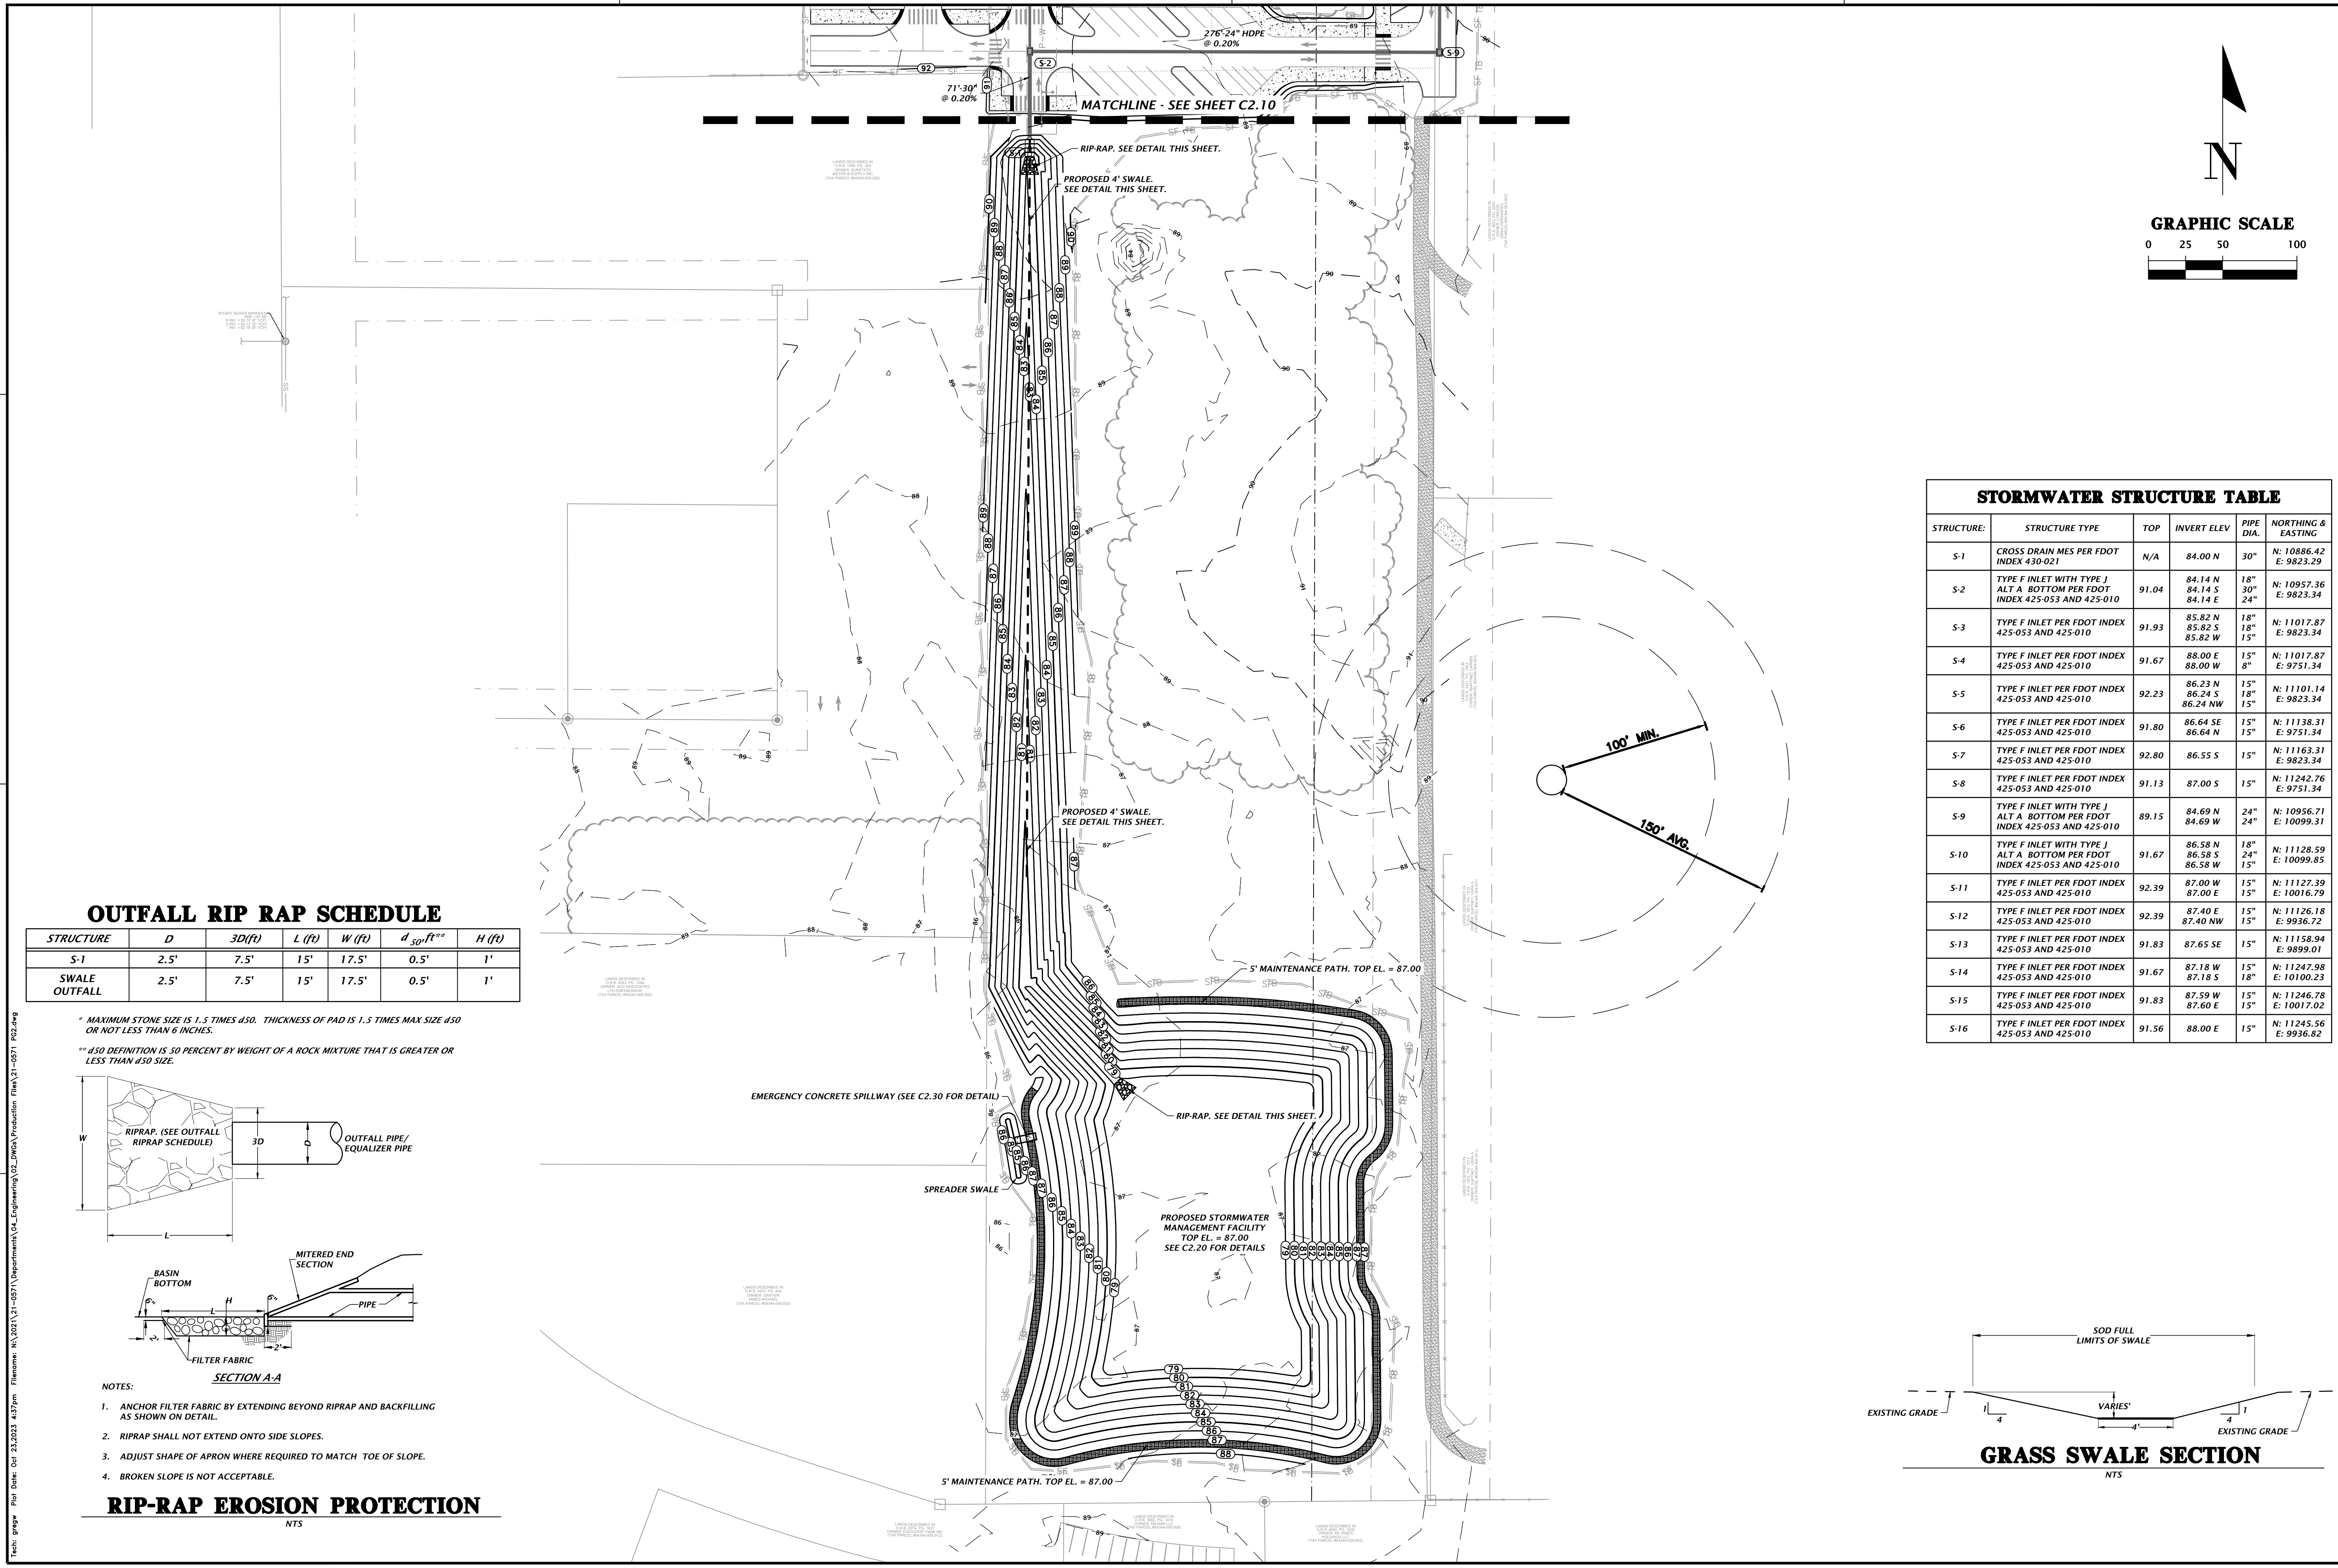

**OUTFALL RIP RAP SCHEDULE**

STRUCTURE	D	3D(F)	L (F)	W (F)	$d_{50}$ (F) <sup>1,2</sup>	H (F)
S-1	2.5'	7.5'	15'	17.5'	0.5'	1'
SWALE OUTFALL	2.5'	7.5'	15'	17.5'	0.5'	1'

<sup>1</sup> MAXIMUM STONE SIZE IS 1.5 TIMES  $d_{50}$ . THICKNESS OF PAD IS 1.5 TIMES MAX SIZE  $d_{50}$  OR NOT LESS THAN 6 INCHES.  
<sup>2</sup>  $d_{50}$  DEFINITION IS 50 PERCENT BY WEIGHT OF A ROCK MIXTURE THAT IS GREATER OR LESS THAN  $d_{50}$  SIZE.




- NOTES:
- ANCHOR FILTER FABRIC BY EXTENDING BEYOND RIPRAP AND BACKFILLING AS SHOWN ON DETAIL.
  - RIPRAP SHALL NOT EXTEND ONTO SIDE SLOPES.
  - ADJUST SHAPE OF APRON WHERE REQUIRED TO MATCH TOE OF SLOPE.
  - BROKEN SLOPE IS NOT ACCEPTABLE.

**RIP-RAP EROSION PROTECTION**  
NTS

**STORMWATER STRUCTURE TABLE**

STRUCTURE	STRUCTURE TYPE	TOP	INVERT ELEV	PIPE DIA.	NORTHING & EASTING
S-1	CROSS DRAIN MES PER FDOT INDEX 430-021	N/A	84.00 N	30"	N: 10886.42 E: 9823.29
S-2	TYPE F INLET WITH TYPE J ALT A BOTTOM PER FDOT INDEX 425-053 AND 425-010	91.04	84.14 N 84.14 S 84.14 E	18" 30" 24"	N: 10957.36 E: 9823.34
S-3	TYPE F INLET PER FDOT INDEX 425-053 AND 425-010	91.93	85.82 N 85.82 S 85.82 W	18" 30" 15"	N: 11017.87 E: 9823.34
S-4	TYPE F INLET PER FDOT INDEX 425-053 AND 425-010	91.67	88.00 E 88.00 W	15" 8"	N: 11017.87 E: 9751.34
S-5	TYPE F INLET PER FDOT INDEX 425-053 AND 425-010	92.23	86.23 N 86.24 S 86.24 NW	15" 18" 15"	N: 11101.14 E: 9823.34
S-6	TYPE F INLET PER FDOT INDEX 425-053 AND 425-010	91.80	86.64 SE 86.64 N	15" 15"	N: 11138.31 E: 9751.34
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S-13	TYPE F INLET PER FDOT INDEX 425-053 AND 425-010	91.83	87.65 SE	15"	N: 11158.94 E: 9899.01
S-14	TYPE F INLET PER FDOT INDEX 425-053 AND 425-010	91.67	87.18 W 87.18 S	15" 18"	N: 11247.98 E: 10100.23
S-15	TYPE F INLET PER FDOT INDEX 425-053 AND 425-010	91.83	87.59 W 87.60 E	15" 15"	N: 11246.78 E: 10017.02
S-16	TYPE F INLET PER FDOT INDEX 425-053 AND 425-010	91.56	88.00 E	15"	N: 11245.56 E: 9936.82

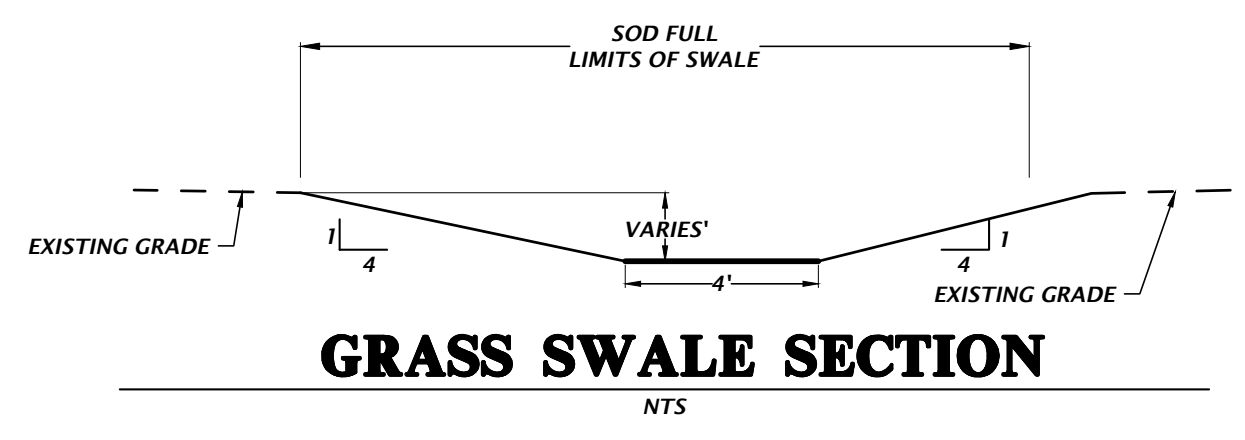

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CONSTRUCTION DIVISIONS

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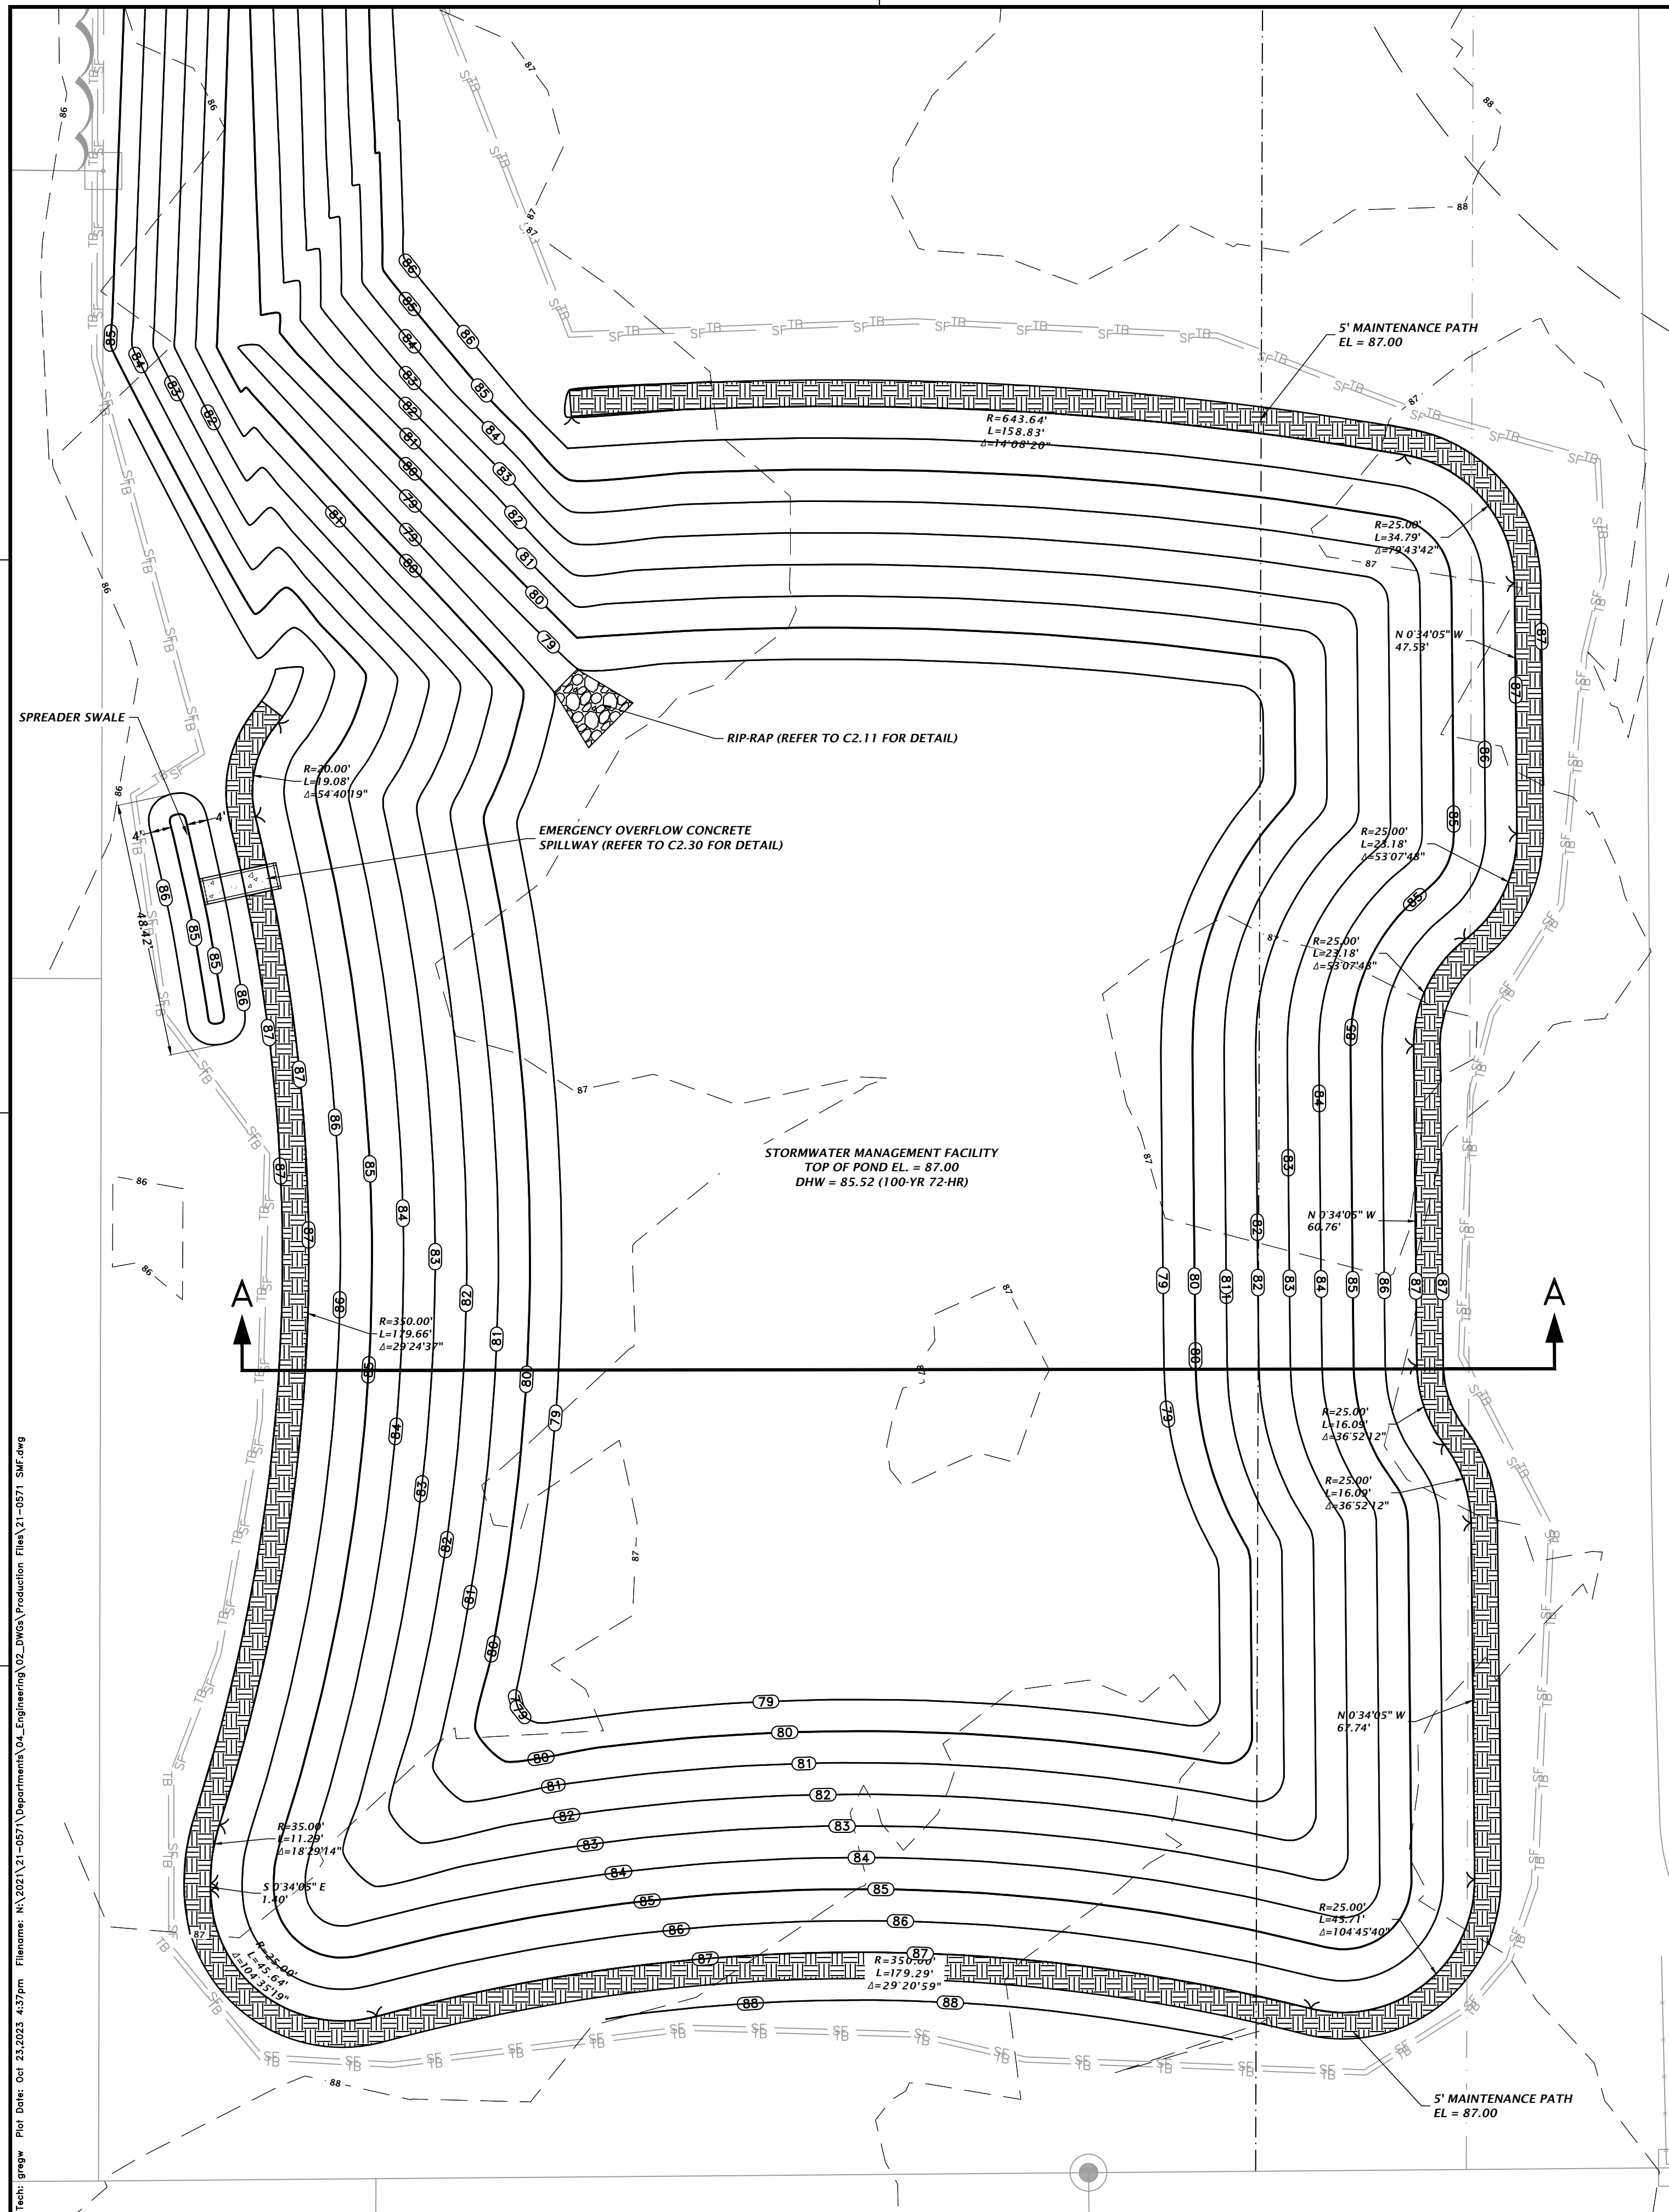
CLIENT: FLETCHER DEVELOPMENT  
PROJECT: FLETCHER CENTER EAST  
SHEET TITLE: DETAILED PAVING, GRADING, AND DRAINAGE PLAN

TECHNICIAN: G. WADZINSKI  
DESIGNER: C. LEDFORD, E.I.  
QUALITY CONTROL: D. YOUNG, P.E.  
PROJECT NUMBER: 21-0571




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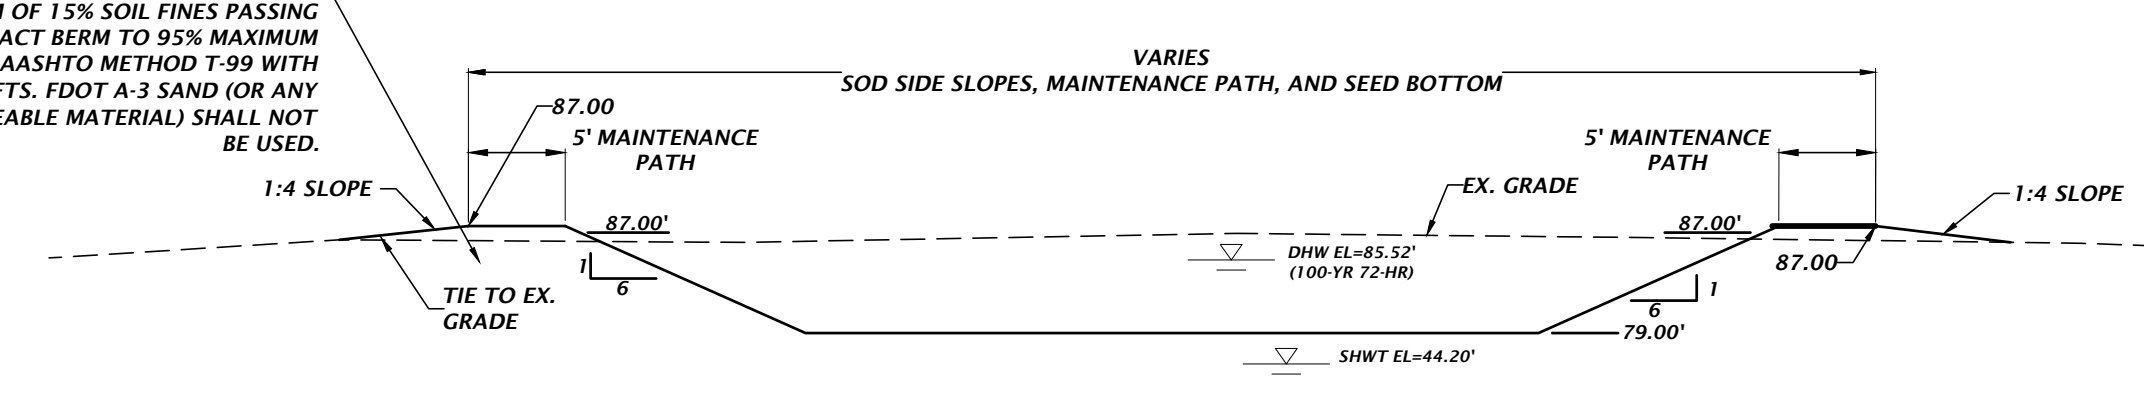




- IF A CONTINUOUS LIMEROCK FORMATION IS ENCOUNTERED IN THE BASIN AREA CONTACT THE ENGINEER OF RECORD. THE LIMEROCK SHALL BE EXCAVATED TO A MINIMUM DEPTH OF 3 FEET BEYOND THE BASIN UNDERCUT LIMITS.
- IF A SOLUTION PIPE SINKHOLE DOES FORM IN THE STORMWATER BASIN, THEN THE SINKHOLE SHALL BE REPAIRED BY BACKFILLING WITH MATERIAL OF LOWER PERMEABILITY MATERIAL, SUCH AS CLAYEY SAND OR CLAY. THE MATERIAL SHALL BE COMPACTED AND THE SINKHOLE REPAIR SHOULD BRING THE SURFACE BACK TO AN ELEVATION WHICH IS SLIGHTLY ABOVE THE ORIGINAL BOTTOM, CREATING A SMALL MOUND.
- IN AREAS WHERE CLAY-RICH SOILS ARE PRESENT AT THE BASIN BOTTOM, THESE SOILS SHALL BE UNDERCUT A MINIMUM OF 3 FEET ON THE BOTTOM AND BACKFILLED WITH ON-SITE SANDS AND SANDS WITH SILT (SP, SP-SM) HAVING A MAXIMUM OF 12 PERCENT OF FINES PASSING THE NO. 200 SIEVE. REFER TO GSE ENGINEERING AND CONSULTING INC.'S SUMMARY REPORT OF GEOTECHNICAL SITE EXPLORATION (DATED MAY 2022).
- EARTHEN BERM SHALL BE CONSTRUCTED WITH SOILS WITH A MAXIMUM OF 12% SOIL FINES PASSING NO. 200 SIEVE. COMPACT BERM TO 95% MAXIMUM DENSITY PER AASHTO METHOD T-99 WITH MAXIMUM 12" LIFTS. FDOT A-3 SAND (OR ANY OTHER HIGHLY PERMEABLE MATERIAL) SHALL NOT BE USED.



EARTHEN BERM SHALL BE CONSTRUCTED WITH SOILS WITH A MINIMUM OF 15% SOIL FINES PASSING NO. 200 SIEVE. COMPACT BERM TO 95% MAXIMUM DENSITY PER AASHTO METHOD T-99 WITH MAXIMUM 12" LIFTS. FDOT A-3 SAND (OR ANY OTHER HIGHLY PERMEABLE MATERIAL) SHALL NOT BE USED.

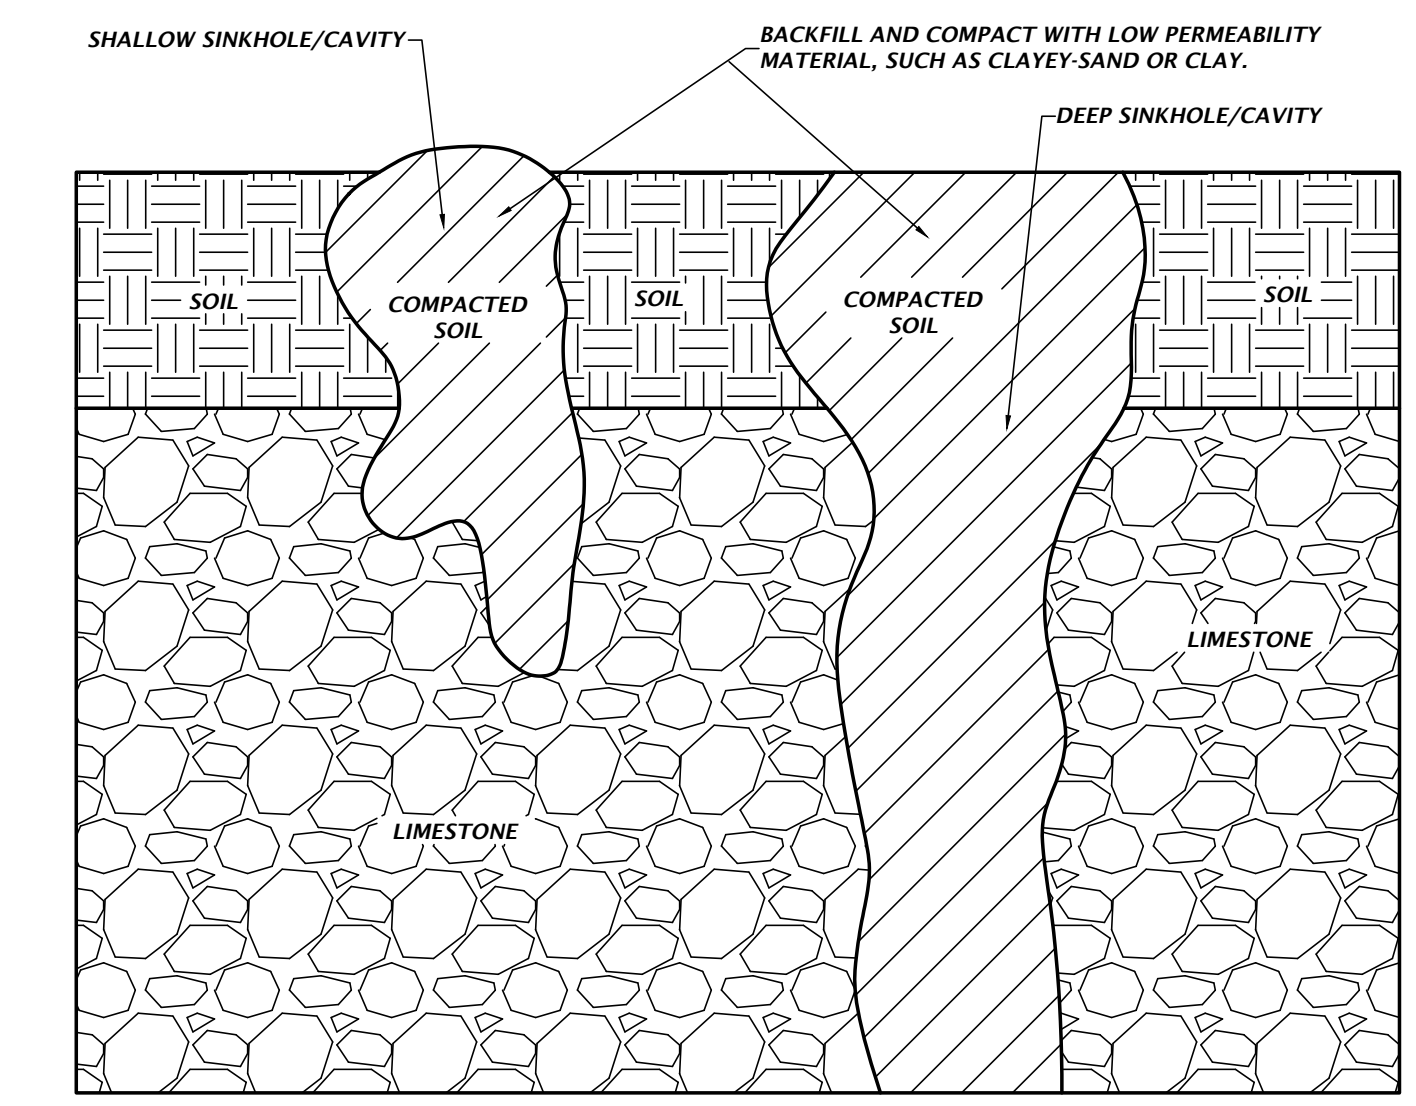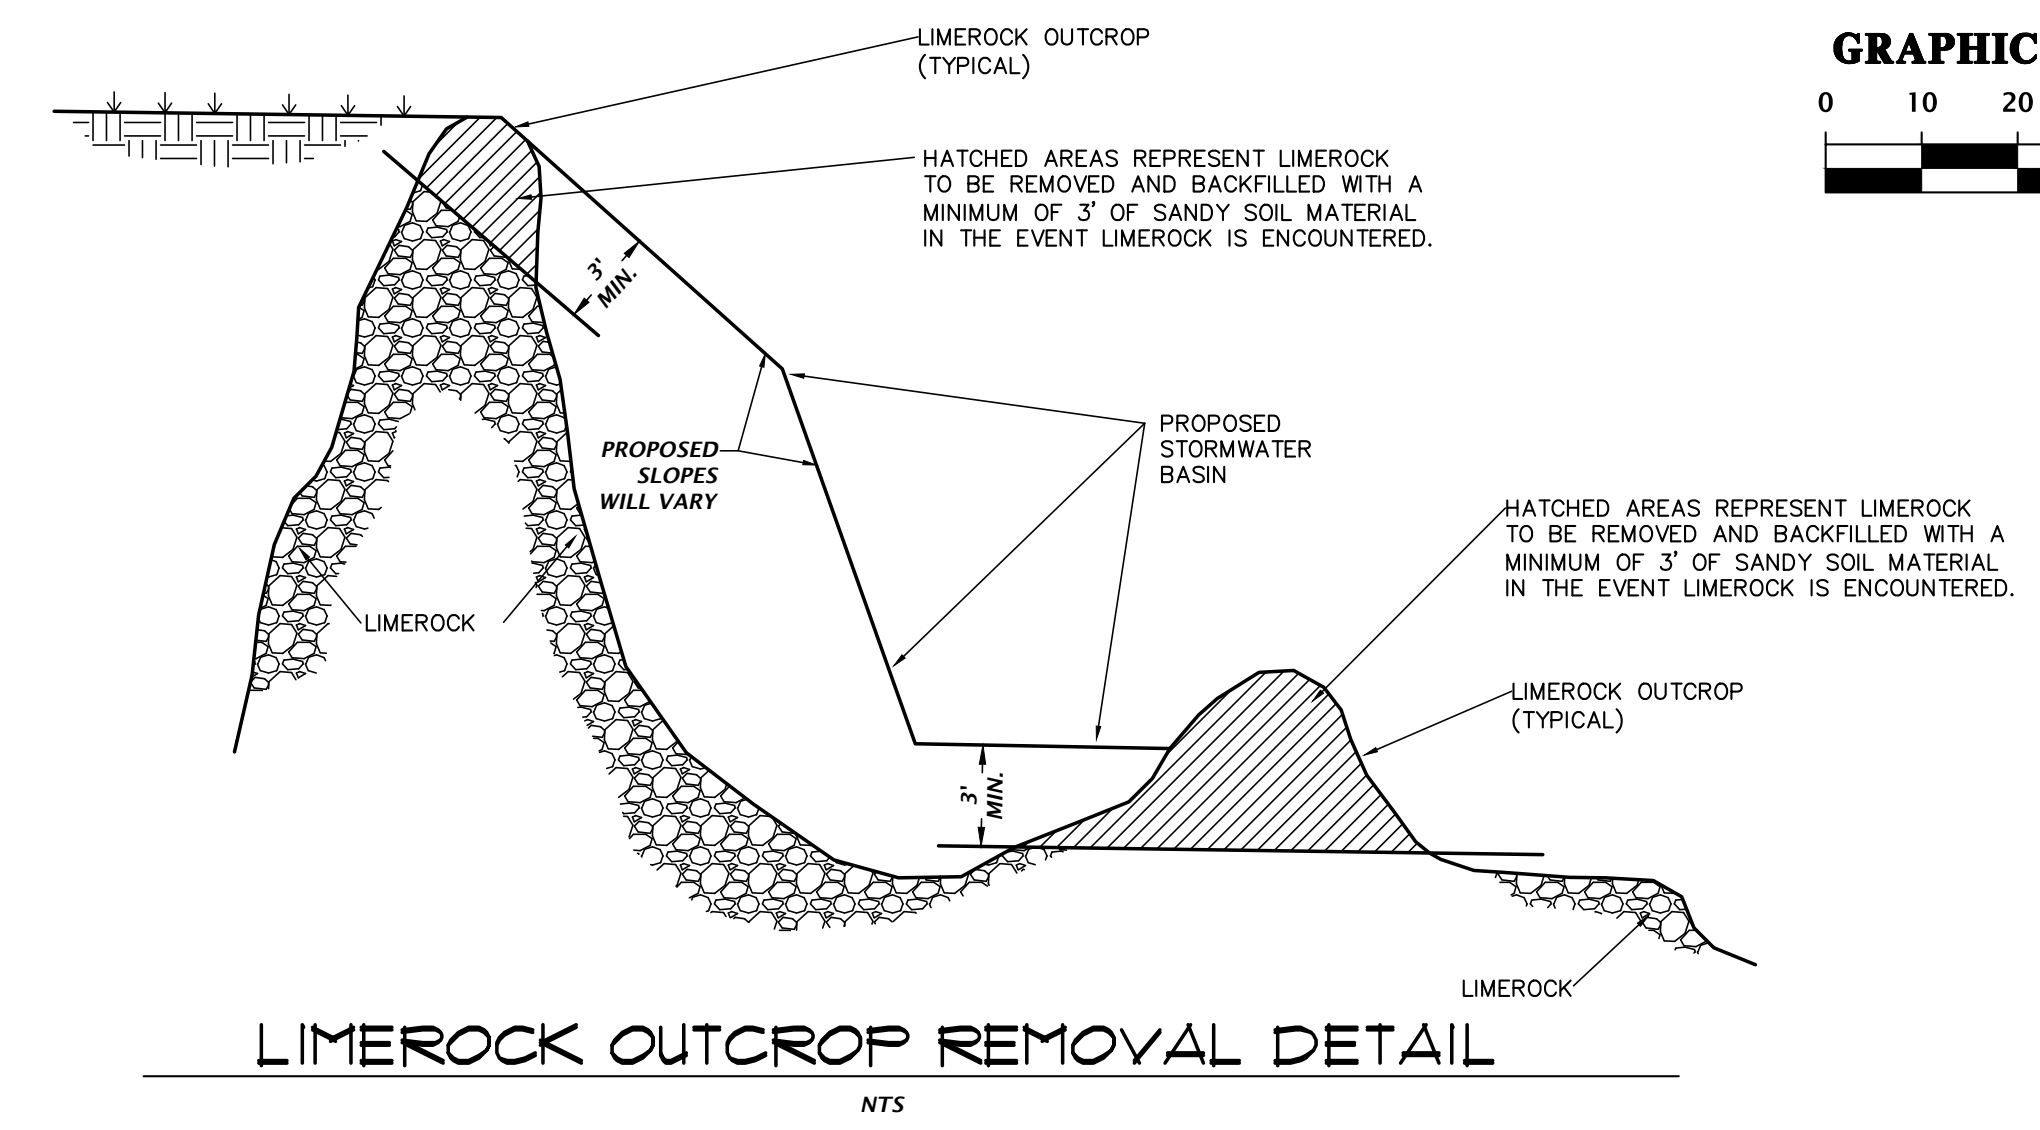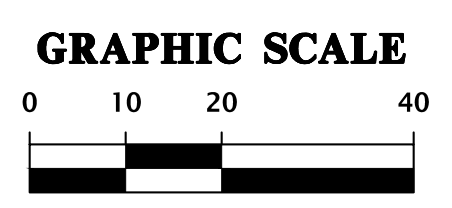

- IF A CONTINUOUS LIMEROCK FORMATION IS ENCOUNTERED IN THE BASIN AREA CONTACT THE ENGINEER OF RECORD. THE LIMEROCK SHALL BE EXCAVATED TO A MINIMUM DEPTH OF 3 FEET BEYOND THE BASIN UNDERCUT LIMITS.
- IF A SOLUTION PIPE SINKHOLE DOES FORM IN THE STORMWATER BASIN, THEN THE SINKHOLE SHALL BE REPAIRED BY BACKFILLING WITH MATERIAL OF LOWER PERMEABILITY MATERIAL, SUCH AS CLAYEY SAND OR CLAY. THE MATERIAL SHALL BE COMPACTED AND THE SINKHOLE REPAIR SHOULD BRING THE SURFACE BACK TO AN ELEVATION WHICH IS SLIGHTLY ABOVE THE ORIGINAL BOTTOM, CREATING A SMALL MOUND.
- IN AREAS WHERE CLAY RICH SOILS ARE ENCOUNTERED AT THE BASIN BOTTOM, UNDERCUT SOILS A MINIMUM OF 3 FEET AND BACKFILL WITH ON-SITE OR IMPORTED SANDS AND SAND WITH SILT (SP-SM) HAVING A MAXIMUM OF 12 PERCENT SOIL FINES PASSING THE NO. 200 SIEVE.

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Date: Oct 23, 2023 4:37pm  
User: gregg

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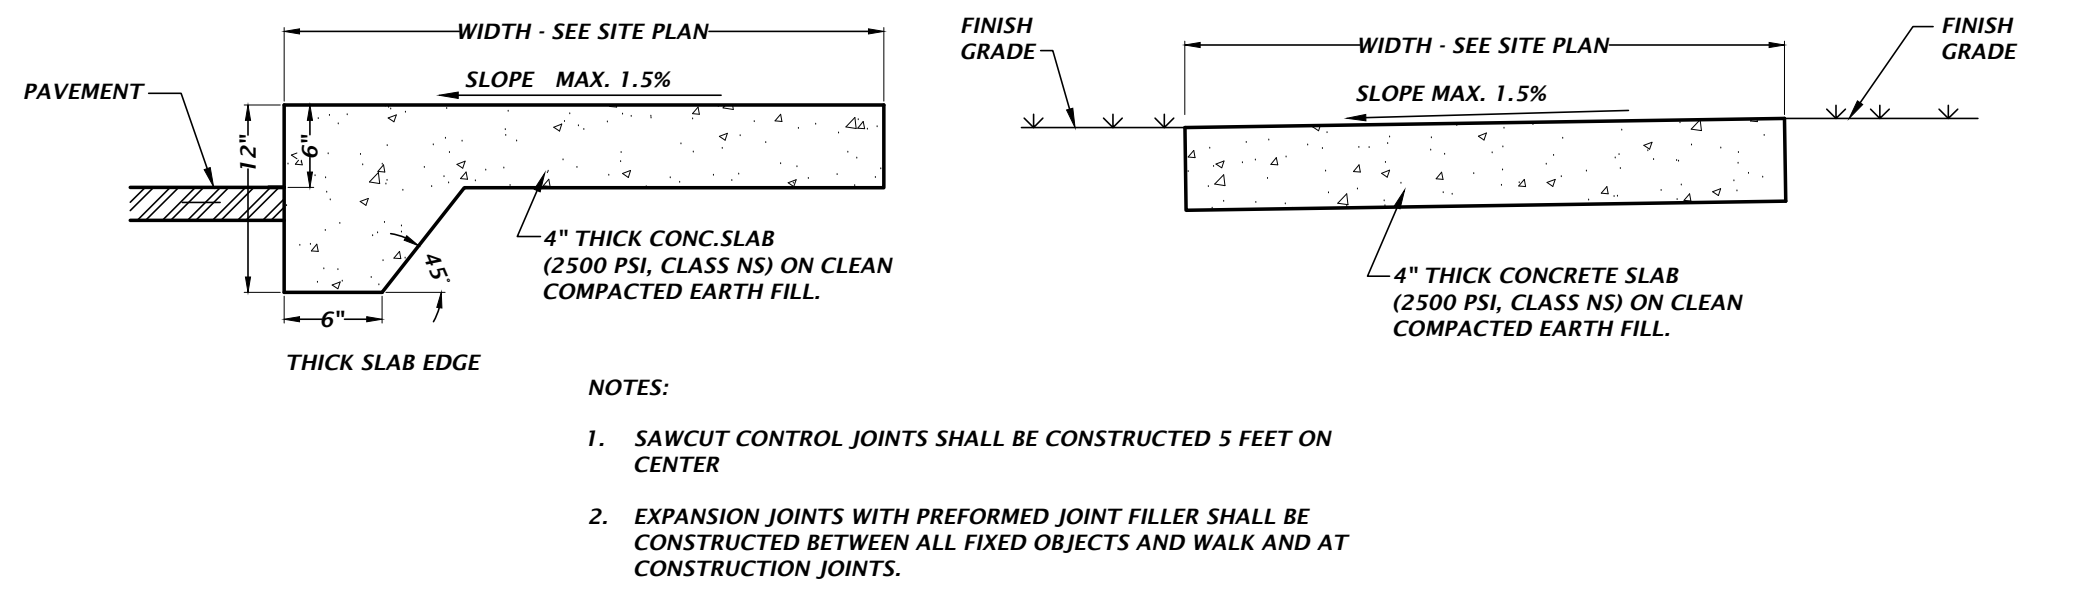
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10/10/23 - SUBMITTAL TO ALACHUA COUNTY  
10/23/23 - BID SET

CLIENT: FLETCHER DEVELOPMENT  
PROJECT: FLETCHER CENTER EAST  
SHEET TITLE: STORMWATER MANAGEMENT FACILITY PLAN  
PROJECT NUMBER: 21-0571

TECHNICAL: G. WADZINSKI  
DESIGNER: G. LEDFORD, E.I.  
QUALITY CONTROL: D. YOUNG, P.E.  
DANIEL H. YOUNG  
Daniel H. Young, P.E.  
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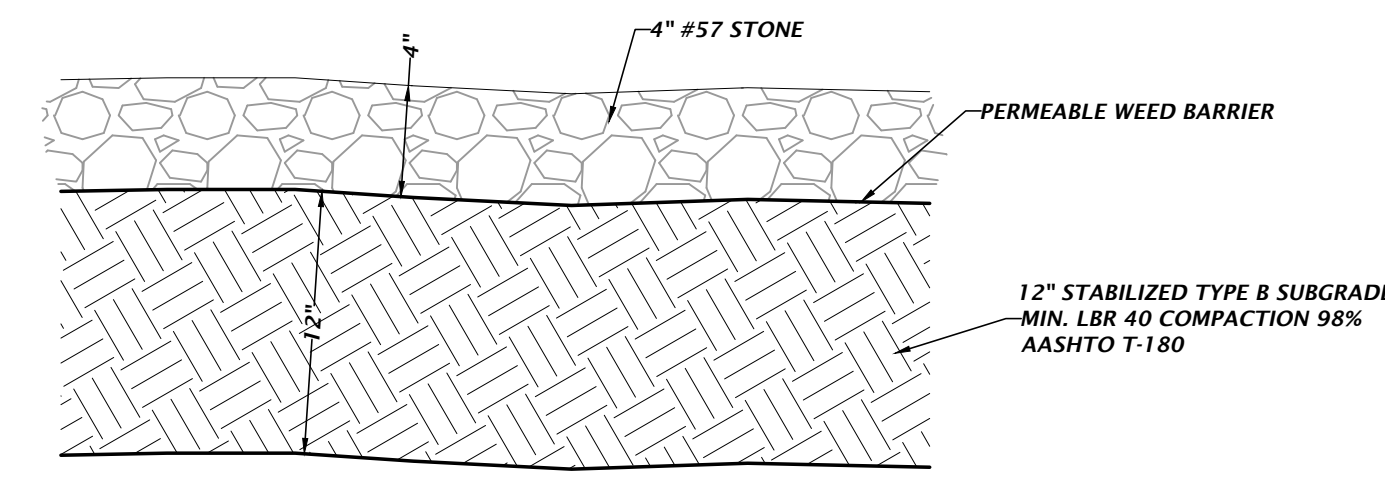




- NOTES:
1. SAWCUT CONTROL JOINTS SHALL BE CONSTRUCTED 5 FEET ON CENTER
  2. EXPANSION JOINTS WITH PREFORMED JOINT FILLER SHALL BE CONSTRUCTED BETWEEN ALL FIXED OBJECTS AND WALK AND AT CONSTRUCTION JOINTS.


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**CONCRETE SIDEWALK DETAILS**




NOTE: GRAVEL MATERIAL SHALL BE FDOT CERTIFIED MATERIAL.


**GRAVEL DETAIL**

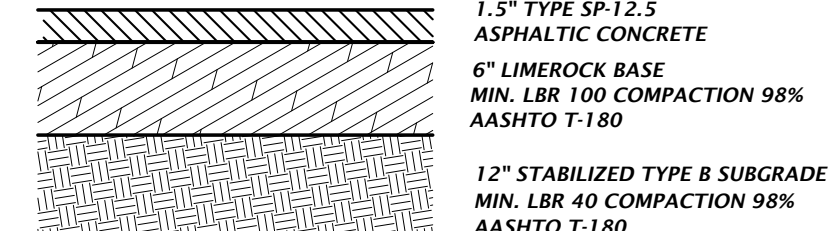

**STANDARD DUTY ASPHALT DETAIL**

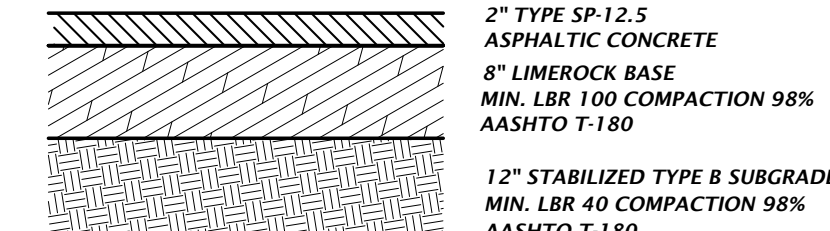


**HEAVY DUTY ASPHALT DETAIL**

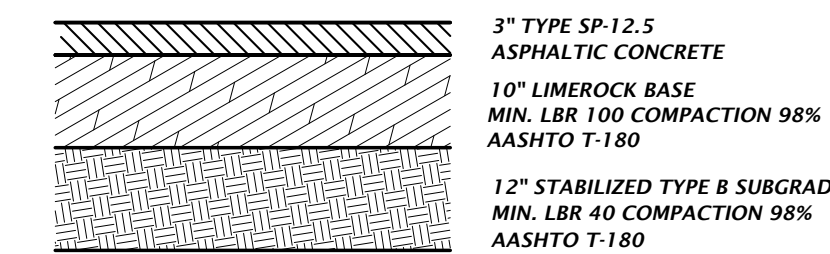


**FDOT ROW ASPHALT DETAIL**

**ASPHALT PAVEMENT DETAILS**

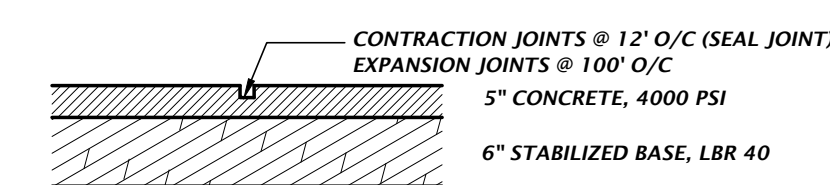


NOTE: CONCRETE PAVEMENT & JOINTS SHALL BE CONSTRUCTED TO FC & PA STANDARDS.


**HEAVY DUTY CONCRETE DETAIL**

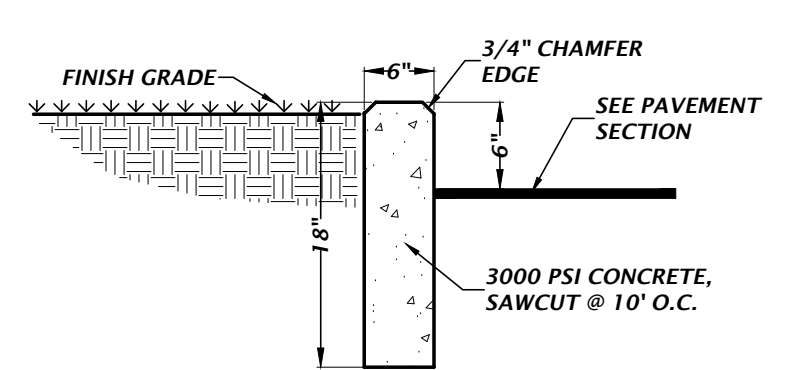

**TYPICAL 6" CURB DETAIL**

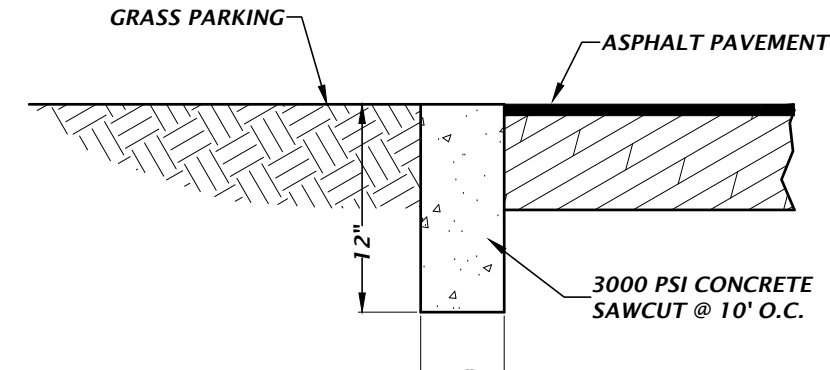


**FLUSH CURB DETAIL**

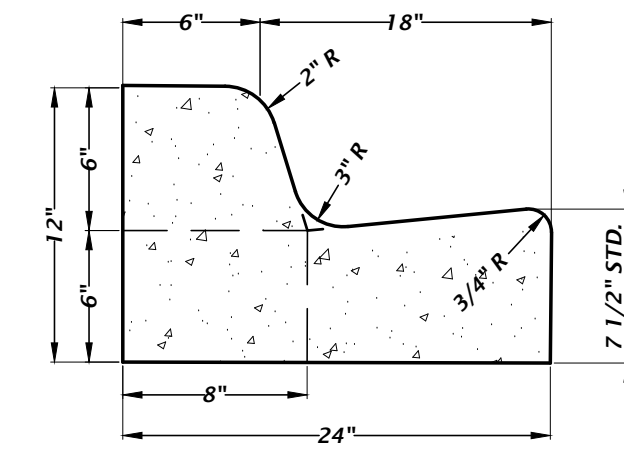

NOTE: WHEN USED ON THE HIGH SIDE OF ROADWAY, THE CROSS-SLOPE OF THE GUTTER SHALL MATCH THE CROSS-SLOPE OF THE ADJACENT PAVEMENT AND THE THICKNESS OF THE LIP SHALL BE 6".



**TYPE F CONCRETE CURB AND GUTTER DETAIL**

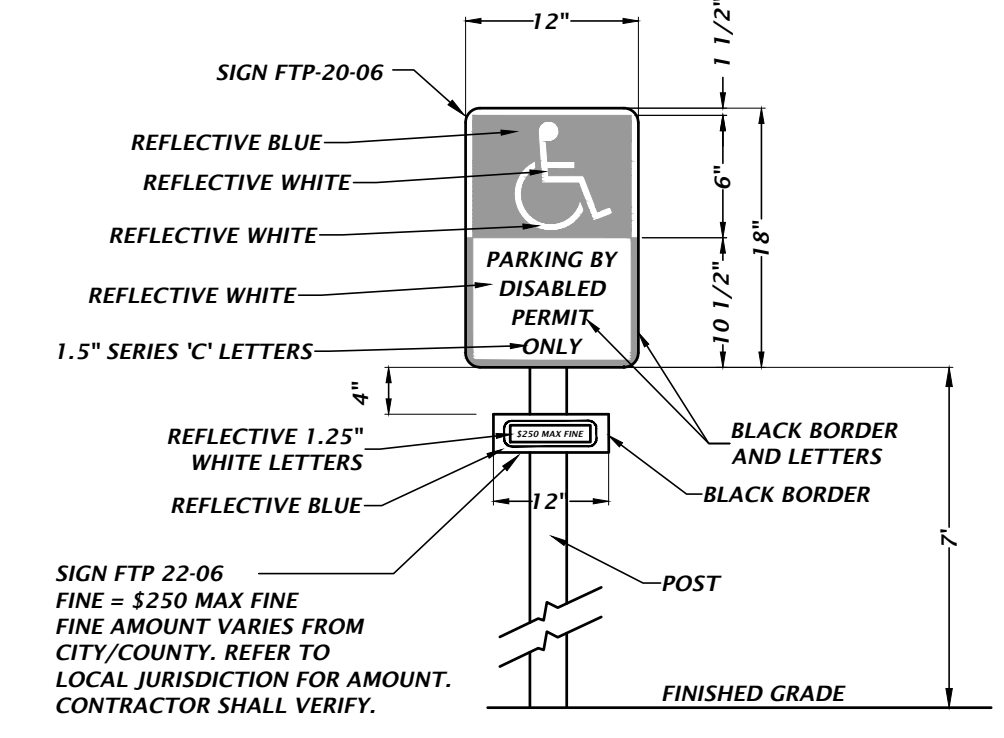


SIGN FTP 22-06  
FINE = \$250 MAX FINE  
FINE AMOUNT VARIES FROM CITY/COUNTY. REFER TO LOCAL JURISDICTION FOR AMOUNT. CONTRACTOR SHALL VERIFY.

- SIGN NOTES:
1. SIGN CONSTRUCTION, DESIGN AND PLACEMENT SHALL COMPLY WITH STATE AND LOCAL STATUTES.


**ACCESSIBLE PARKING SIGN DETAIL**

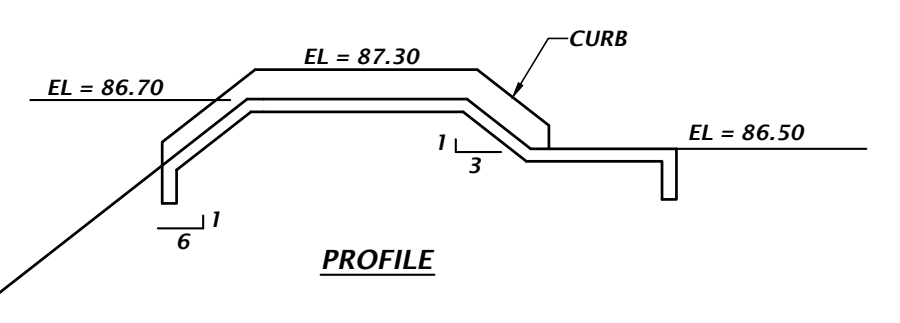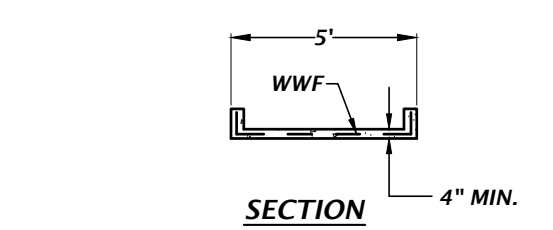

**EMERGENCY OVERFLOW CONCRETE SPILLWAY DETAIL**

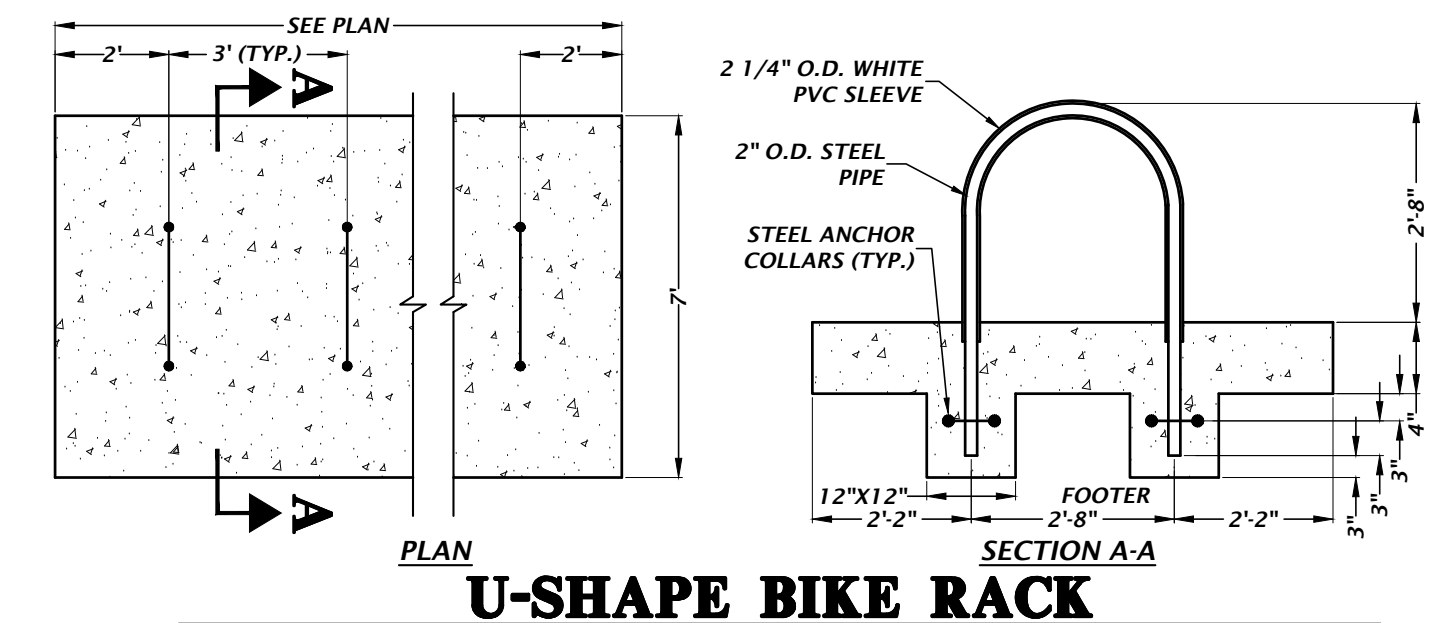

**U-SHAPE BIKE RACK**

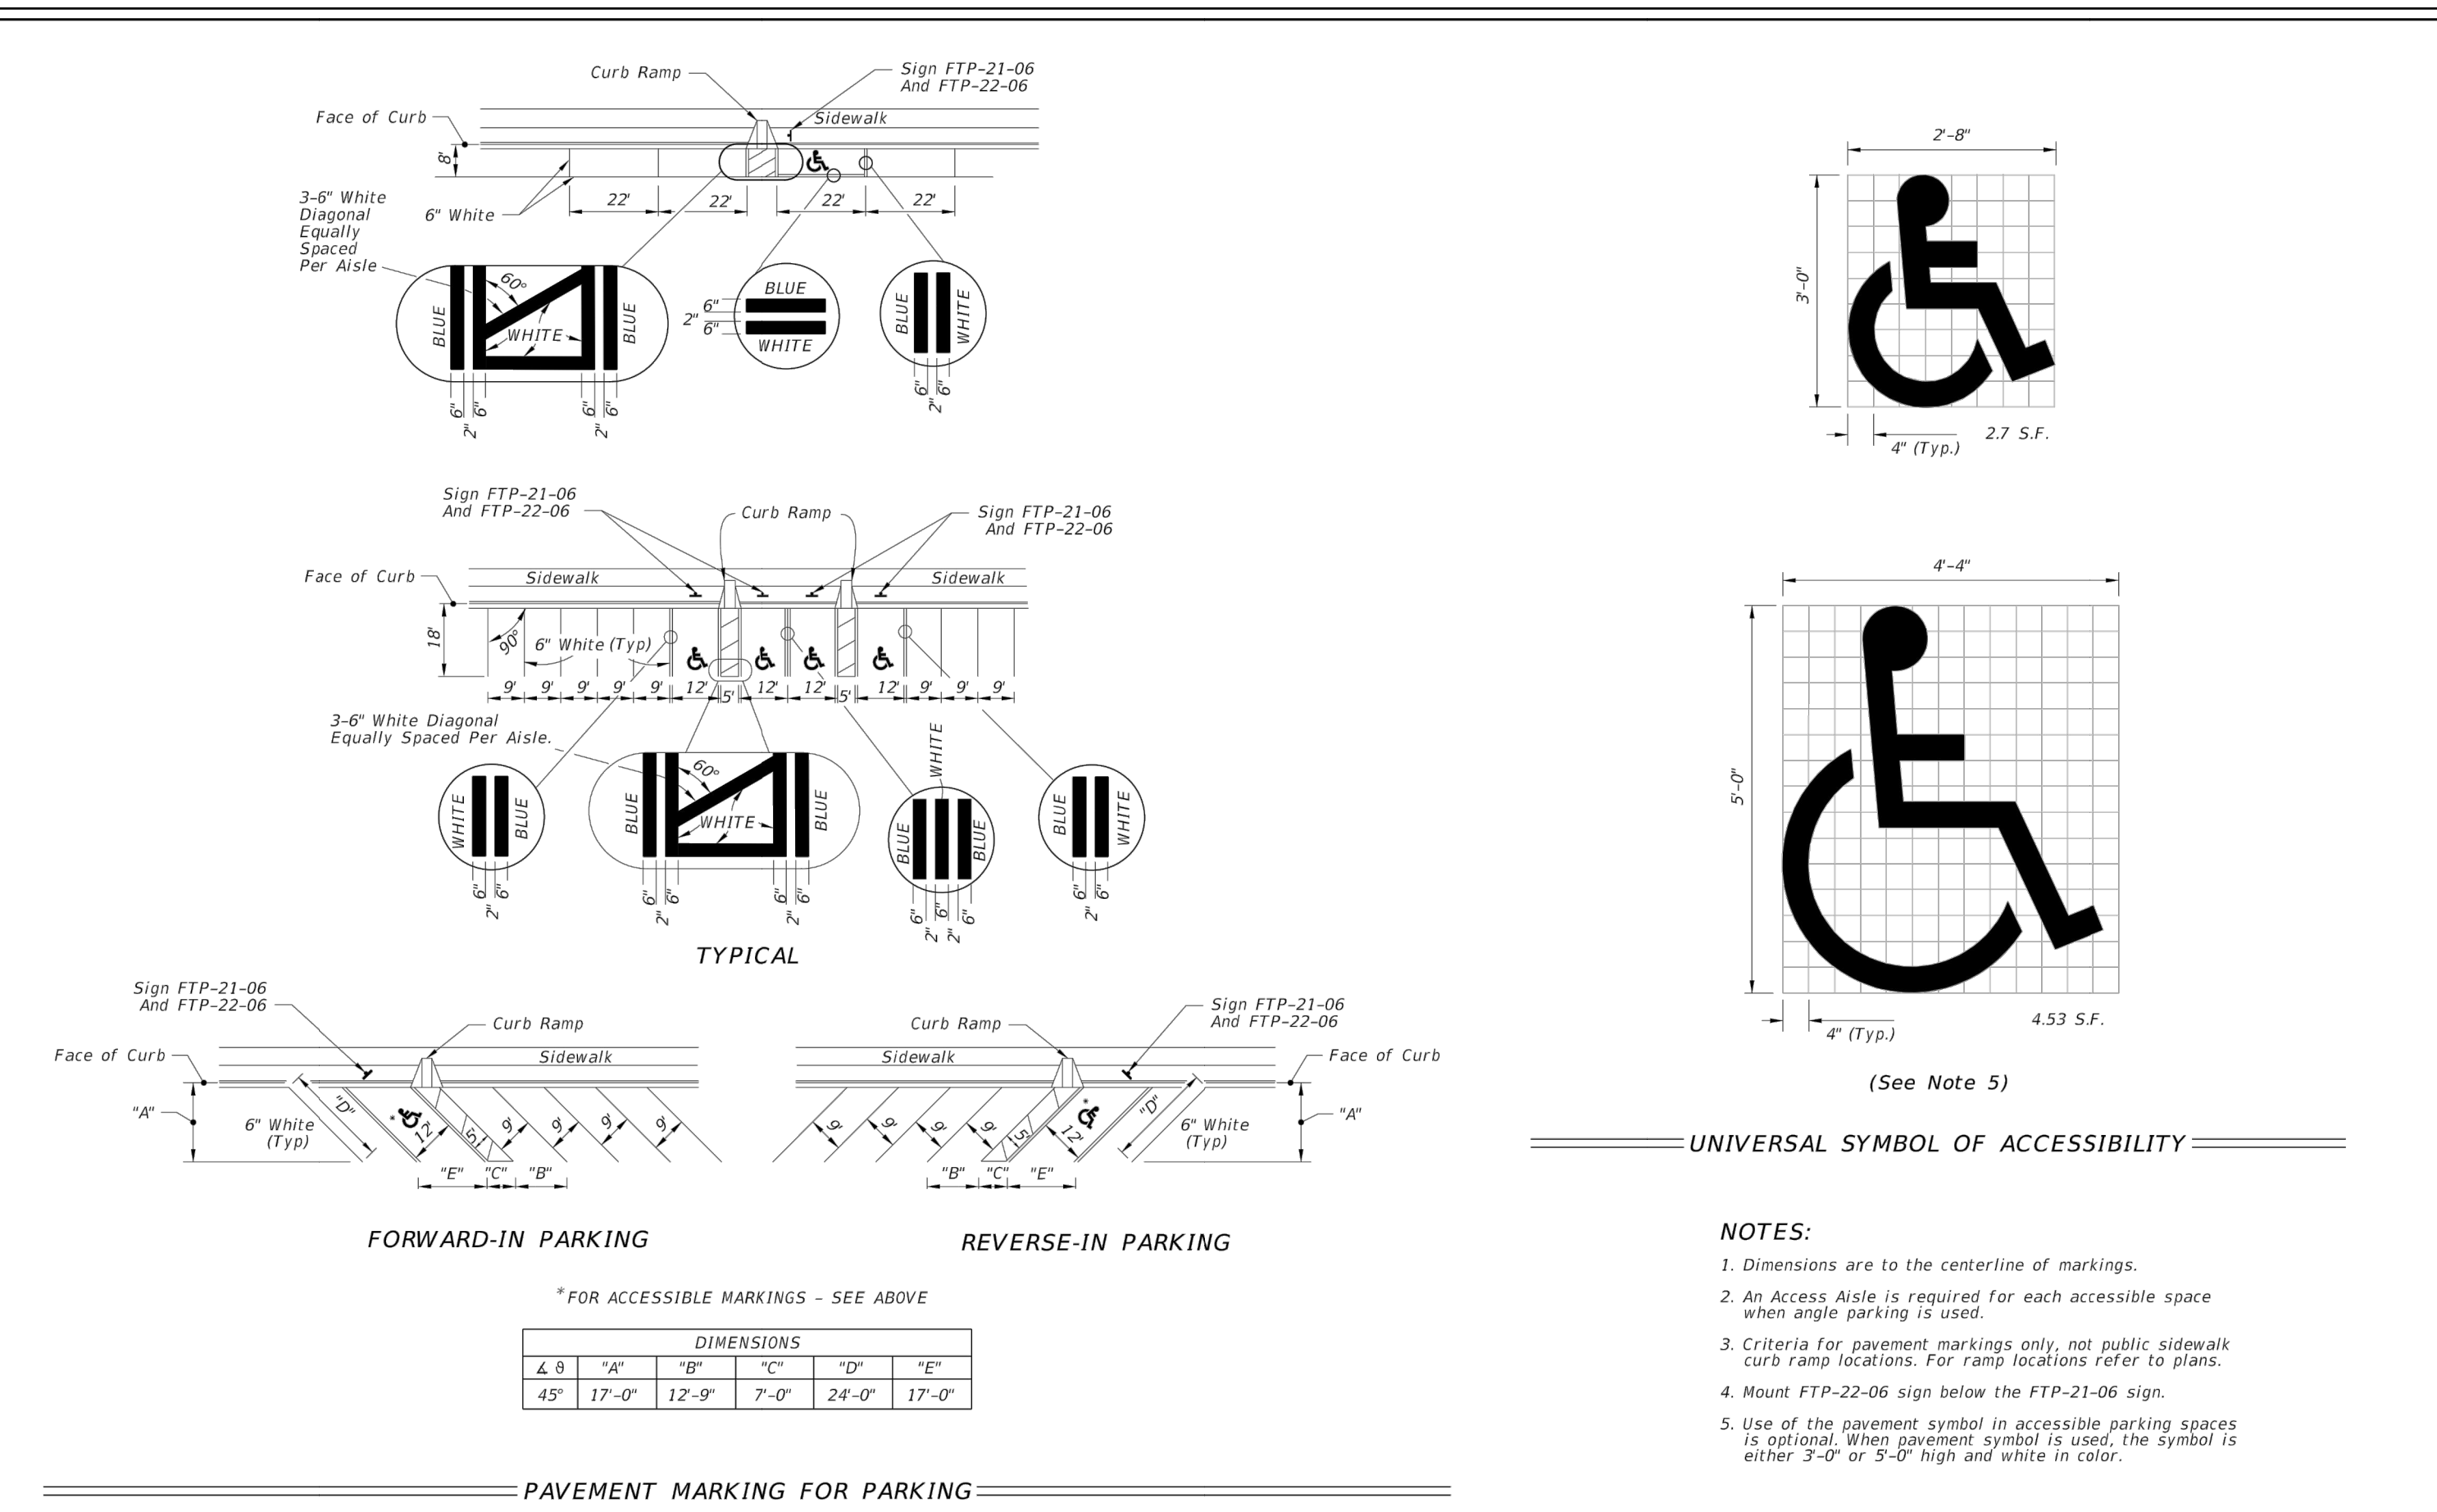

\*FOR ACCESSIBLE MARKINGS - SEE ABOVE

DIMENSIONS	
Δ 8	"A" "B" "C" "D" "E"
45"	17'-0" 12'-9" 7'-0" 24'-0" 17'-0"

- NOTES:
1. Dimensions are to the centerline of markings.
  2. An Access Aisle is required for each accessible space when angle parking is used.
  3. Criteria for pavement markings only, not public sidewalk curb ramp locations. For ramp locations refer to plans.
  4. Mount FTP-22-06 sign below the FTP-21-06 sign.
  5. Use of the pavement symbol in accessible parking spaces is optional. When pavement symbol is used, the symbol is either 3'-0" or 5'-0" high and white in color.

LAST REVISION 11/01/21	DESCRIPTION:	FDOT FY 2023-24 STANDARD PLANS	INDEX 711-001	SHEET 11 of 13
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Title: gmpg For Date: Oct 23, 2023 4:37pm Filename: N:\2023\11-01\1\Department\GA\_Engineering\02\_DWG\Production\Fla\_A\21-0571\_D1.dwg

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SCALE: N/A  
VERIFY SCALE  
BAR IS ONE INCH ON  
0 ORIGINAL DRAWING  
IF NOT ONE INCH ON  
SCALES ACCORDINGLY.

CONSTRUCTION/DRAWING NO.:



DATE: 6/5/23 - SUBMITTAL TO ALACHUA COUNTY, CRU, FOOT, AND SRWMD  
7/31/23 - SUBMITTAL TO ALACHUA COUNTY, CRU, FOOT, AND SRWMD  
10/10/23 - SUBMITTAL TO CRU & FOOT  
10/23/23 - BID SET

CLIENT: FLETCHER DEVELOPMENT  
PROJECT: FLETCHER CENTER EAST  
QUALITY CONTROL: D. YOUNG, P.E.  
SHEET TITLE: CONSTRUCTION DETAILS  
SHEET NUMBER: 21-0571

TECHNICIAN: G. WADZANSKI  
DESIGNER: G. LEDFORD, E.I.  
DANIEL H. YOUNG  
Daniel H. Young, P.E.  
State of Florida, Professional  
Engineer, License No. 78780  
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H. Young, P.E., on the date  
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FL PE No. 70780  
SHEET NO.: **C2.30**



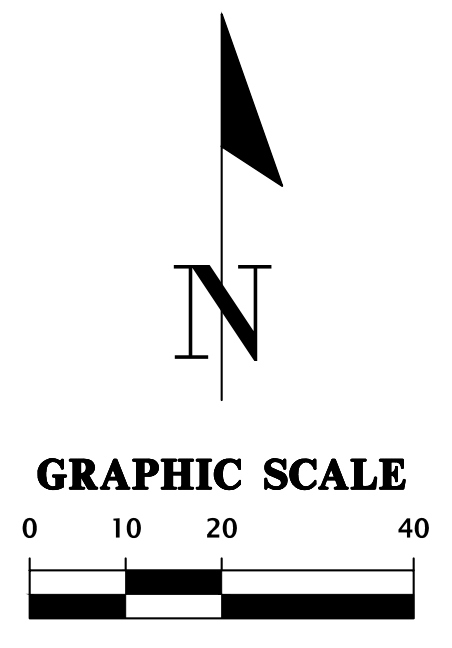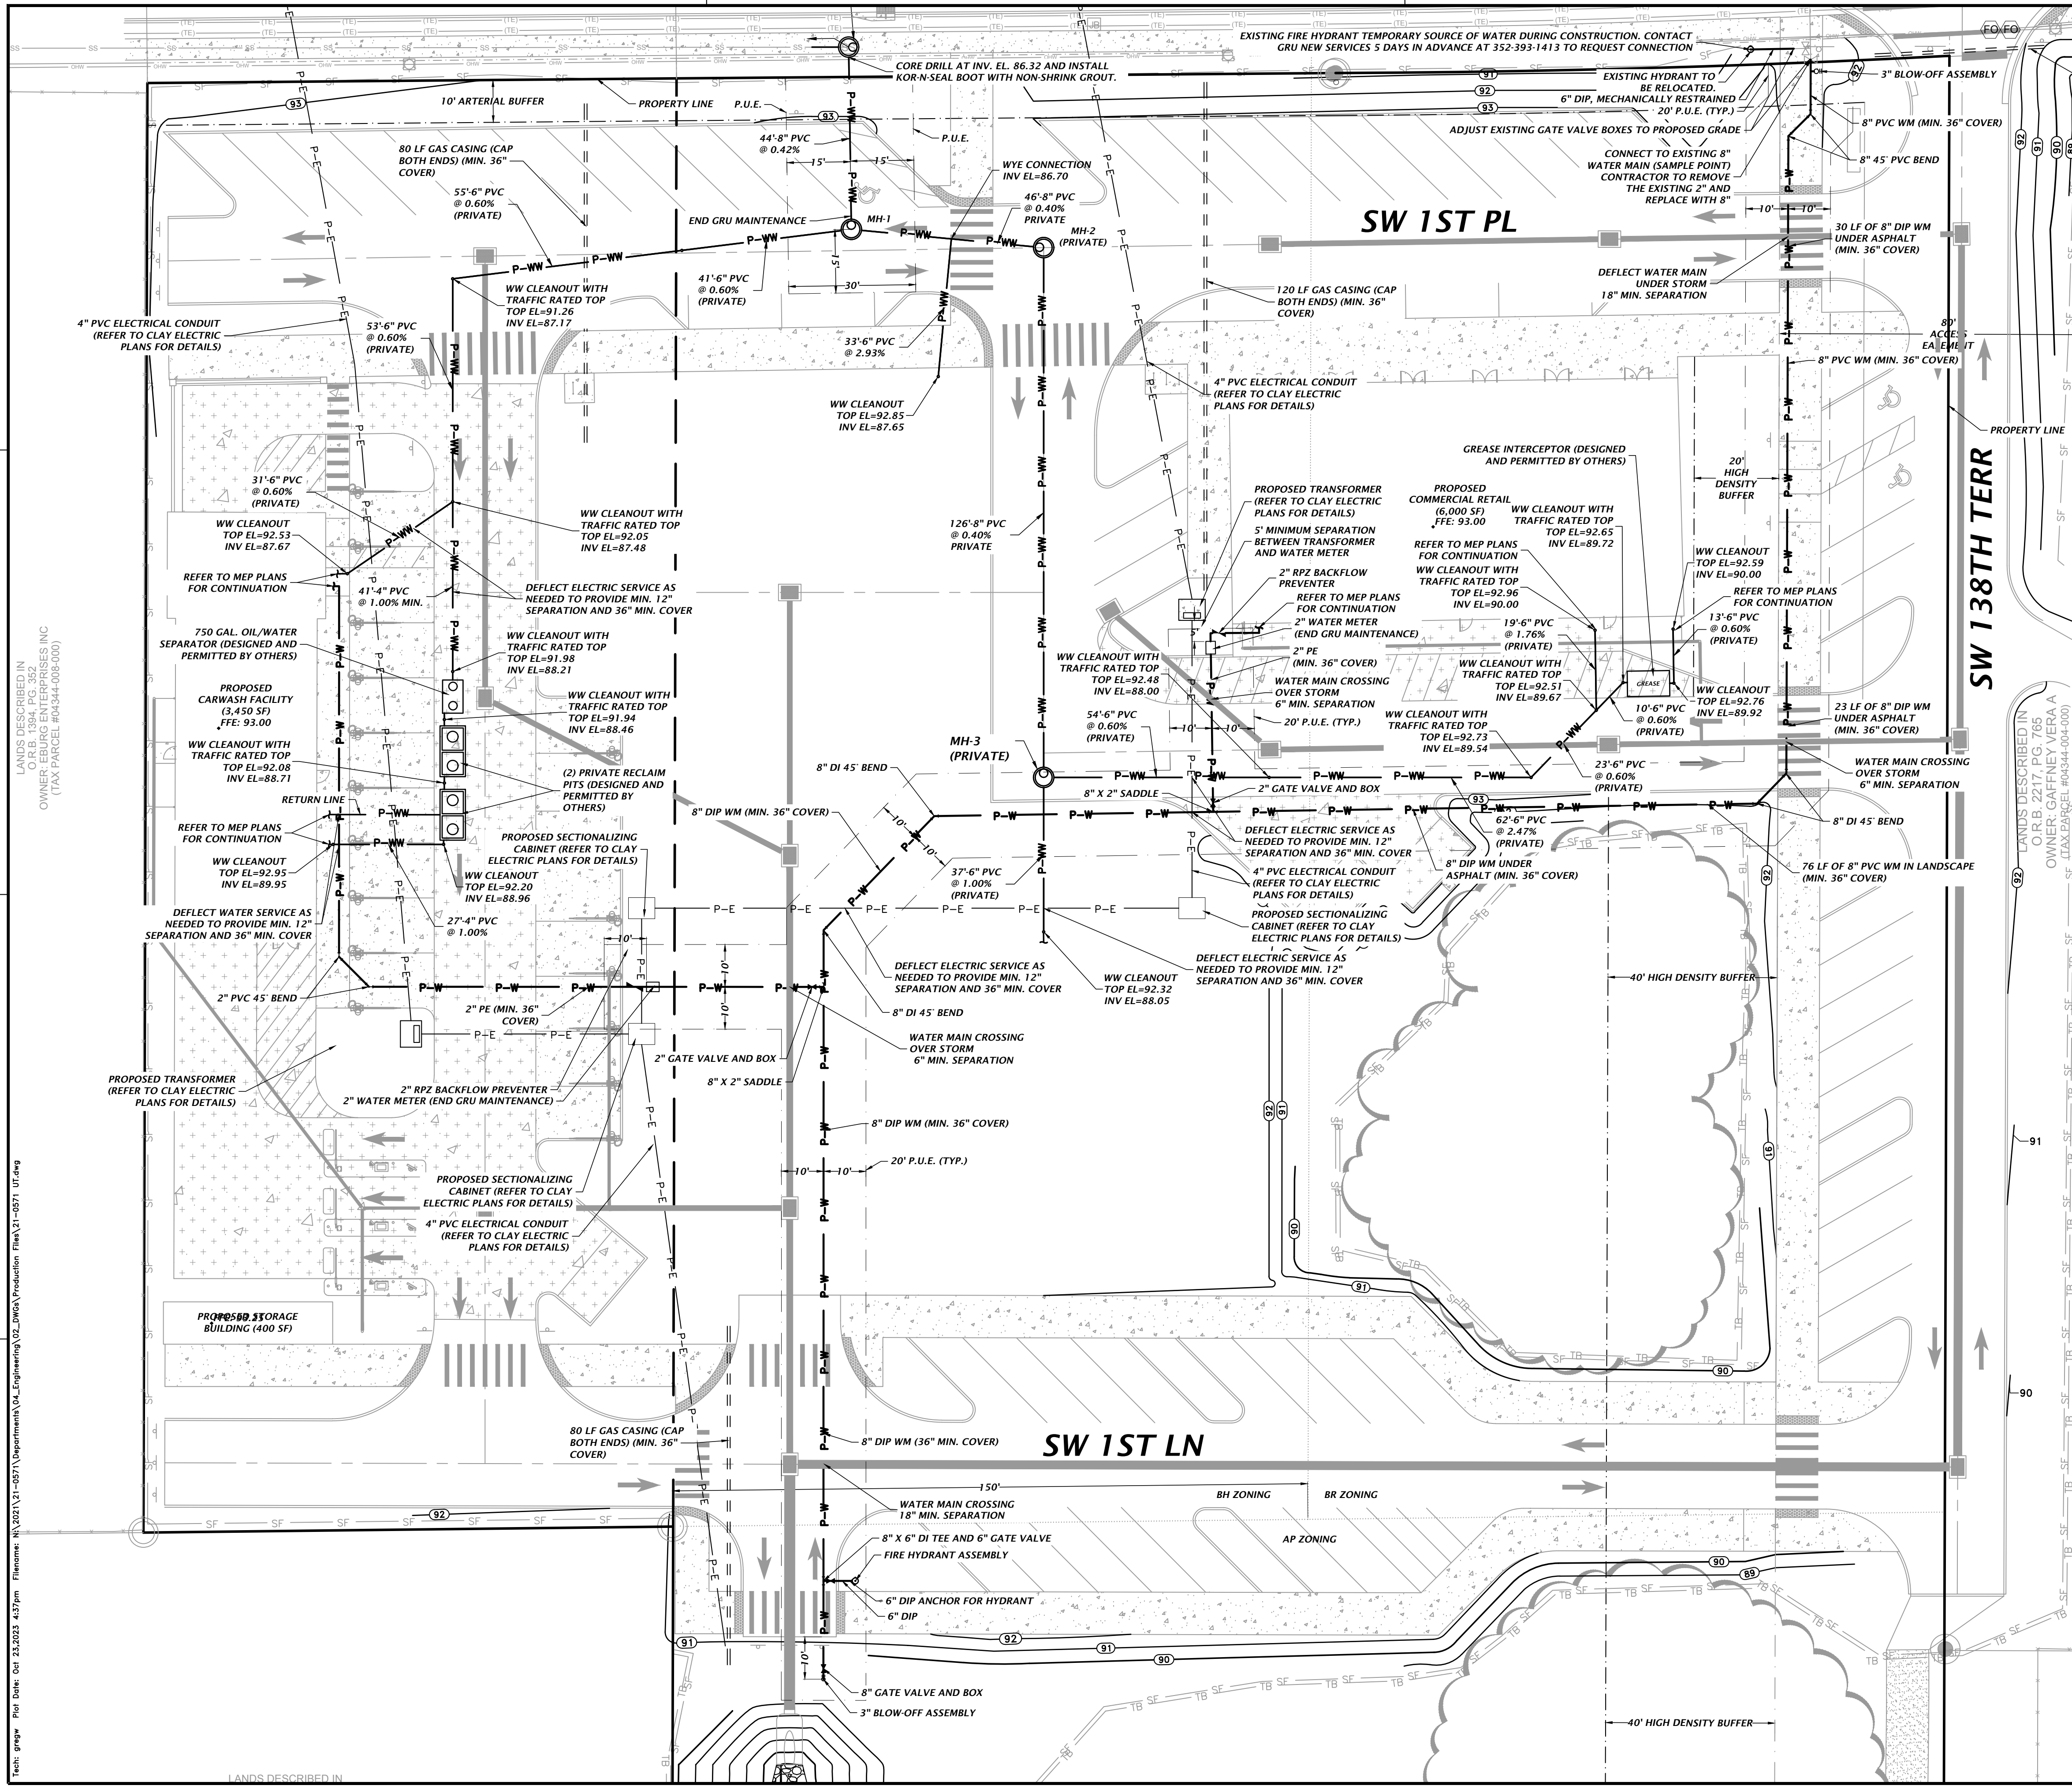

CLAY ELECTRIC NOTES: THE SITE CONTRACTOR SHALL CONSTRUCT ALL CONDUITS (PRIMARY AND SECONDARY) PER PLANS PROVIDED BY CLAY ELECTRIC CORP (CEC).

NOTE: ALL PIPE CONNECTIONS TO BE MADE WITH A WYE CONNECTION. PIPES SHOWN FOR SCHEMATIC PURPOSES ONLY.

SANITARY SEWER STRUCTURE TABLE				
STRUCTURE NAME:	STRUCTURE TYPE	TOP	INVERT ELEV	NORTHING & EASTING
EX-MH	EXISTING MANHOLE	92.92	86.22 (8') W 86.32 (8') S	N: 11292.13 E: 9837.25
MH-1	GRU MANHOLE PER GRU STANDARDS (END OF GRU MAINTENANCE)	92.08	86.60 (8') E 86.50 (8') N 86.60 (6') W	N: 11249.07 E: 9837.90
MH-2	PRIVATE MANHOLE PER GRU STANDARDS	92.45	86.88 (8') S 86.78 (8') W	N: 11244.76 E: 9883.34
MH-3	PRIVATE MANHOLE PER GRU STANDARDS	92.45	87.68 (6') S 87.38 (8') N 87.68 (6') E	N: 11119.61 E: 9883.34

**GRU UTILITY NOTES**

- AN FDOT UTILITY PERMIT MAY BE REQUIRED FOR UTILITY CONNECTIONS WITHIN THE NEWBERRY ROAD ROW.
- THE UTILITY PLAN AND PLAT SHOWS ALL PUBLIC UTILITY EASEMENTS (PUE'S) IN A METES AND BOUNDS FORMAT. UPON GRU'S APPROVAL OF PLANS FOR DEVELOPMENTS NOT BEING PLATTED, OWNER MAY CHOOSE TO GRANT THE METES AND BOUNDS EASEMENTS AS SHOWN, OR A BLANKET EASEMENT OVER THE ENTIRE PROPERTY, PROVIDED FACILITIES ARE INSTALLED WITHIN THE PRESCRIBED DISTANCES AS SHOWN ON THE UTILITY PLANS AND IN ACCORDANCE WITH THE UTILITY SEPARATION REQUIREMENTS TABLE IN APPENDIX C OF THE GRU W/WW/RCW DESIGN STANDARDS.
- ALL CONSTRUCTION MATERIALS AND METHODS FOR POTABLE WATER, WASTEWATER, AND RECLAIMED WATER SYSTEMS SHALL CONFORM TO GRU'S MOST RECENT POTABLE WATER, WASTEWATER, & RECLAIMED WATER SYSTEM DESIGN STANDARDS AND APPROVED MATERIALS MANUAL.
- POTABLE WATER AND WASTEWATER MAINS SHALL MAINTAIN A MINIMUM 10 FEET HORIZONTAL AND 1.5 FOOT VERTICAL SEPARATION.
- A MINIMUM HORIZONTAL SEPARATION OF 10 FEET FOR POTABLE WATER MAINS, WASTEWATER FORCE MAINS, AND RECLAIMED WATER MAINS, AND 15 FEET FOR GRAVITY WASTEWATER MAINS SHALL BE PROVIDED AND MAINTAINED FROM BUILDINGS, TRANSFORMERS, AND ALL PERMANENT STRUCTURES. SERVICE LATERALS REQUIRE 5 FEET LESS CLEARANCE FOR EACH OF THE UTILITIES. NOTE THAT WATER SERVICE LATERALS SHALL BE INSTALLED WITHIN 3" SLEEVES. (SEE APPENDIX C OF GRU'S DESIGN STANDARDS AND CONSTRUCTION DETAILS FOR POTABLE WATER, WASTEWATER, AND RECLAIMED WATER - HORIZONTAL SEPARATION DISTANCES FOR PARALLEL AND PERPENDICULAR CLEARANCE FROM OTHER OBJECTS TABLE.)
- POTABLE WATER SERVICES, REQUIRING A SEPARATE WATER METER, SHALL BE PROVIDED TO EACH LOT, BUILDING OR PARCEL. EFFECTIVE OCTOBER 1, 2007, FOR COMMERCIAL, MULTIFAMILY, AND INSTITUTIONAL DEVELOPMENTS, THE DEVELOPER SHALL BE RESPONSIBLE FOR INSTALLING POTABLE WATER SERVICES AND YOKE ASSEMBLY PACKAGE UP TO AND INCLUDING THE METER YOKE, BOX (INSTALLED AT FINAL GRADE) AND ASSOCIATED APPURTENANCES, FOR METERS 1" AND SMALLER (SEE GRU W/WW/RCW CONSTRUCTION DETAIL W-8.0), WITH A ONE-YEAR WARRANTY.
- 2" VALVES LOCATED IN PAVED AREAS, INCLUDING SIDEWALKS, SHALL BE GRU APPROVED CAST IRON, RESILIENT SEAT GATE VALVES WITH STANDARD 2" OPERATING NUT, THREADED WITH BRASS NIPPLE BETWEEN THE VALVES AND TAPPING SADDLE OR TAPPED TEE.
- WATER MAINS 4" IN DIAMETER AND GREATER, PLACED UNDER ROADWAYS, SHALL BE CEMENT LINED DUCTILE IRON PIPE (CLDIP) EXTENDING 5 FEET PAST THE BACK OF CURB (3 FEET WITHIN CITY OF GAINESVILLE LIMITS). TRACER WIRE INSTALLED ON PVC WATER MAINS SHALL CONTINUE ACROSS THE CLDIP SECTIONS.
- 1" OR 2" WATER SERVICE CROSSINGS LOCATED UNDER ROADWAYS SHALL BE ENCASED IN 3" SCH 40 PVC EXTENDING 5' PAST THE BACK OF CURB (3 FEET INSIDE CITY OF GAINESVILLE LIMITS).
- ANCHORING TEES, COUPLINGS, AND BENDS SHALL BE USED ON ALL FIRE HYDRANT ASSEMBLIES.
- ALL PRESSURIZED MAIN FITTINGS SHALL BE MECHANICAL JOINT WITH RESTRAINED JOINT GLANDS; A SUFFICIENT LENGTH OF THE PIPE CONNECTED TO THE FITTINGS SHALL BE MECHANICALLY RESTRAINED TO PROVIDE REACTION AS SPECIFIED ON THE RESTRAINED JOINT STANDARD IN THE CONSTRUCTION DETAILS OF THE GRU STANDARDS (W-2.8 & 2.9, RCW-2.8 & 2.9, AND WW-2.4 & 2.5). CALCULATIONS FOR REQUIRED RESTRAINT LENGTH MUST BE PROVIDED IF THE SPECIFIED RESTRAINT LENGTH, DUE TO SOIL TYPE OR DEPTH OF COVER, DIFFERS FROM THOSE PROVIDED ON THESE DETAILS.
- ALL SANITARY WASTEWATER SERVICE LATERALS SHALL BE MIN. 4" DIAMETER PVC (SDR 26) AT 1.00% MIN. SLOPE UNLESS OTHERWISE LABELED.
- WASTEWATER CLEANOUT COVERS SHALL BE RATED FOR TRAFFIC LOAD BEARING.
- MANHOLES WHICH ARE NOT INSTALLED UNDER PAVEMENT SHALL HAVE A RIM ELEVATION AT LEAST 6" ABOVE FINISHED GRADE, AND A 10:1 SLOPE TO FINISHED GRADE.
- UNLESS OTHERWISE NOTED ON THE PLANS, THE FINISHED FLOOR ELEVATIONS OF BUILDINGS SHALL BE A MINIMUM OF 6" ABOVE THE LOWEST UPSTREAM MANHOLE TOP. IF THIS IS INFEASIBLE, A WASTEWATER SERVICE LATERAL BACKWATER VALVE (BWV) IS REQUIRED ON THE CUSTOMER SIDE OF THE CLEANOUT.
- WHEN A POTABLE OR RECLAIMED WATER MAIN, OR A WASTEWATER FORCE MAIN IS ROUTED WITHIN 10 FT. OF AN ELECTRIC TRANSFORMER, A 20 FT. LENGTH OF DIP SHALL BE CENTERED ON THE TRANSFORMER WITH MECHANICAL RESTRAINT AT EACH END. NO FITTINGS OR VALVES SHALL OCCUR WITHIN 10 FT. OF THE NEAREST EDGE OF THE TRANSFORMER. A MINIMUM CLEARANCE OF 3" SHALL BE MAINTAINED BETWEEN THE MAIN AND THE TRANSFORMER.
- CALL 811 BEFORE DIGGING.
- OWNER'S CONTRACTOR SHALL CALL 811 TO LOCATE, PROTECT AND MAINTAIN 36" MIN. COVER OVER THE EXISTING GAS MAINS & GAS SERVICE DURING ALL PHASES OF DEMOLITION/CONSTRUCTION. THE DEVELOPER WILL BE RESPONSIBLE FOR THE COST OF THE GAS MAIN RELOCATION.
- OWNER'S CONTRACTOR WILL MAINTAIN A MIN. 12" ALL-CLEAR ZONE AROUND GAS MAINS AND SERVICES.
- PVC GAS CASINGS FURNISHED AND INSTALLED BY DEVELOPER'S CONTRACTOR BURIED AT A MIN. DEPTH OF 36" BELOW FINISHED GRADE.
- DEVELOPER'S CONTRACTOR SHALL CONTACT VANESSA ARAGON, PH# (352) 393-1466, 21 DAYS PRIOR TO THE START OF CONSTRUCTION.
- DEVELOPER'S CONTRACTOR SHALL CONTACT VANESSA ARAGON, GRU GAS MARKETING, PH# (352) 393-1466, 5 DAYS PRIOR TO THE INSTALLATION OF GAS CASINGS, AND TO REQUEST GAS LOCATOR BALLS.
- DEVELOPER'S CONTRACTOR SHALL CONTACT VANESSA ARAGON, GRU GAS MARKETING, PH# (352) 393-1466, 7 DAYS IN ADVANCE TO COORDINATE FOR THE GAS METER SET.
- CONTRACTOR TO CUT AND CAP UNUSED SEWER LATERALS AT PROPERTY LINE. GRU TO LINE SEWER MAIN (LINING OVER EXISTING LATERALS) AT DEVELOPERS EXPENSE. CONTRACTOR TO CUT IN NEW LATERALS.

LANDS DESCRIBED IN O.R.B. 1994, PG. 352, (TAX PARCEL #04344-006-000) OWNER: GAFFNEY VERA A (TAX PARCEL #04344-006-000)

LANDS DESCRIBED IN O.R.B. 2217, PG. 785 (TAX PARCEL #04344-004-000) OWNER: GAFFNEY VERA A (TAX PARCEL #04344-004-000)

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 DATE: 23/2023 4:37pm  
 PLOT DATE: 23/2023 4:37pm

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SCALE: 1"=20'  
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 SCALES ACCORDINGLY.

CONSTRUCTION DIVISION

SUBMITTALS:  
 6/5/23 - SUBMITTAL TO ALACHUA COUNTY, GRU, FOOT, AND SWMM  
 7/31/23 - SUBMITTAL TO ALACHUA COUNTY, GRU, FOOT, AND SWMM  
 10/10/23 - SUBMITTAL TO GRU & FDOT  
 10/23/23 - BID SET


CLIENT: FLETCHER DEVELOPMENT  
 PROJECT: FLETCHER CENTER EAST  
 SHEET TITLE: DETAILED UTILITY PLAN

TECHNICIAN: G. WADZINSKI  
 DESIGNER: G. LEDFORD, E.I.  
 QUALITY CONTROL: D. YOUNG, P.E.  
 PROJECT NUMBER: 21-0571


DANIEL H. YOUNG  
 Daniel H. Young, P.E.  
 State of Florida, Professional  
 Engineer, License No. 78780  
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 H. Young, P.E., on the date  
 indicated here: 10/20/2023  
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FL PE No. 70780  
 SHEET NO. **C3.10**



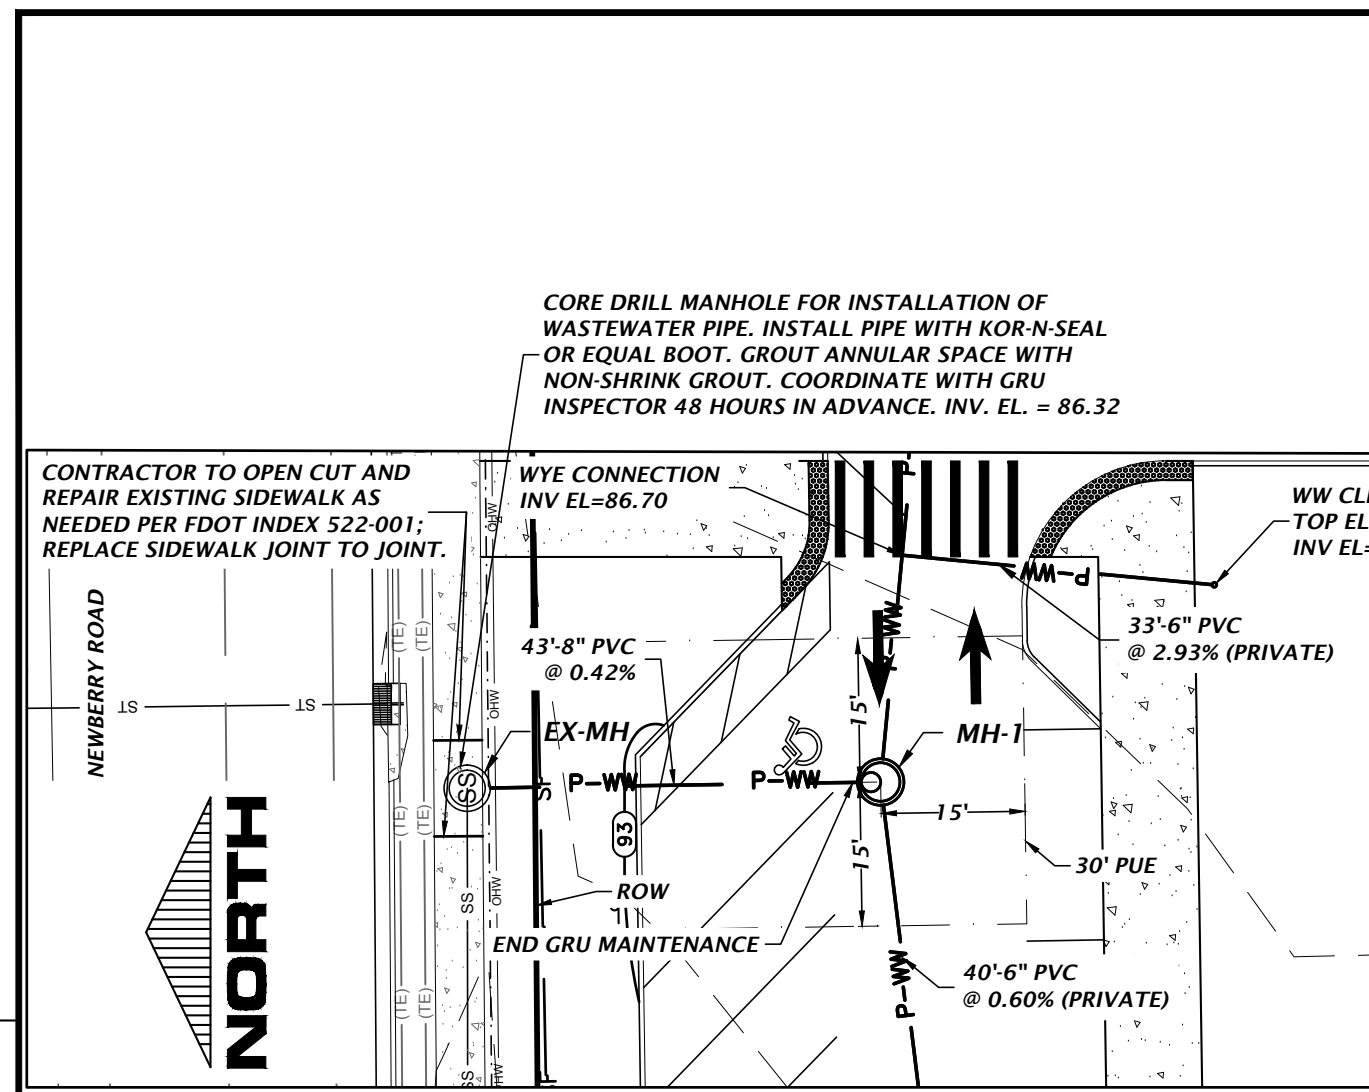


VIEW 1


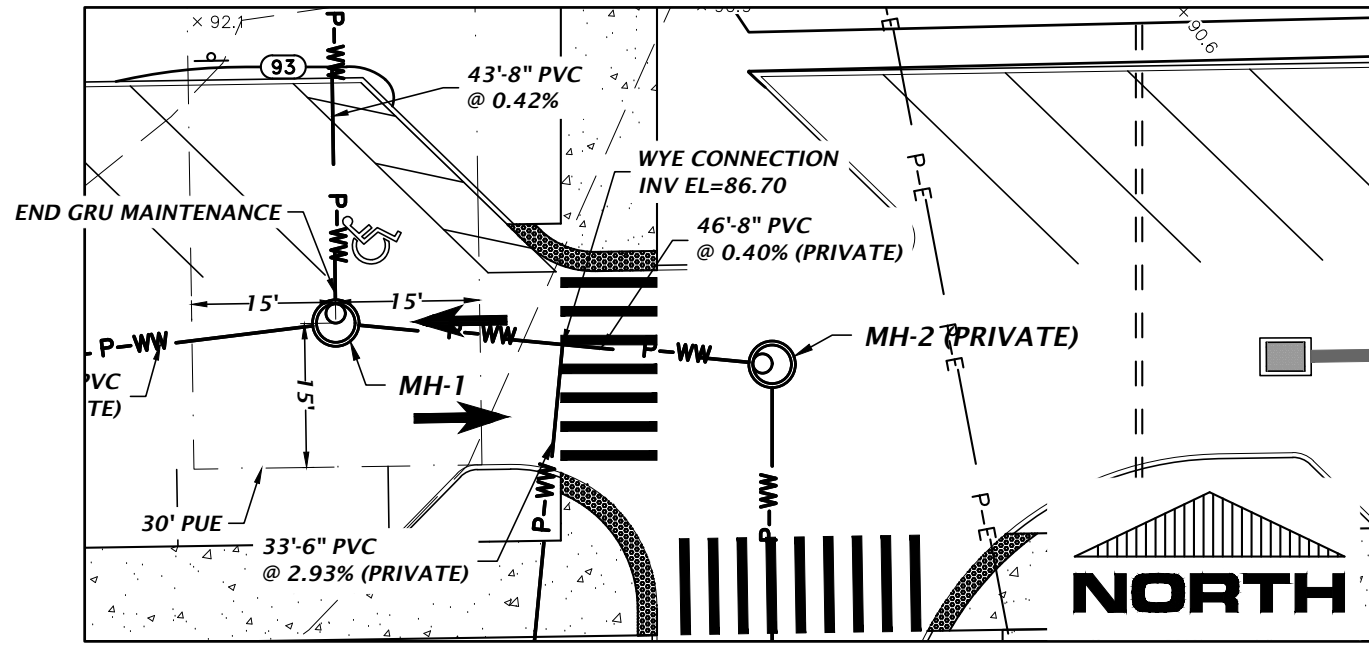


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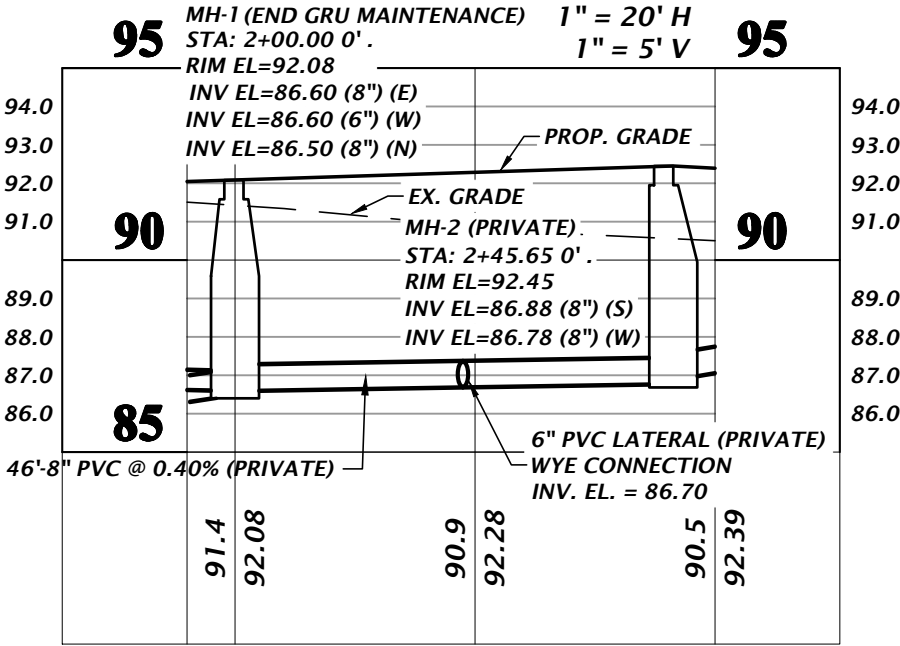
PLAN VIEW  
SCALE: 1" = 20'

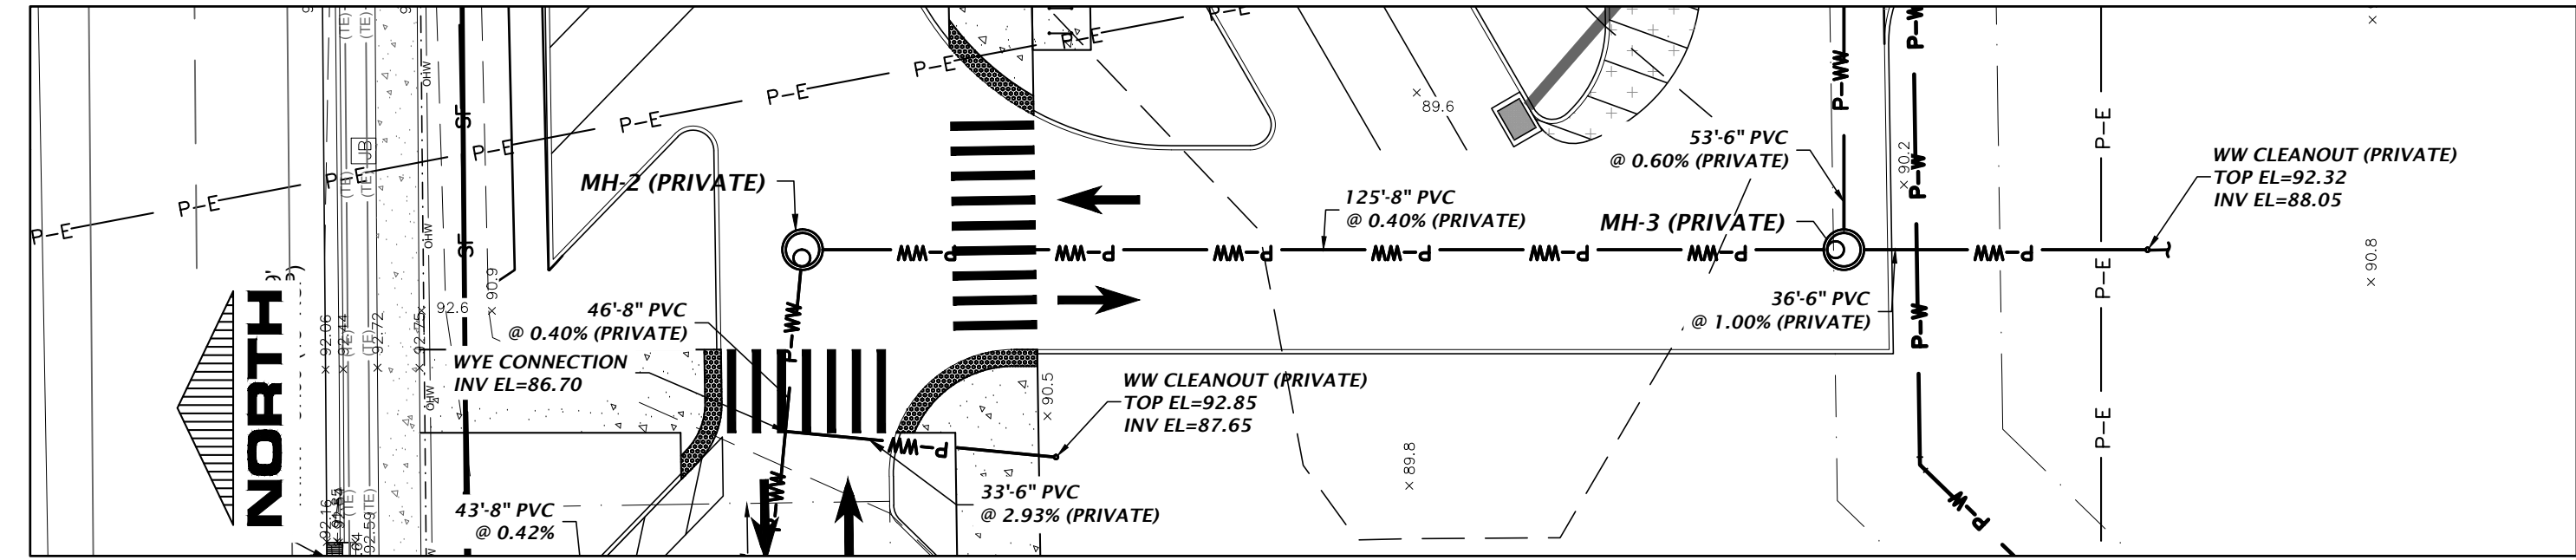

VIEW 3

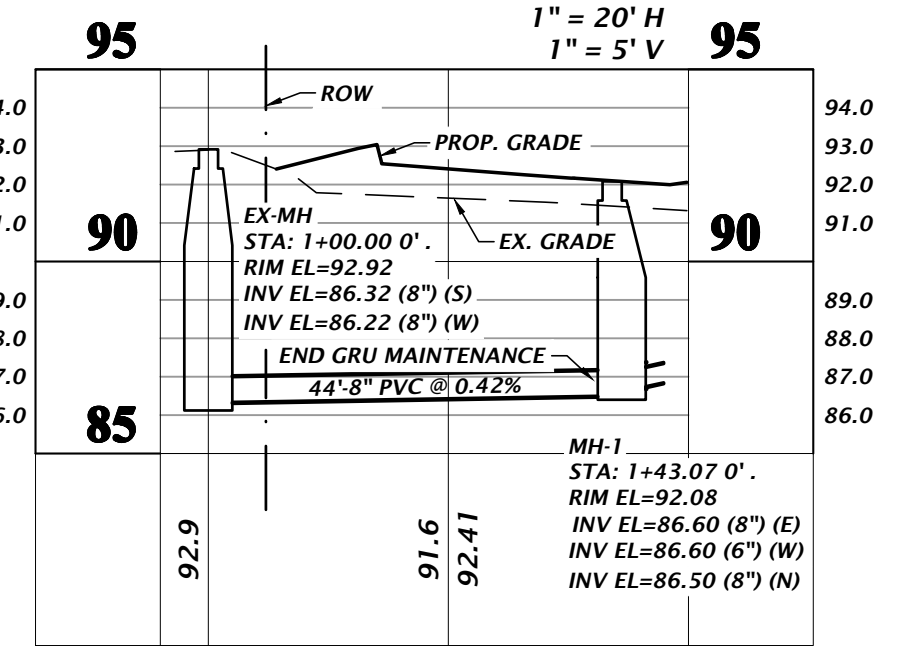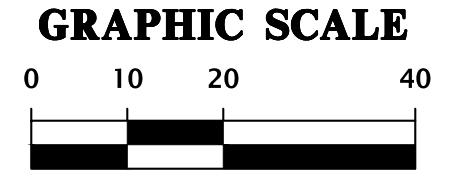


VIEW 1




VIEW 2

PROFILE VIEW  
HORIZ. SCALE: 1" = 20'  
VERT. SCALE: 1" = 5'

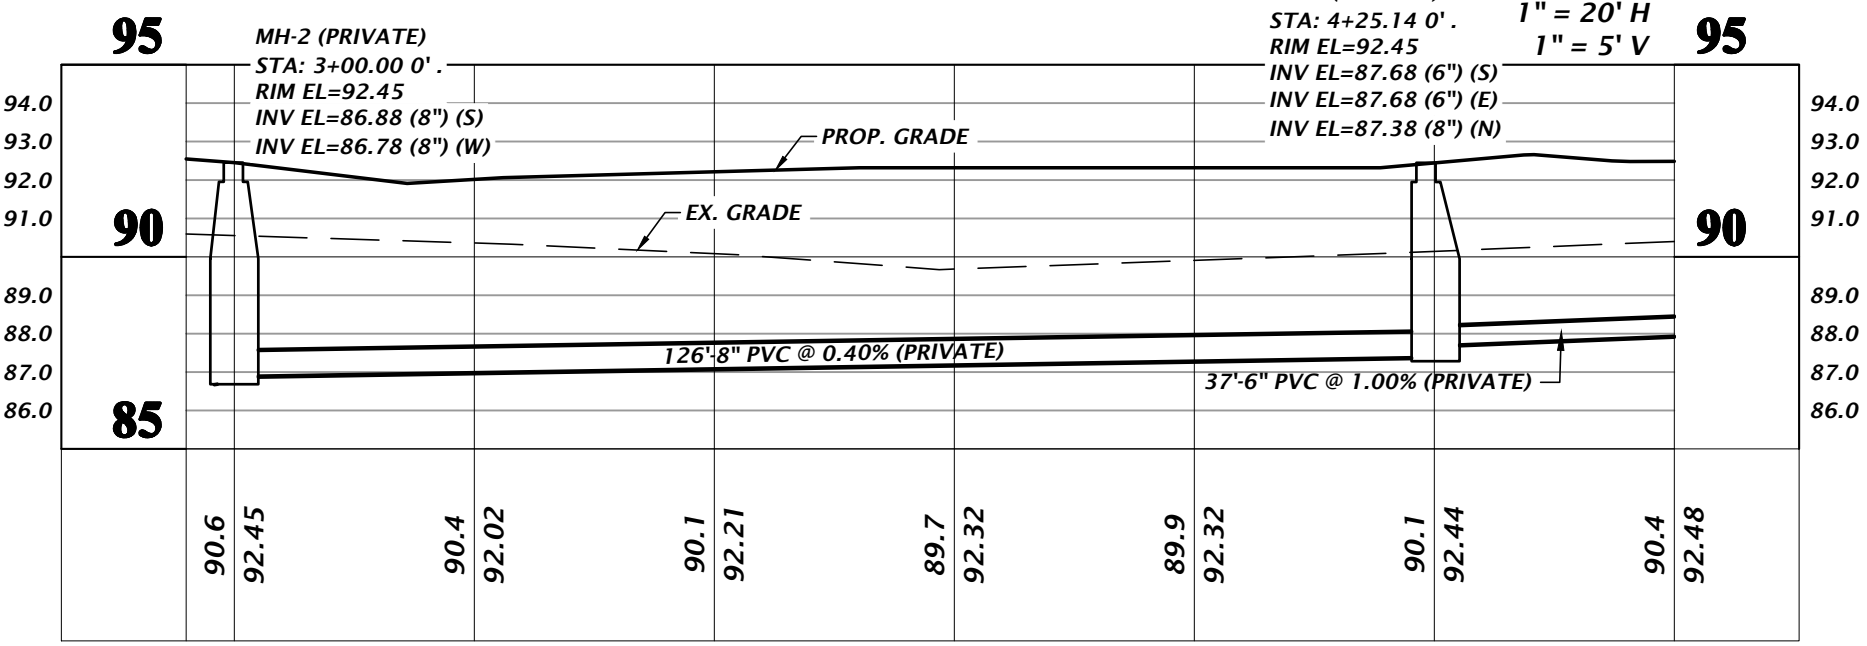

VIEW 3

SANITARY SEWER STRUCTURE TABLE				
STRUCTURE NAME:	STRUCTURE TYPE	TOP	INVERT ELEV	NORTHING & EASTING
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KEY MAP  
NTS

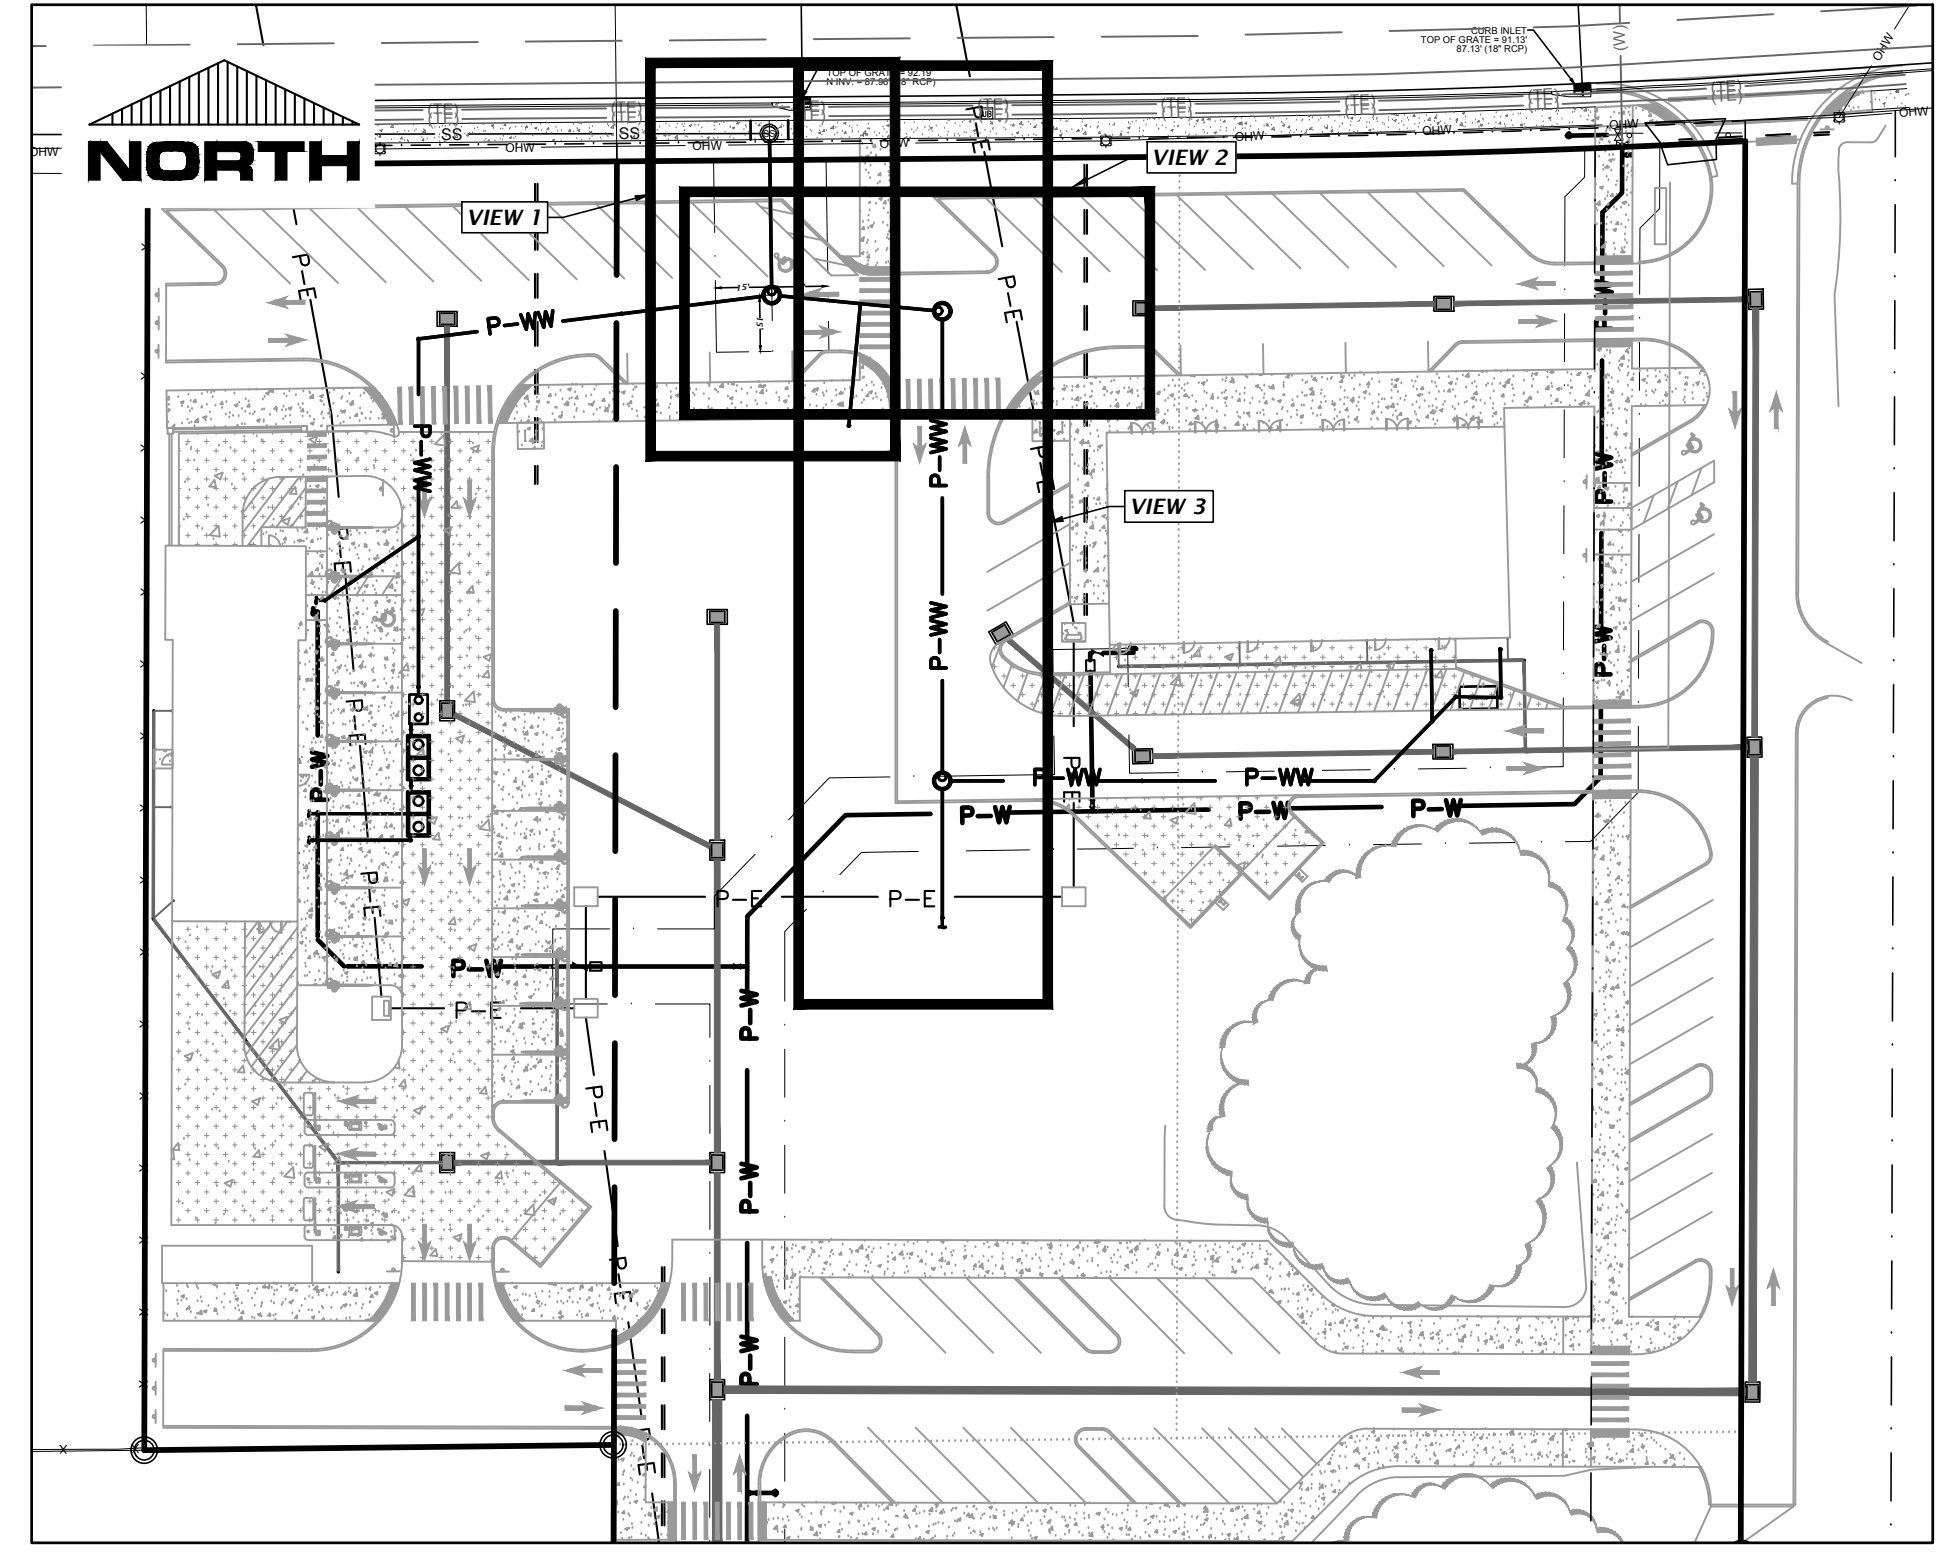Title: gwpw For Date: Oct 23, 2023 4:38pm Filename: N:\2023\11-0571\Department\CA\_Engineering\02\_DWG\Production\Fla\_21-0571\_PP.dwg

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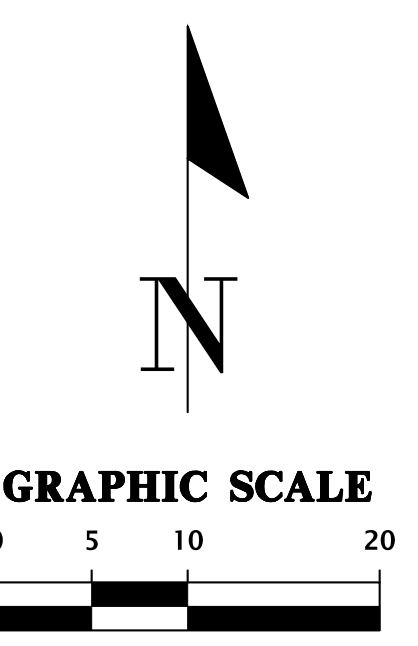
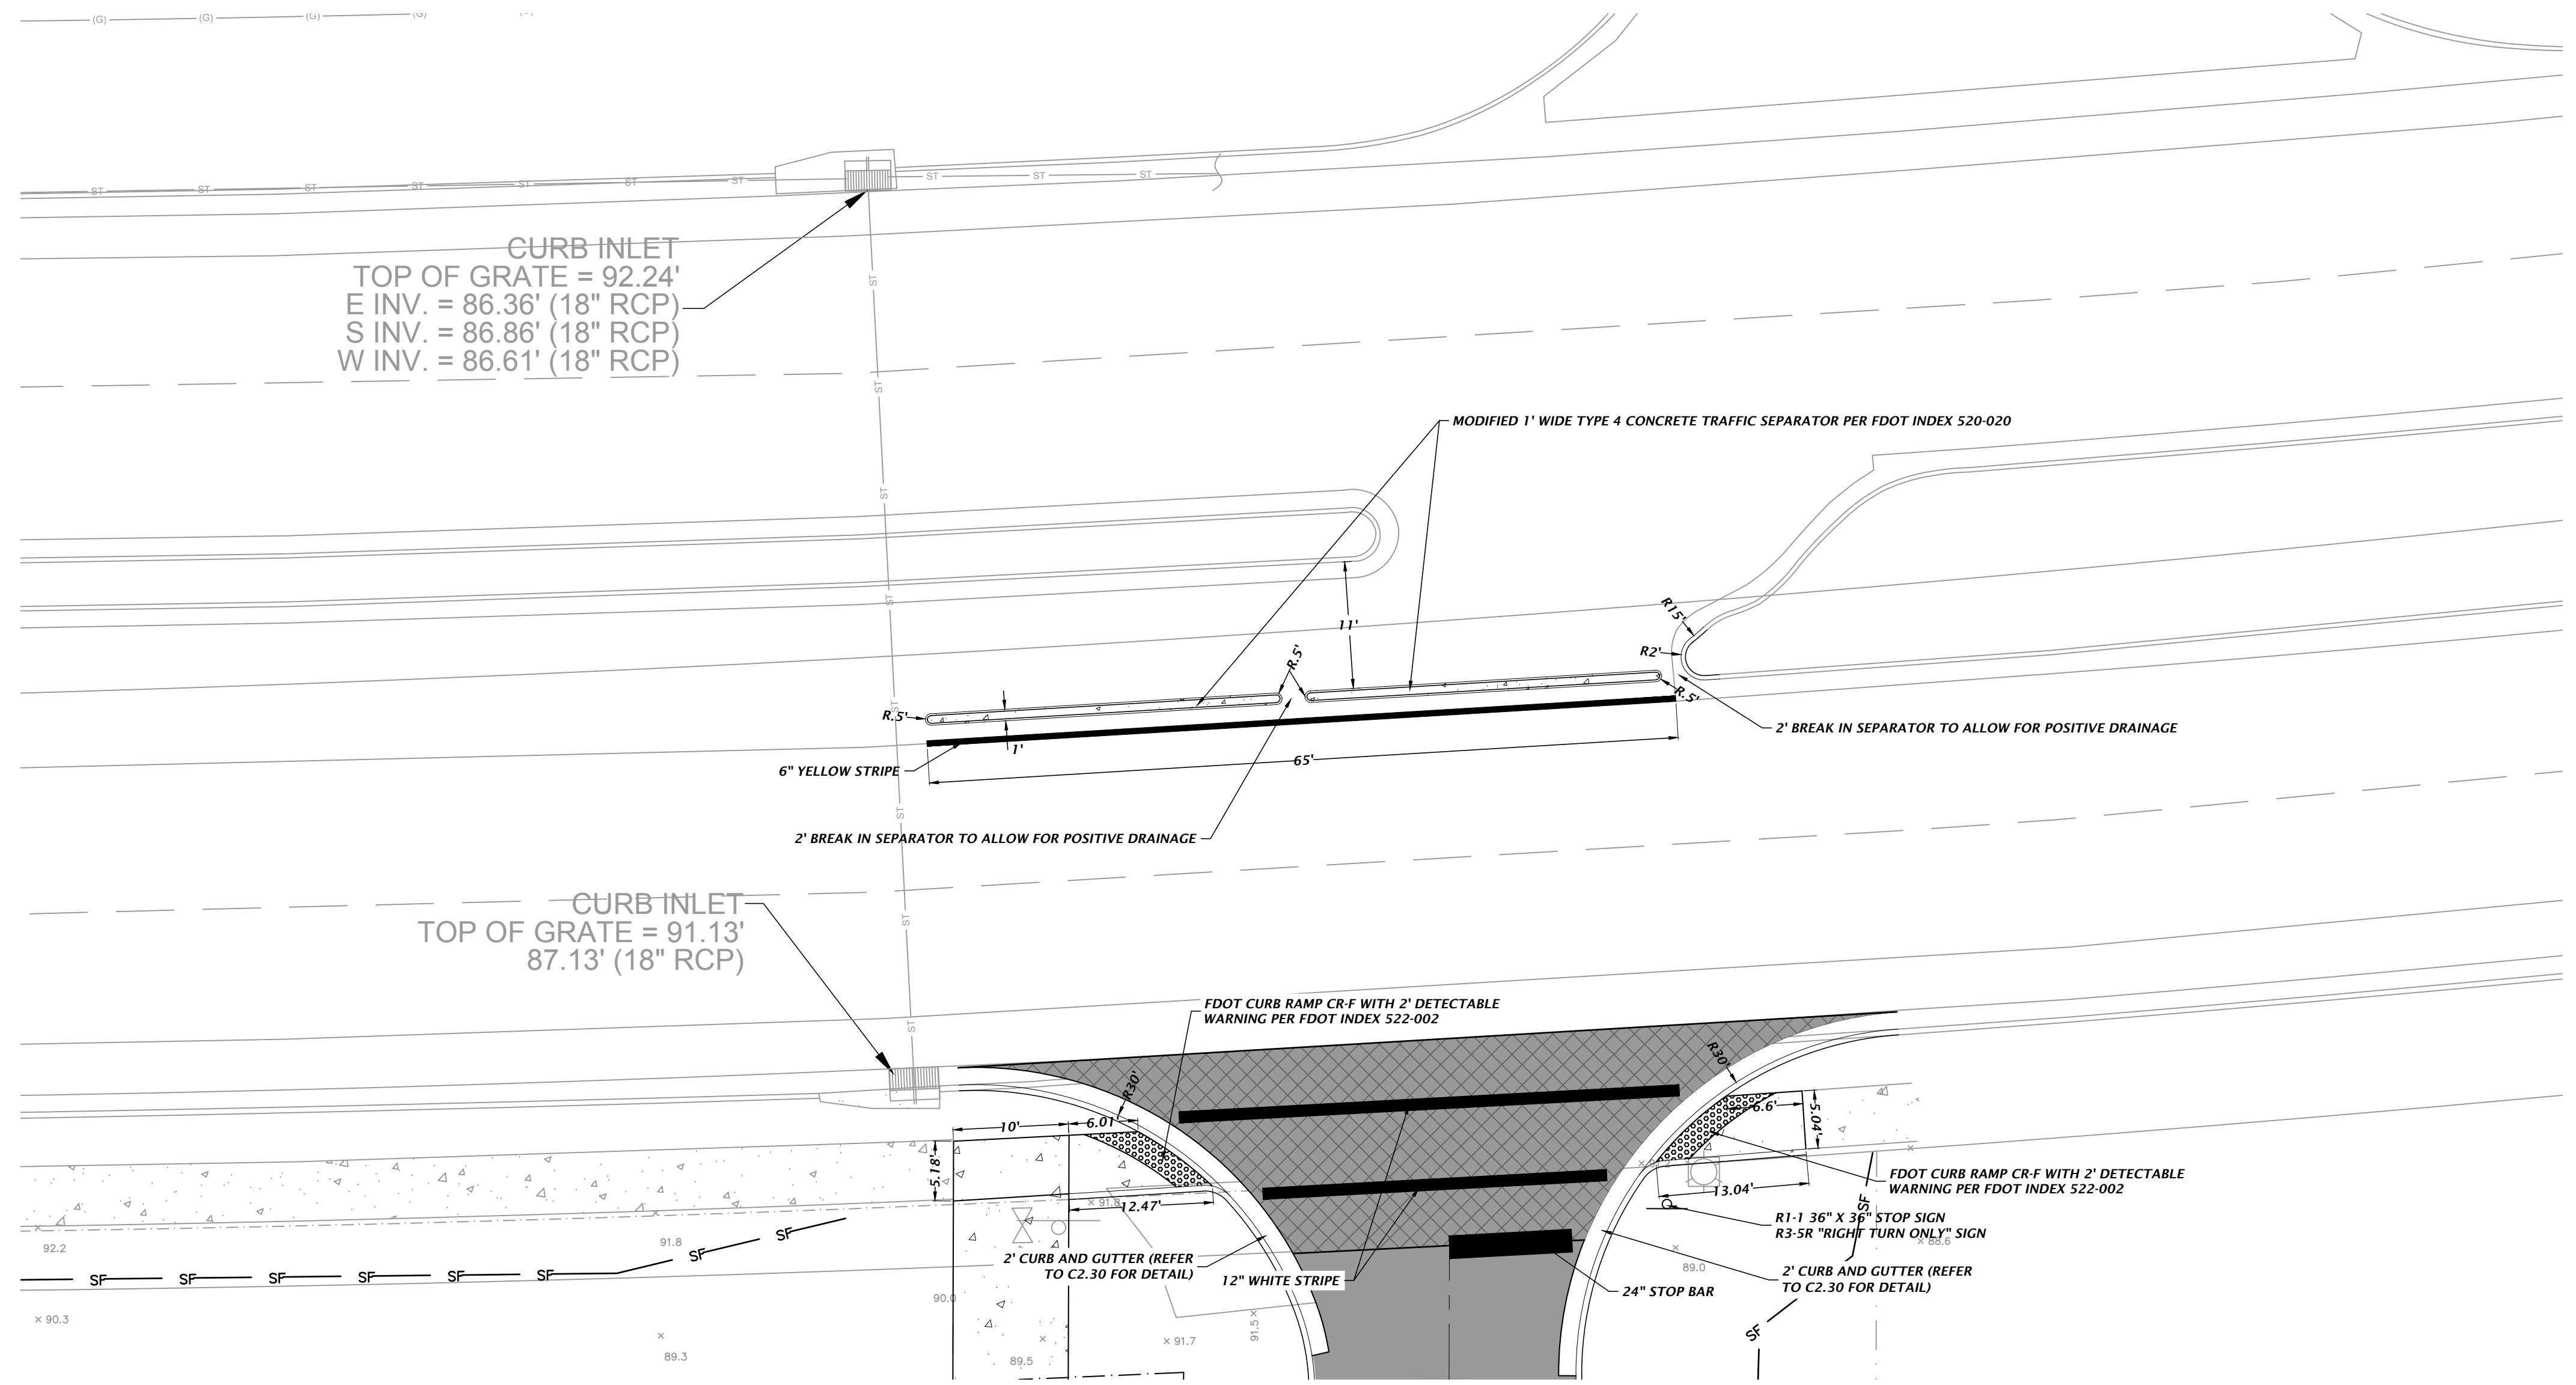
CONSTRUCTION DIVISIONS




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7/31/23 - SUBMITTAL TO ALACHUA COUNTY, GRU, FOOT, AND SKWWD  
10/10/23 - SUBMITTAL TO GRU & FOOT  
10/23/23 - BID SET

CLIENT: FLETCHER DEVELOPMENT  
PROJECT: FLETCHER CENTER EAST  
SHEET TITLE: SEWER PLAN AND PROFILE  
TECHNICIAN: G. WADZINSKI  
DESIGNER: G. LEDFORD, E.I.  
QUALITY CONTROL: D. YOUNG, P.E.  
PROJECT NUMBER: 21-0571  
DANIEL H. YOUNG  
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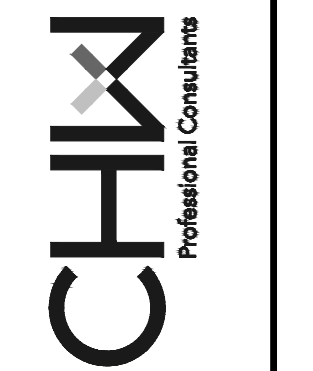


-  = CONCRETE SIDEWALK (REFER TO C2.30 FOR DETAIL)
-  = HEAVY DUTY ASPHALT PAVEMENT (REFER TO C2.30 FOR DETAIL)
-  = FDOT ROW ASPHALT PAVEMENT (REFER TO C2.30 FOR DETAIL)

**NOTES:**  
 1) SEE SURVEY FOR BENCHMARK ELEVATIONS, LOCATIONS, AND DESCRIPTIONS.  
 2) CONTRACTOR SHALL REPAIR/RESTORE ANY DISTURBED AREAS TO EXISTING CONDITIONS OR BETTER.

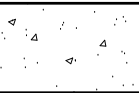FOR COORDINATION REFERENCE, REFER TO C1.00.

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 10/23/23 - BID SET

CLIENT: FLETCHER DEVELOPMENT  
 PROJECT: FLETCHER CENTER EAST  
 SHEET TITLE: PUBLIC ROADWAY IMPROVEMENTS

DESIGNER: G. LEDWOLD, E.I.  
 QUALITY CONTROL: D. YOUNG, P.E.  
 PROJECT NUMBER: 21-0571

Daniel H. Young, P.E.  
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 SHEET NO.: C4.10

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